APPENDIX 25

SDP AND LINEAR LAYOUT WITH COORDINATES

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PHASE 1 AIRSIDE PRECINCT	5
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EXISTING SITE PLAN

O 62.5 m 125.0 m 250.0 m

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**MARKED COVERS TO BE PROVIDED AT GROUND LEVEL FOR i.e's BELOW PAVING

**RESEAL TRAPS TO BE PROVIDED TO ALL WASTE FITTINGS.

**SOIL WATER DRAINS PASSING UNDER BUILDINGS TO BE ENCASED IN 150mm

CONCRETE ALL ROUND AND BE PROVIDED WITH r.e.'s AS CLOSE TO THE BUILDING AS POSSIBLE AT BOTH ENDS. * SOIL WATER PIPES HAVING A VERTICAL DROP EXCEEDING 1200mm TO THE MAIN DRAIN TO BE ANTI-SYPHONED. * ALL BRANCH DRAINS EXCEEDING 6m IN LENGTH TO BE VENTED.

* UPVC PIPES ARE TO BE LAID IN ACCORDANCE WITH THE MANUFACTURERS TECHNICAL

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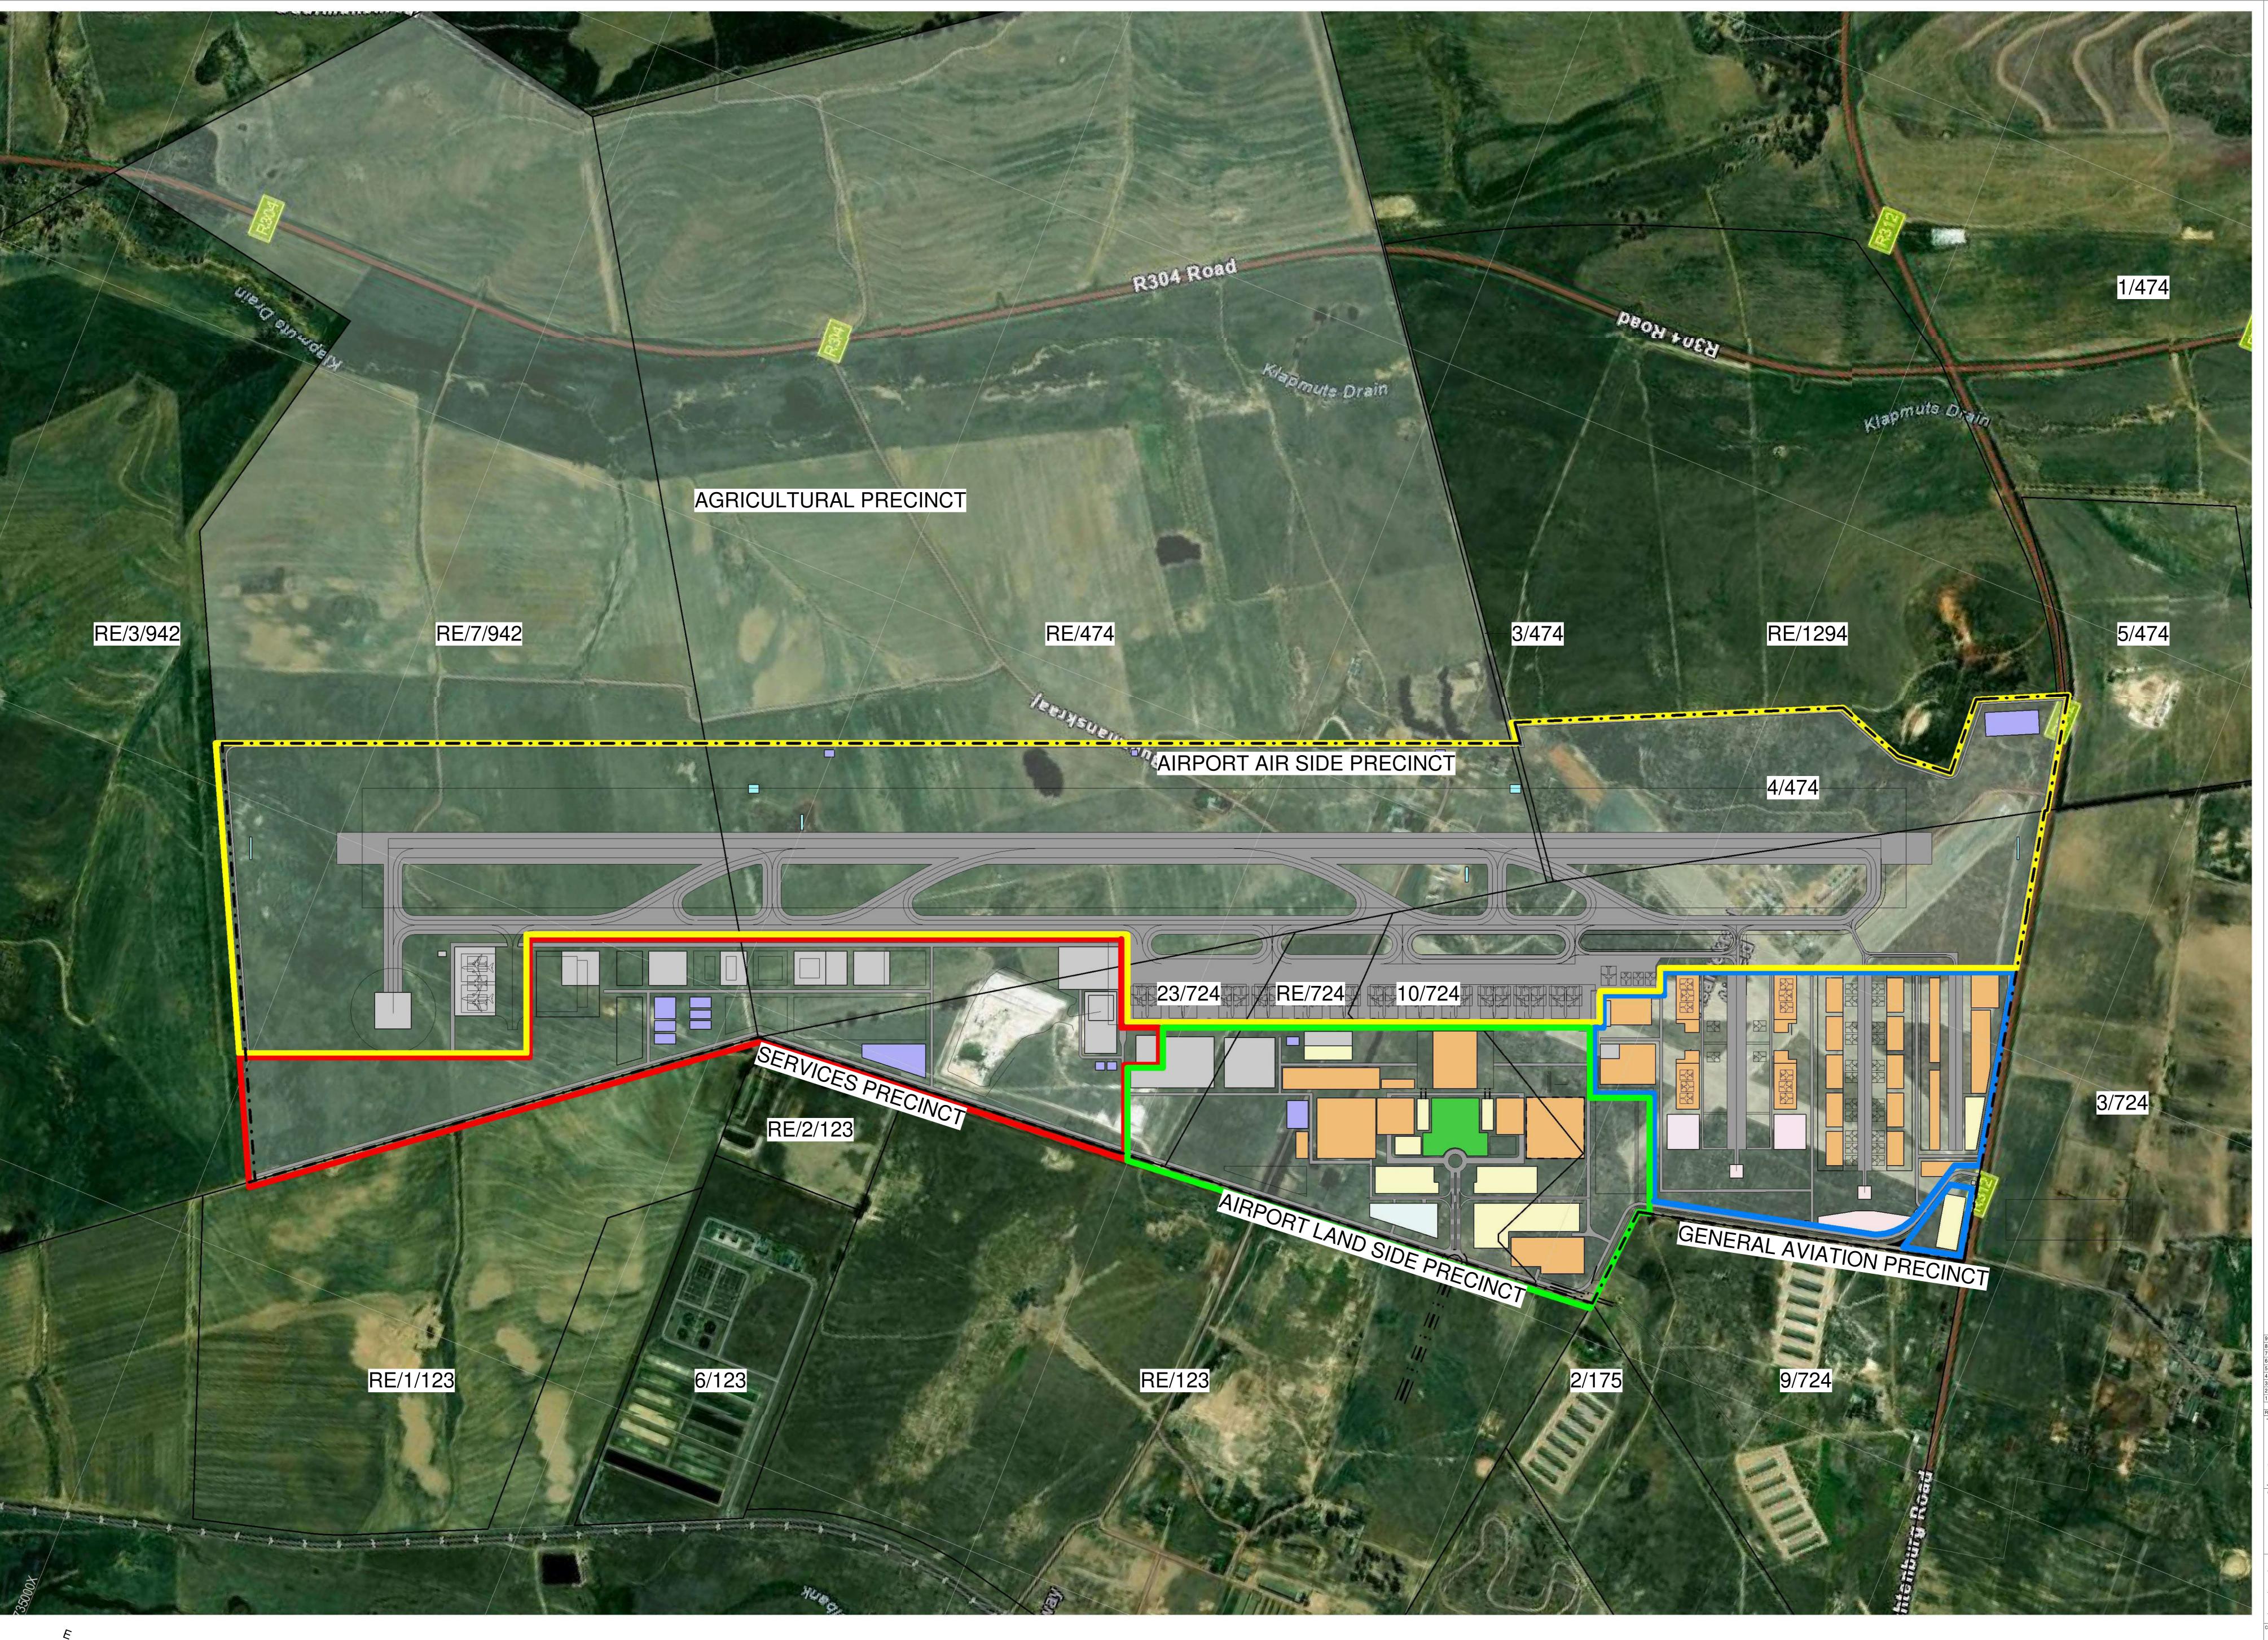
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DATE 2024-05-24 DRAWN BY: CW DENNIS



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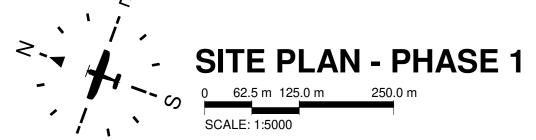
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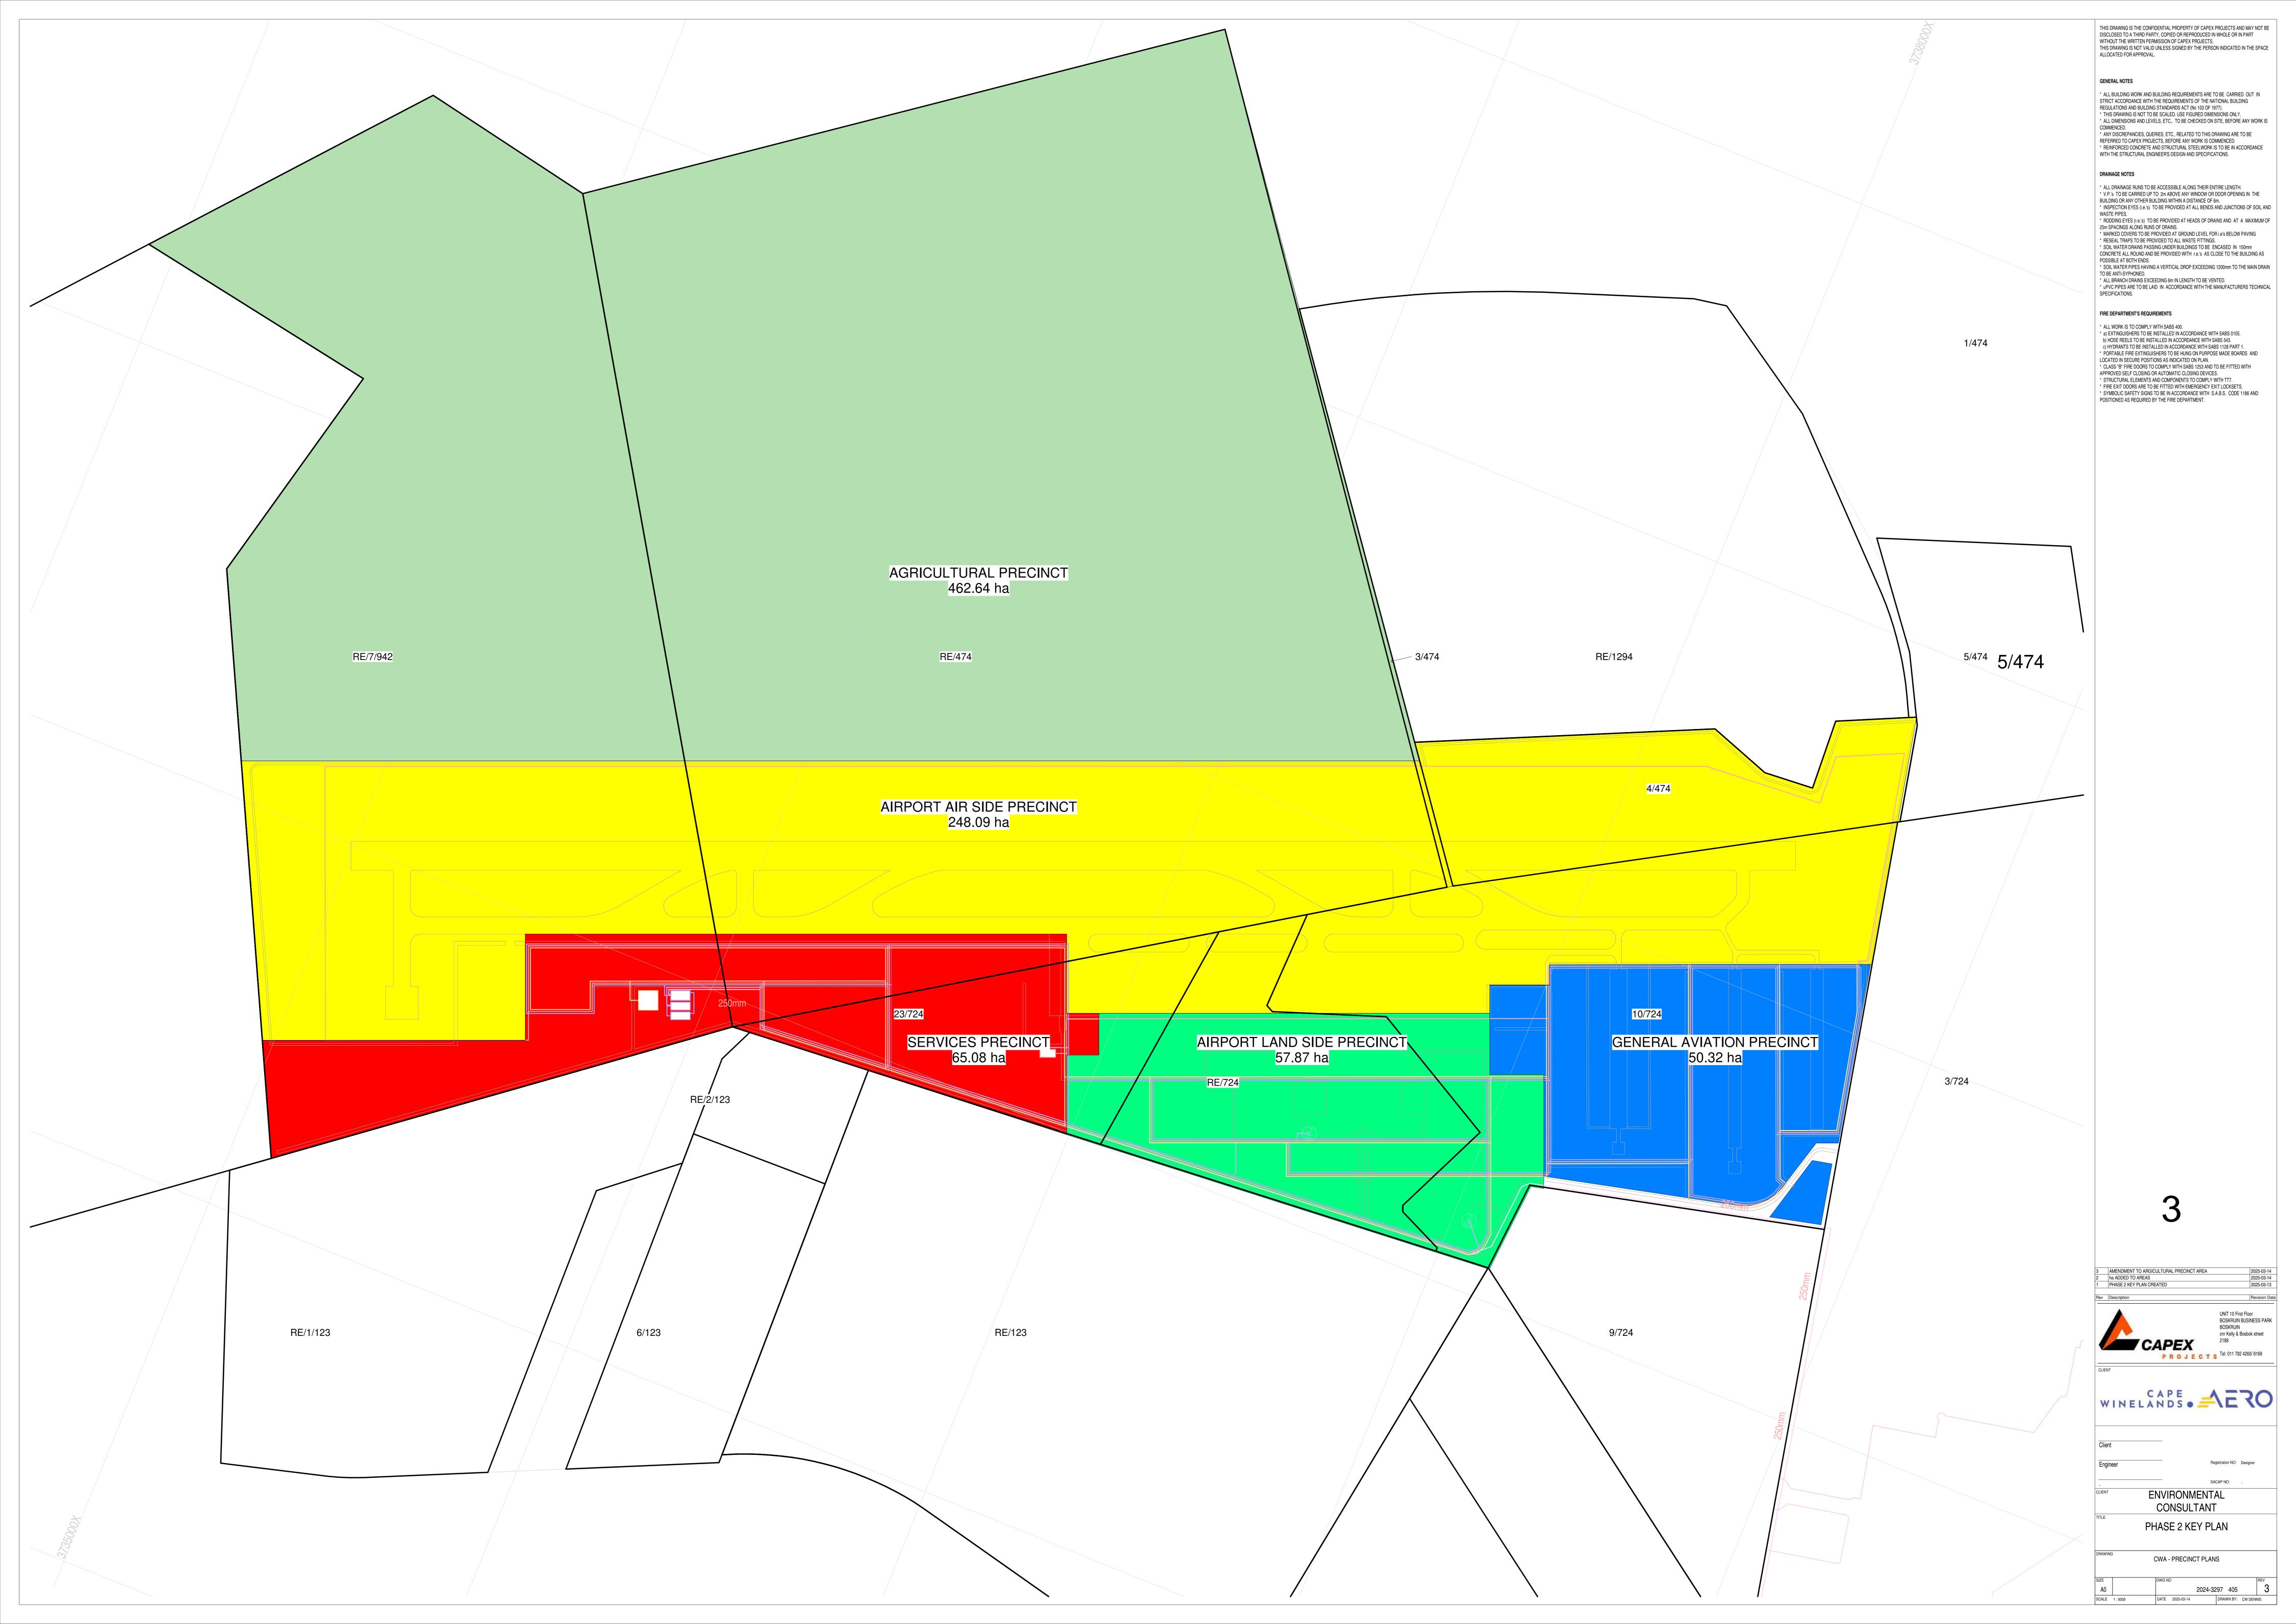
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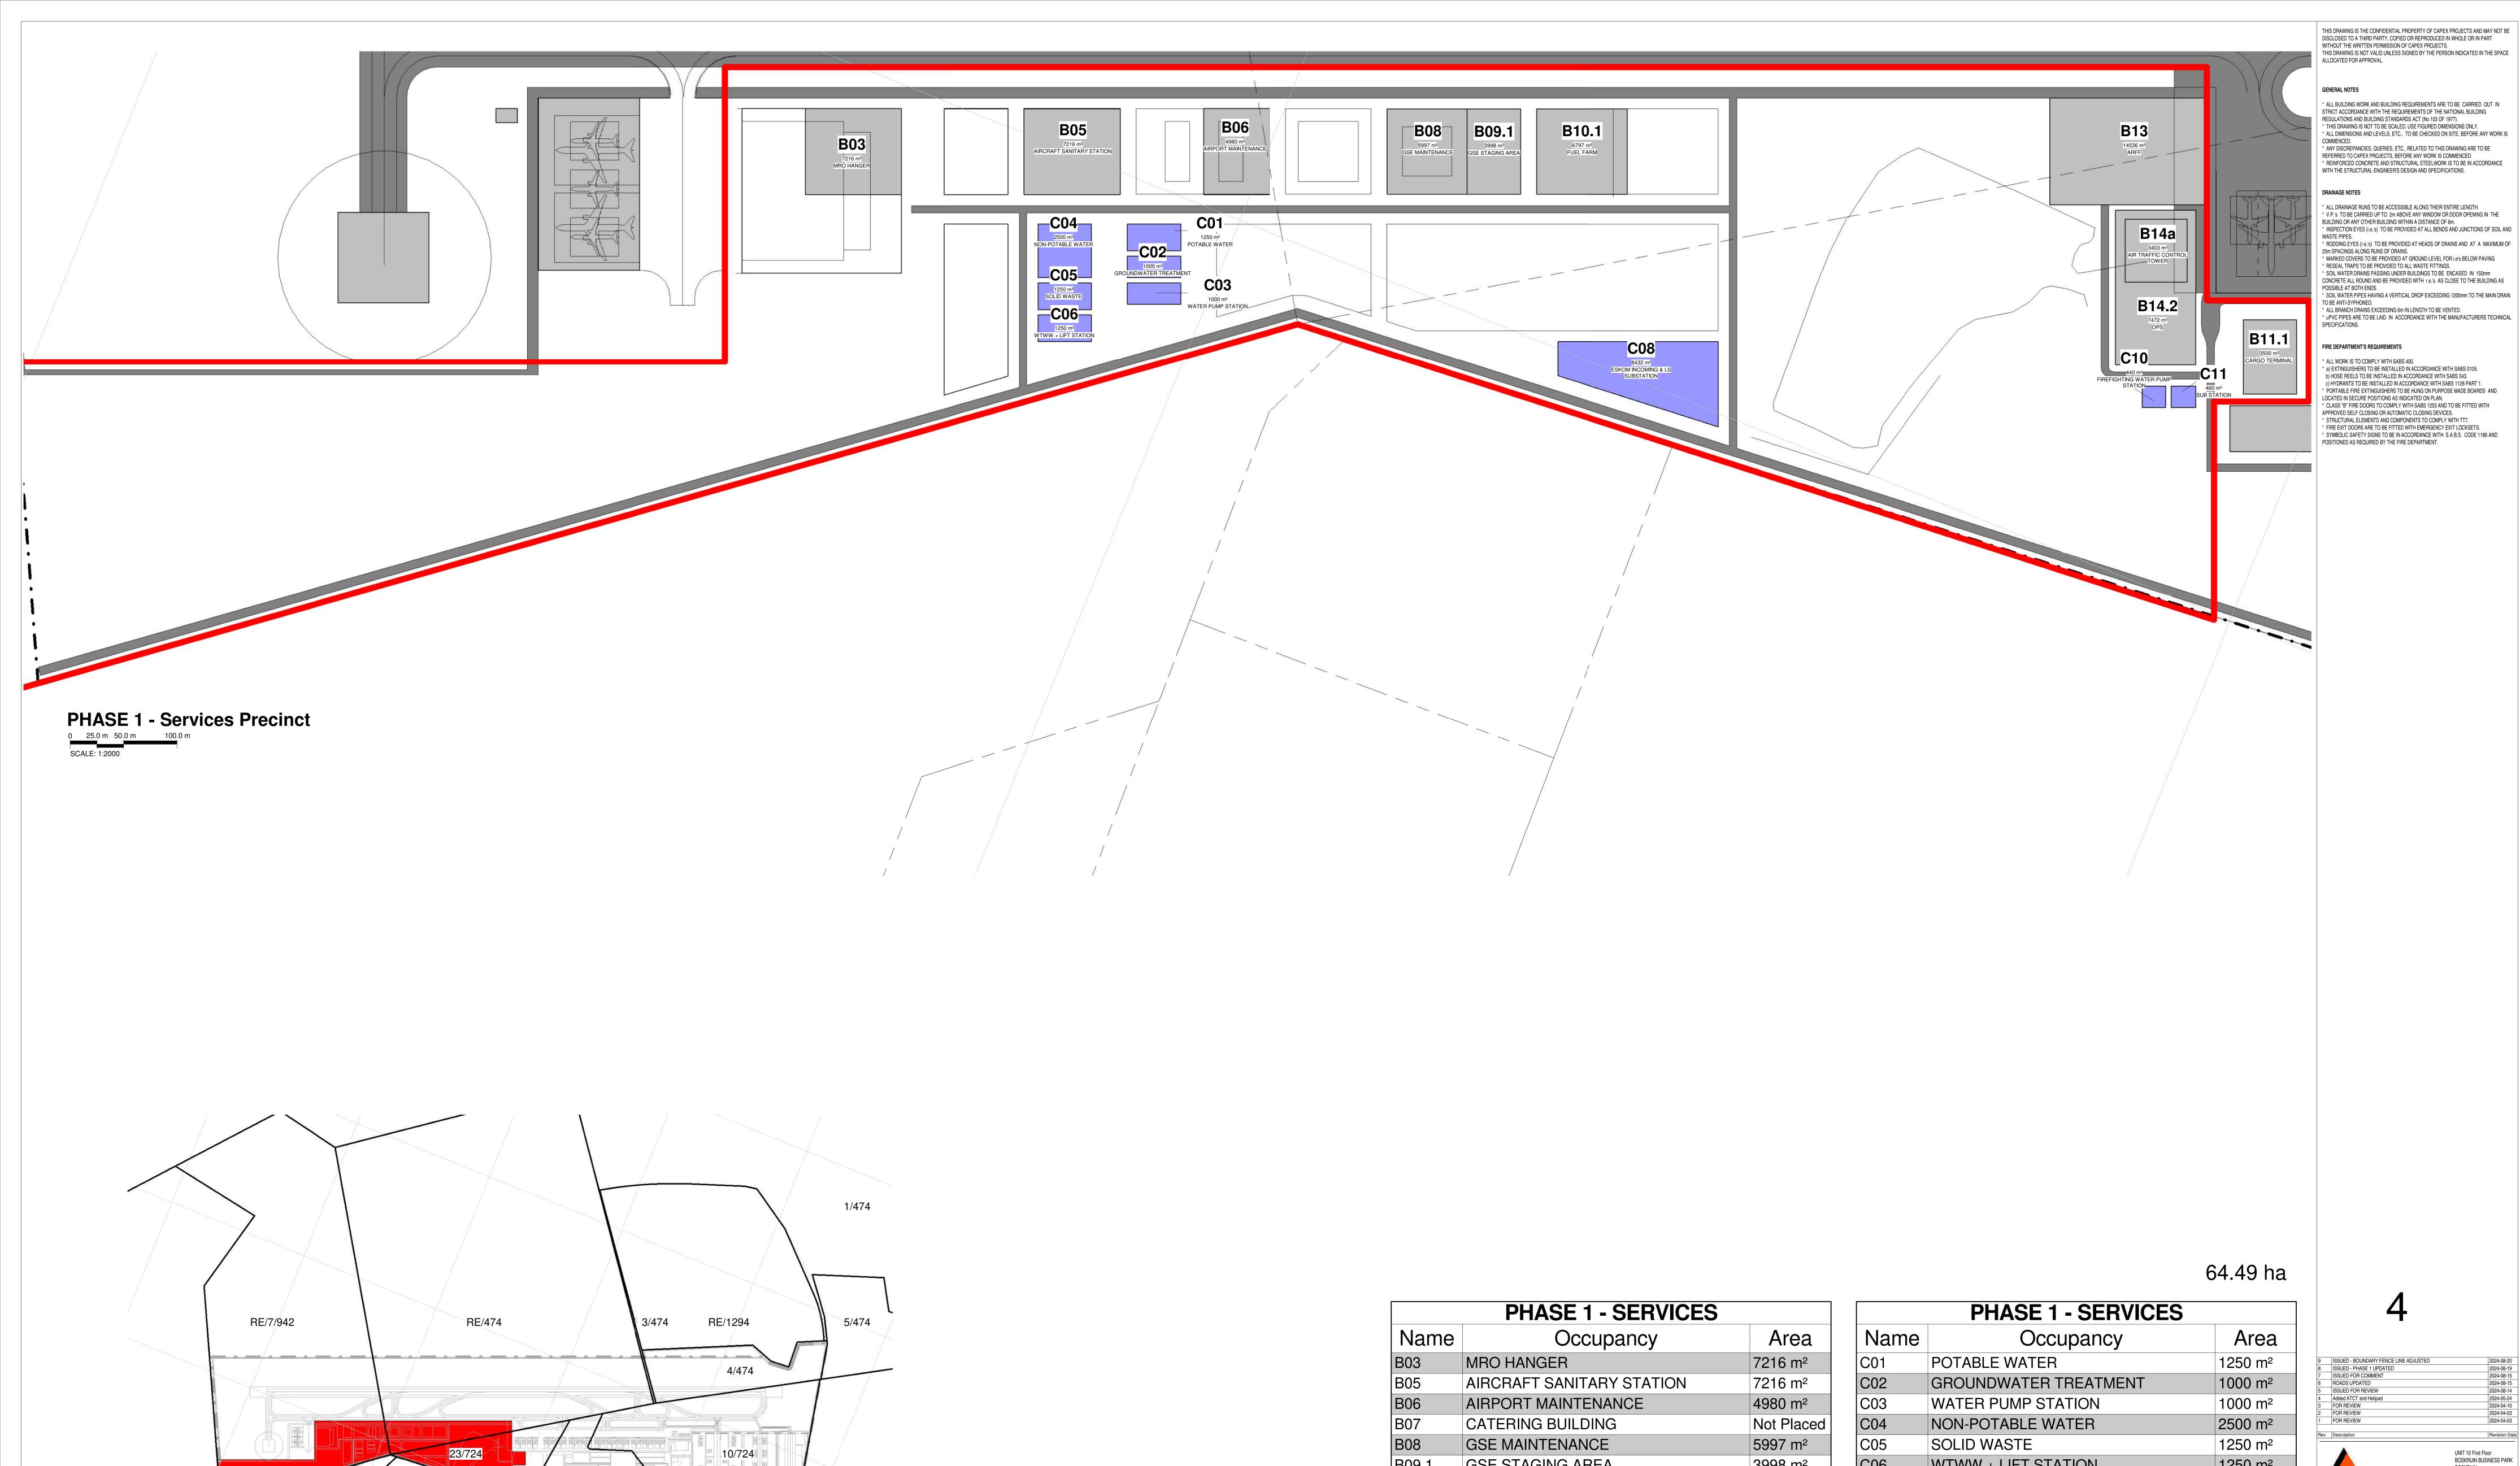


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DATE 2024-08-20 DRAWN BY: CW DENNIS







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RE/2/123

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RE/1/123

Key Plan - PHASE 1 Services Precinct

RE/123


PHASE 1 - SERVICES		
Occupancy	Area	
MRO HANGER	7216 m ²	
AIRCRAFT SANITARY STATION	7216 m ²	
AIRPORT MAINTENANCE	4980 m ²	
CATERING BUILDING	Not Placed	
GSE MAINTENANCE	5997 m ²	
GSE STAGING AREA	3998 m ²	
FUEL FARM	6797 m ²	
FUEL FARM	Not Placed	
CARGO TERMINAL	3500 m ²	
ARFF	14536 m ²	
OPS	7472 m ²	
AIR TRAFFIC CONTROL TOWER	3403 m ²	
SUB STATION	260 m ²	
	Occupancy MRO HANGER AIRCRAFT SANITARY STATION AIRPORT MAINTENANCE CATERING BUILDING GSE MAINTENANCE GSE STAGING AREA FUEL FARM FUEL FARM CARGO TERMINAL ARFF OPS AIR TRAFFIC CONTROL TOWER	

PHASE 1 - SERVICES		
Name	Occupancy	Area
C01	POTABLE WATER	1250 m ²
C02	GROUNDWATER TREATMENT	1000 m ²
C03	WATER PUMP STATION	1000 m ²
C04	NON-POTABLE WATER	2500 m ²
C05	SOLID WASTE	1250 m ²
C06	WTWW + LIFT STATION	1250 m ²
C08	ESKOM INCOMING & LS SUBSTATION	8432 m ²
C10	FIREFIGHTING WATER PUMP STATION	440 m ²
C11	SUB STATION	460 m ²
E04.14	AIRPORT USE	Not Placed
E04.15	AIRPORT USE	Not Placed

MRO	Main
FBO	Fixed
GA	Gene
GSE	Grou
ARFF	Aircra
FATO	Final
WTWP/WTWW	Wast
RDTS	Remo
PAPI	Preci

ntenance Repairs and Operations ed Based Operators eral Aviation ound Support Equipment craft Rescue and Firefighting al Approach and Take-off (Helipad) astewater Treatment Plant / Works mote Digital Control Tower System cision Approach Path Indicator

9	ISSUED - BOUNDARY FENCE LINE ADJUSTED	2024-08-20
8	ISSUED - PHASE 1 UPDATED	2024-08-19
7	ISSUED FOR COMMENT	2024-08-15
6	ROADS UPDATED	2024-08-15
5	ISSUED FOR REVIEW	2024-08-14
4	Added ATCT and Helipad	2024-05-24
3	FOR REVIEW	2024-04-10
2	FOR REVIEW	2024-04-03
1	FOR REVIEW	2024-04-03

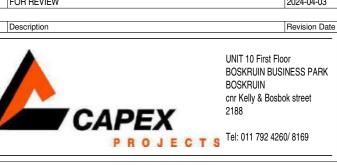




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A0
SCALE As indicated



248.41 ha

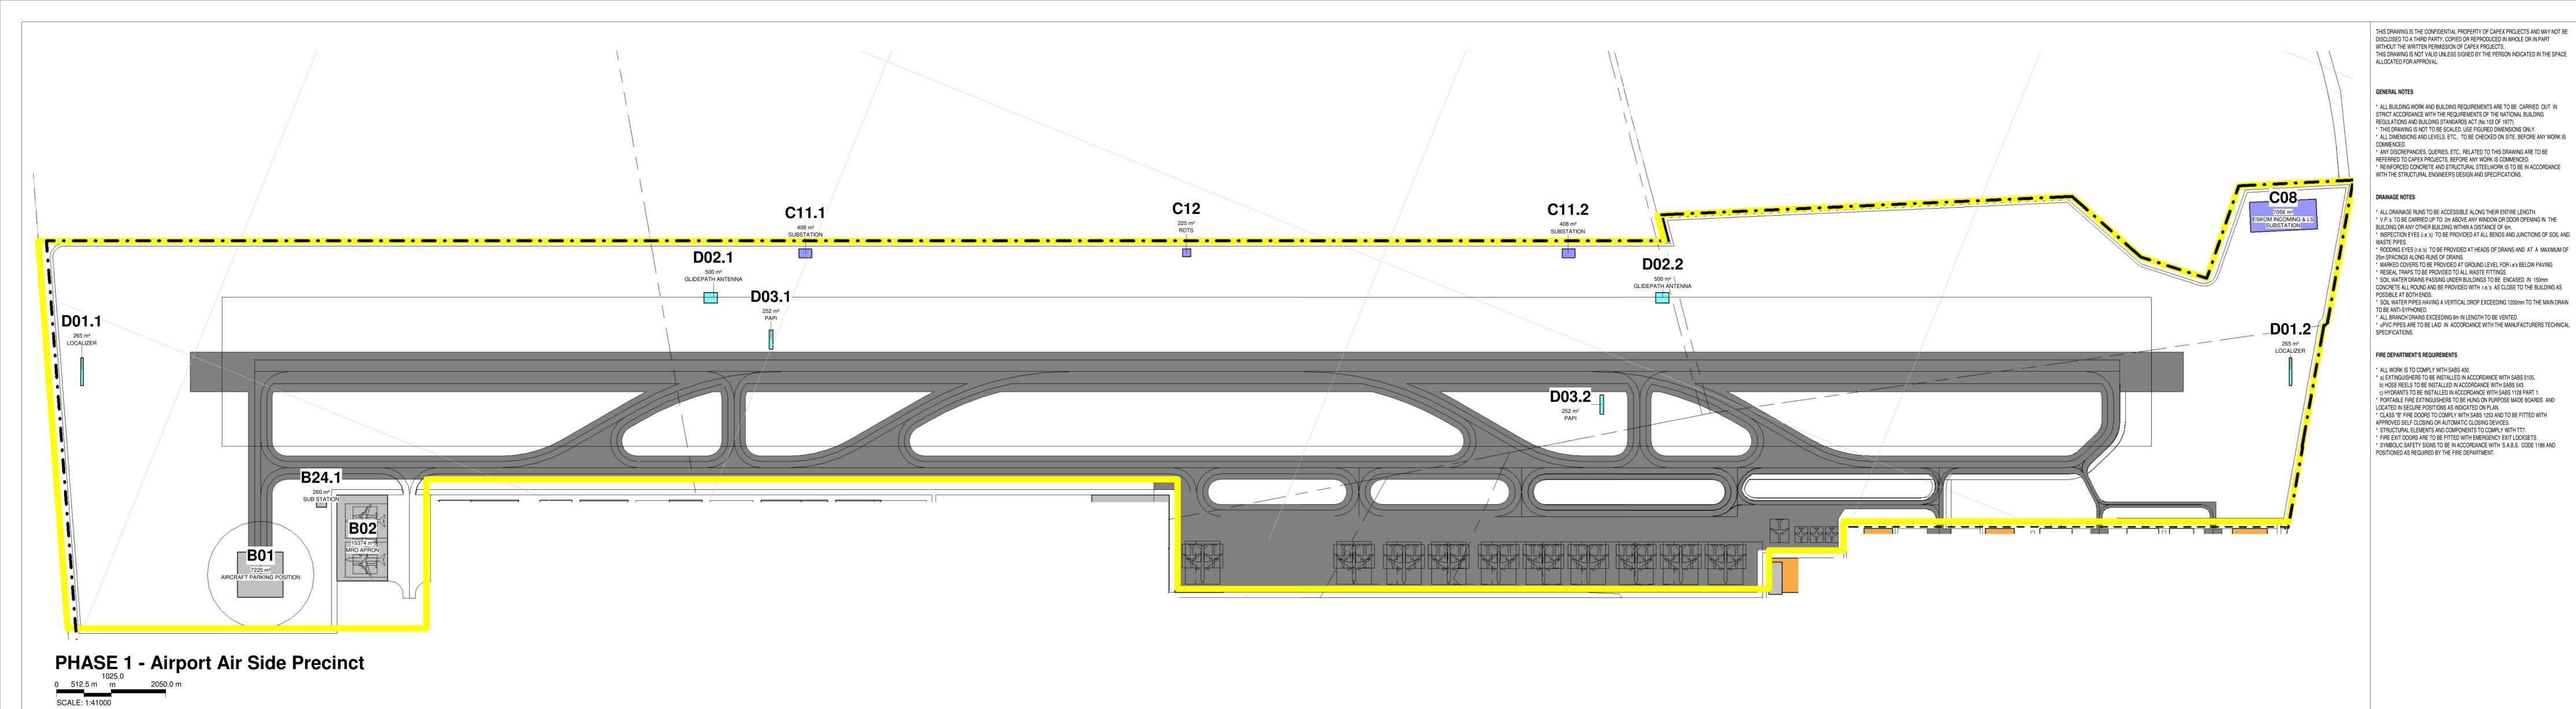	PHASE 1 - AIR SIDE	
Name	Occupancy	Area
B01	AIRCRAFT PARKING POSITION	7225 m ²
B02	MRO APRON	15374 m²
B12	CARGO APRON	Not Placed

MRO	Maintenance Repairs and Operations
FBO	Fixed Based Operators
GA	General Aviation
GSE	Ground Support Equipment
ARFF	Aircraft Rescue and Firefighting
FATO	Final Approach and Take-off (Helipad)
WTWP/WTWW	Wastewater Treatment Plant / Works
RDTS	Remote Digital Control Tower System
PAPI	Precision Approach Path Indicator

Name	Occupancy	Area	
C08	ESKOM INCOMING & LS SUBSTATION	7056 m ²	
C11.1	SUBSTATION	408 m ²	
C11.2	SUBSTATION	408 m ²	
C12	RDTS	225 m ²	
	PHASE 1 - AIR SIDE		
Name	Occupancy	Area	

PHASE 1 - AIR SIDE


PHASE 1 - AIR SIDE		
Name	Occupancy	Area
01.1	LOCALIZER	265 m ²
01.2	LOCALIZER	265 m ²
02.1	GLIDEPATH ANTENNA	500 m ²
02.2	GLIDEPATH ANTENNA	500 m ²
03.1	PAPI	252 m ²
03.2	PAPI	252 m ²


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Rev	Description	Revision Date





DATE 2024-08-20 DRAWN BY: CW DENNIS

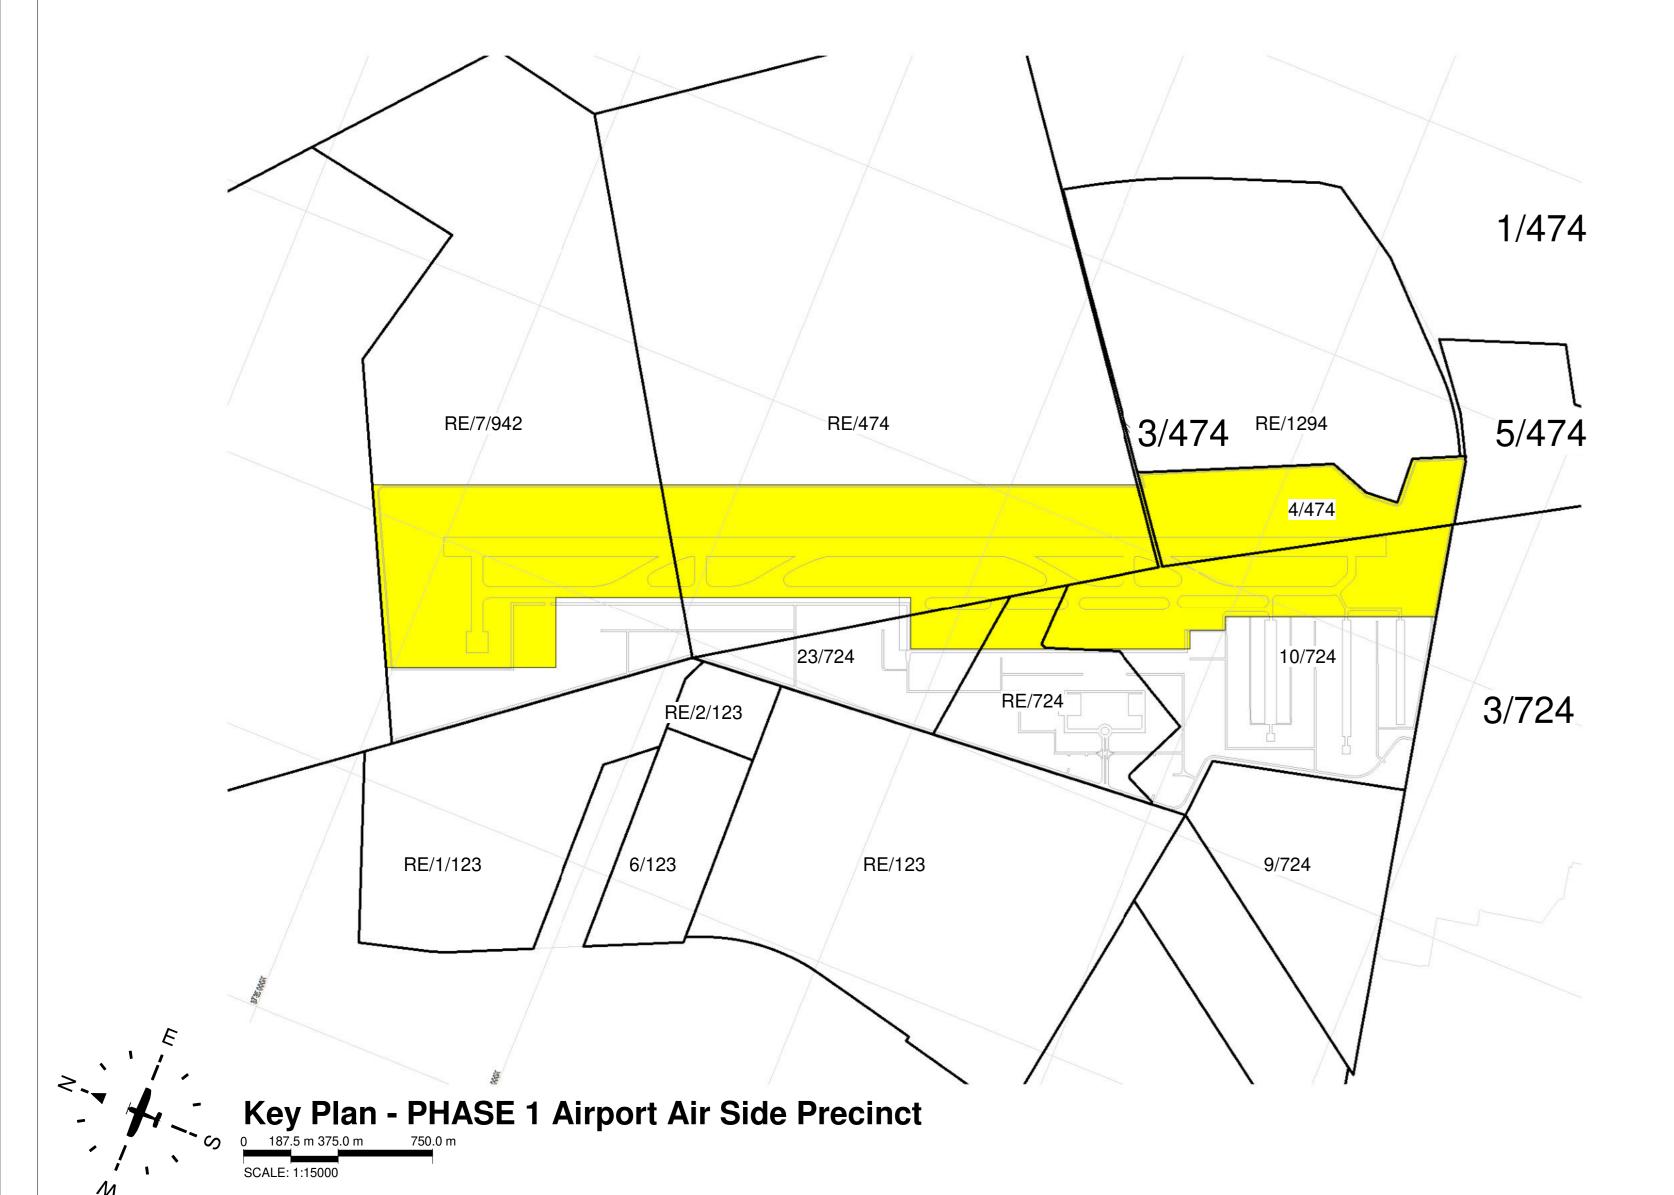

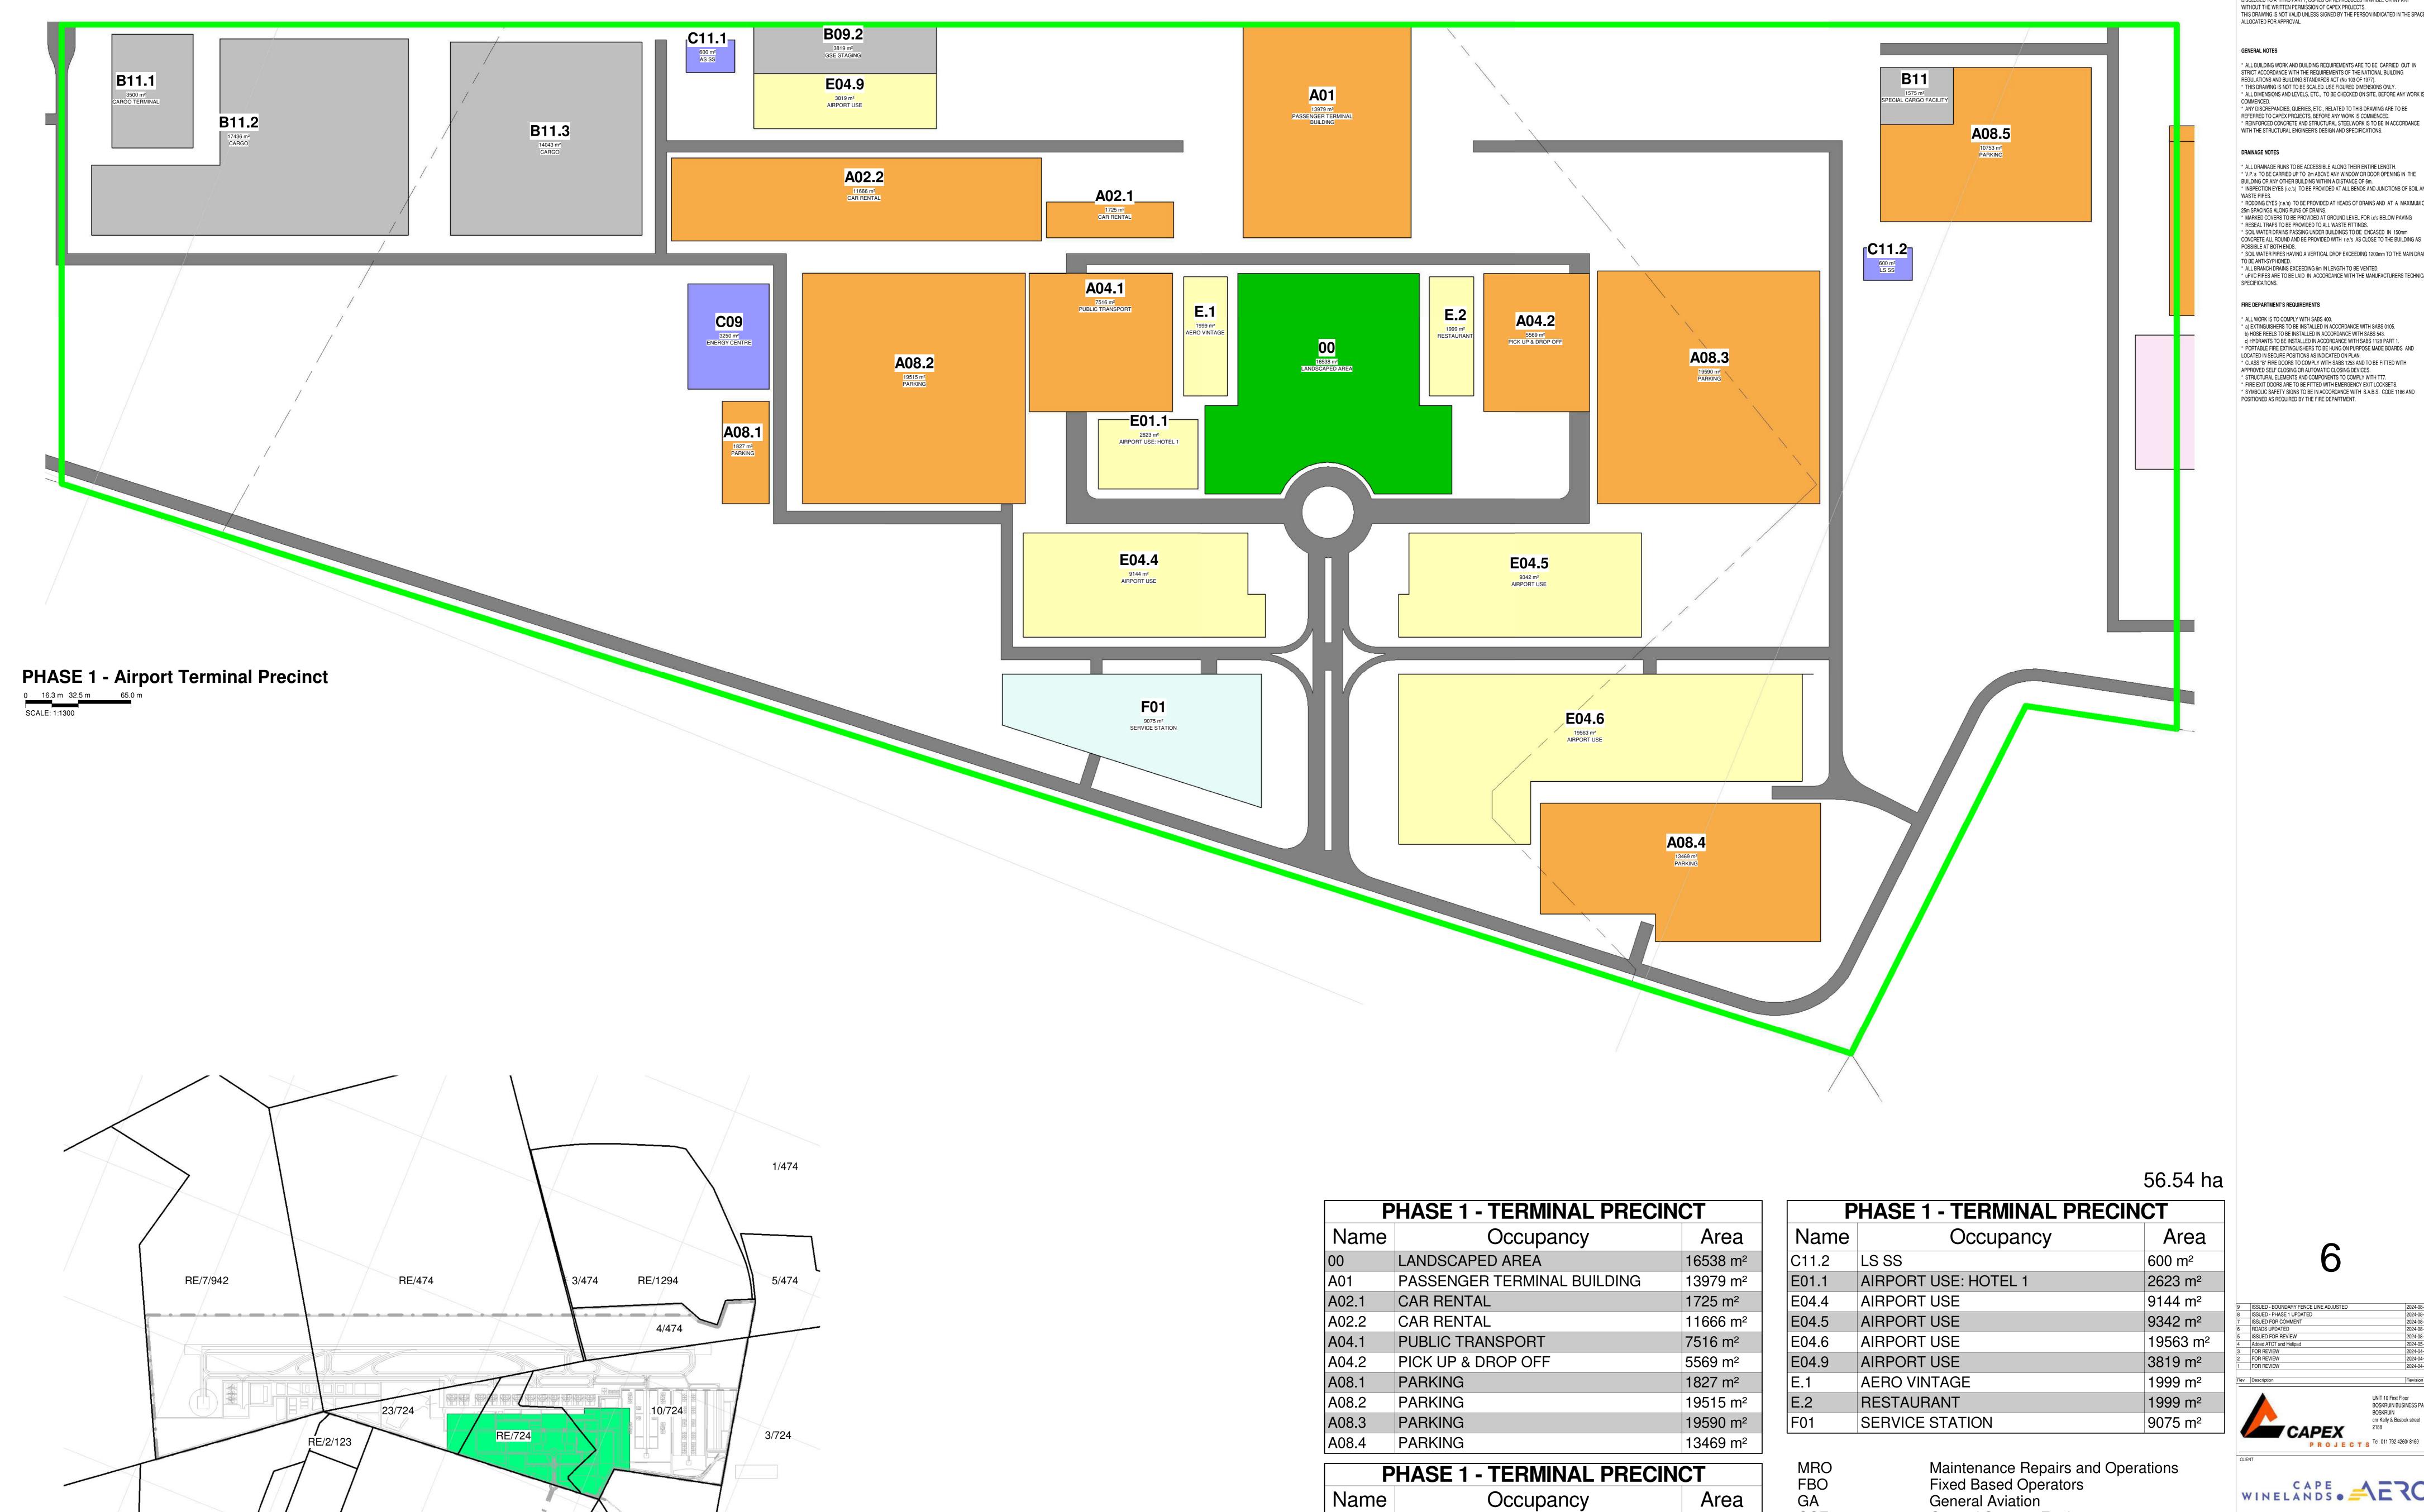

RE/123

RE/1/123

6/123

Key Plan - PHASE 1 Airport Terminal Precinct

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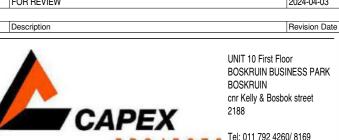
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	Added ATCT and Helipad	2024-05-24
	FOR REVIEW	2024-04-10
	FOR REVIEW	2024-04-03
	FOR REVIEW	2024-04-03
lev	Description	Revision Date



WINELANDS . AERO

ENVIRONMENTAL CONSULTANT PHASE 1 TERMINAL PRECINCT CWA - PRECINCT PLANS

DATE 2024-08-20

SCALE As indicated

2024-3297 409 9

DRAWN BY: CW DENNIS

Ground Support Equipment
Aircraft Rescue and Firefighting

Final Approach and Take-off (Helipad)

Wastewater Treatment Plant / Works

Remote Digital Control Tower System

Precision Approach Path Indicator

GSE ARFF

FATO

PAPI

3819 m²

17436 m²

14043 m²

3250 m²

600 m²

GSE STAGING

ENERGY CENTRE


CARGO

CARGO

AS SS

B11.2

C11.1

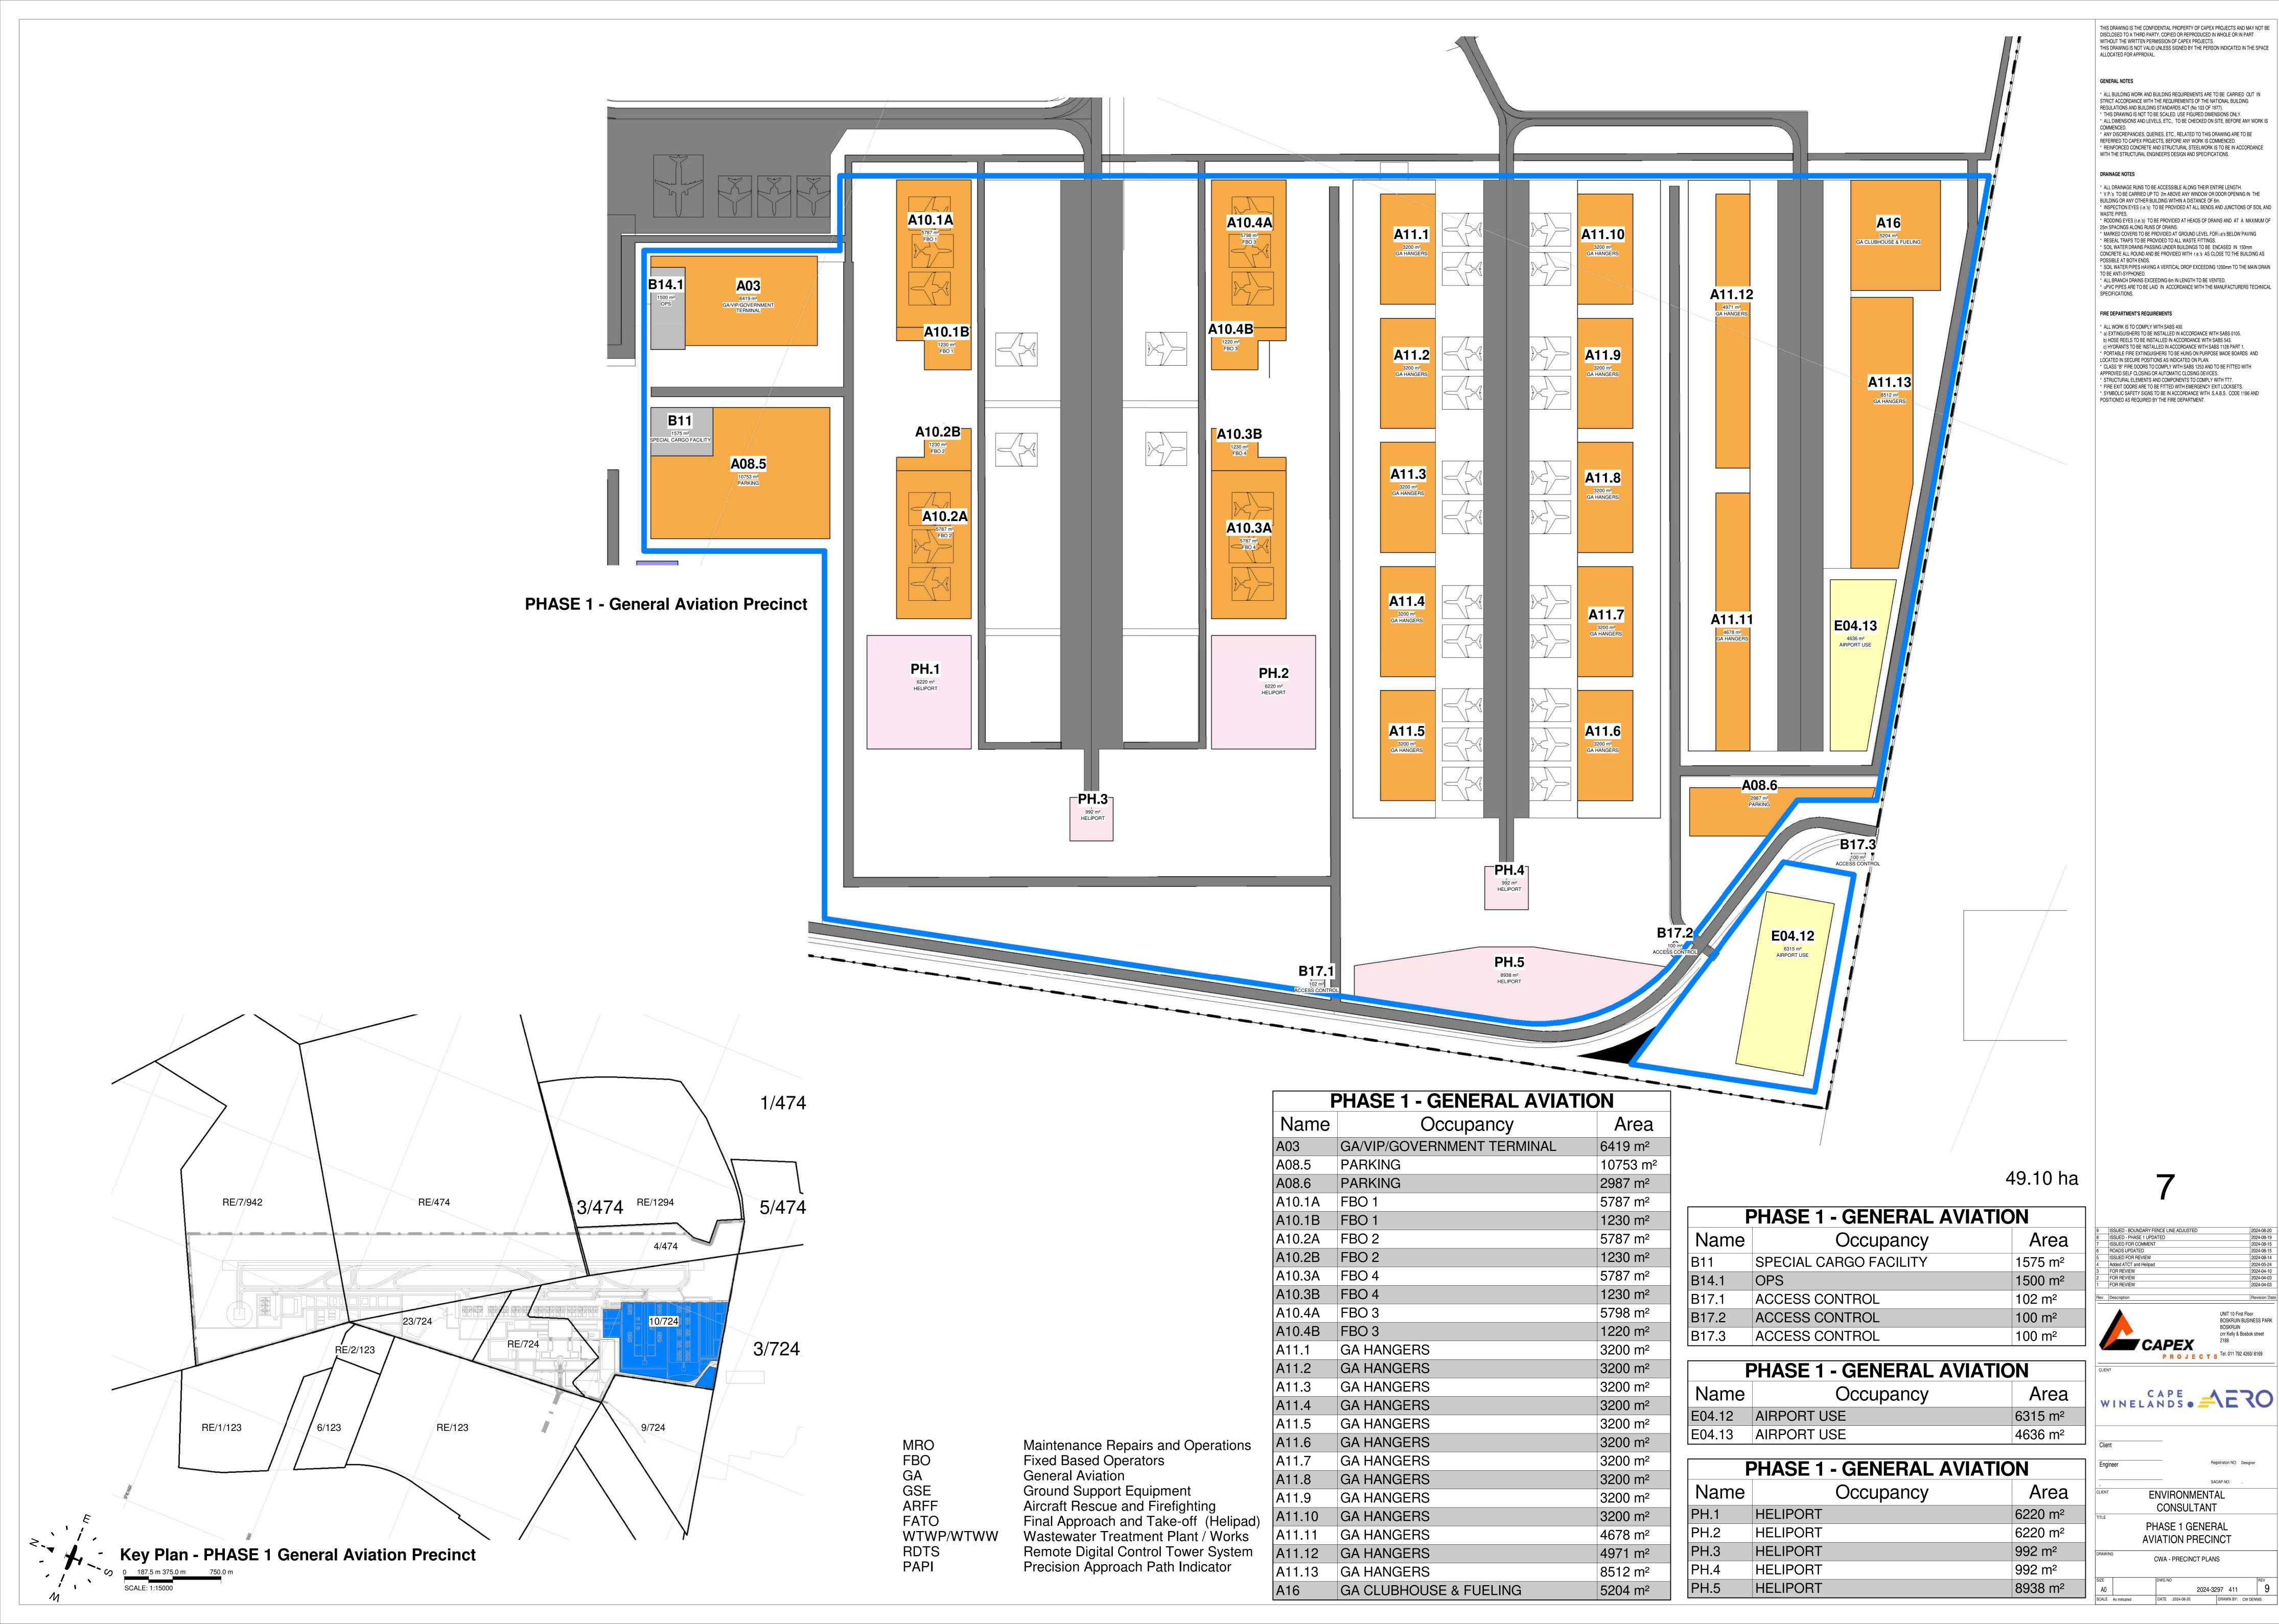



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* upvc pipes are to be Laid in accordance with the Manufacturers technical

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10	Amendment to 809, Opdate to table names	2025-01-23
15	BH, COCT Water Line, Fuel Line and Boundary Adjustments	2025-01-15
14	ISSUED - BOUNDARY FENCE LINE ADJUSTED	2024-08-20
13	ISSUED - PHASE 1 UPDATED	2024-08-19
12	ISSUED FOR REVIEW	2024-08-14
11	ISSUED TO PROFESSIONALS	2024-07-24
10	ISSUED	2024-07-24
9	ISSUED	2024-07-24
8	ISSUED	2024-07-23
7	Revised SDP/EIA For Comment	2024-07-23
6	Revised SDP/EIA For Comment	2024-07-23
5	Added ATCT and Helipad	2024-05-24
4	FOR REVIEW	2024-04-10
3	FOR REVIEW	2024-04-03
2	FOR REVIEW	2024-04-03
1	FOR REVIEW	2024-03-28
Rev	Description	Revision Date









ENVIRONMENTAL CONSULTANT

PHASE 2 CWA - PRECINCT PLANS

2024-3297 400 **16**DATE 2025-01-23 DRAWN BY: CW DENNIS

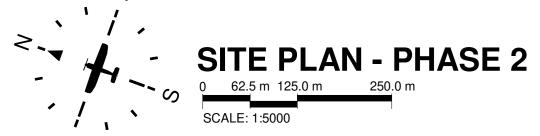

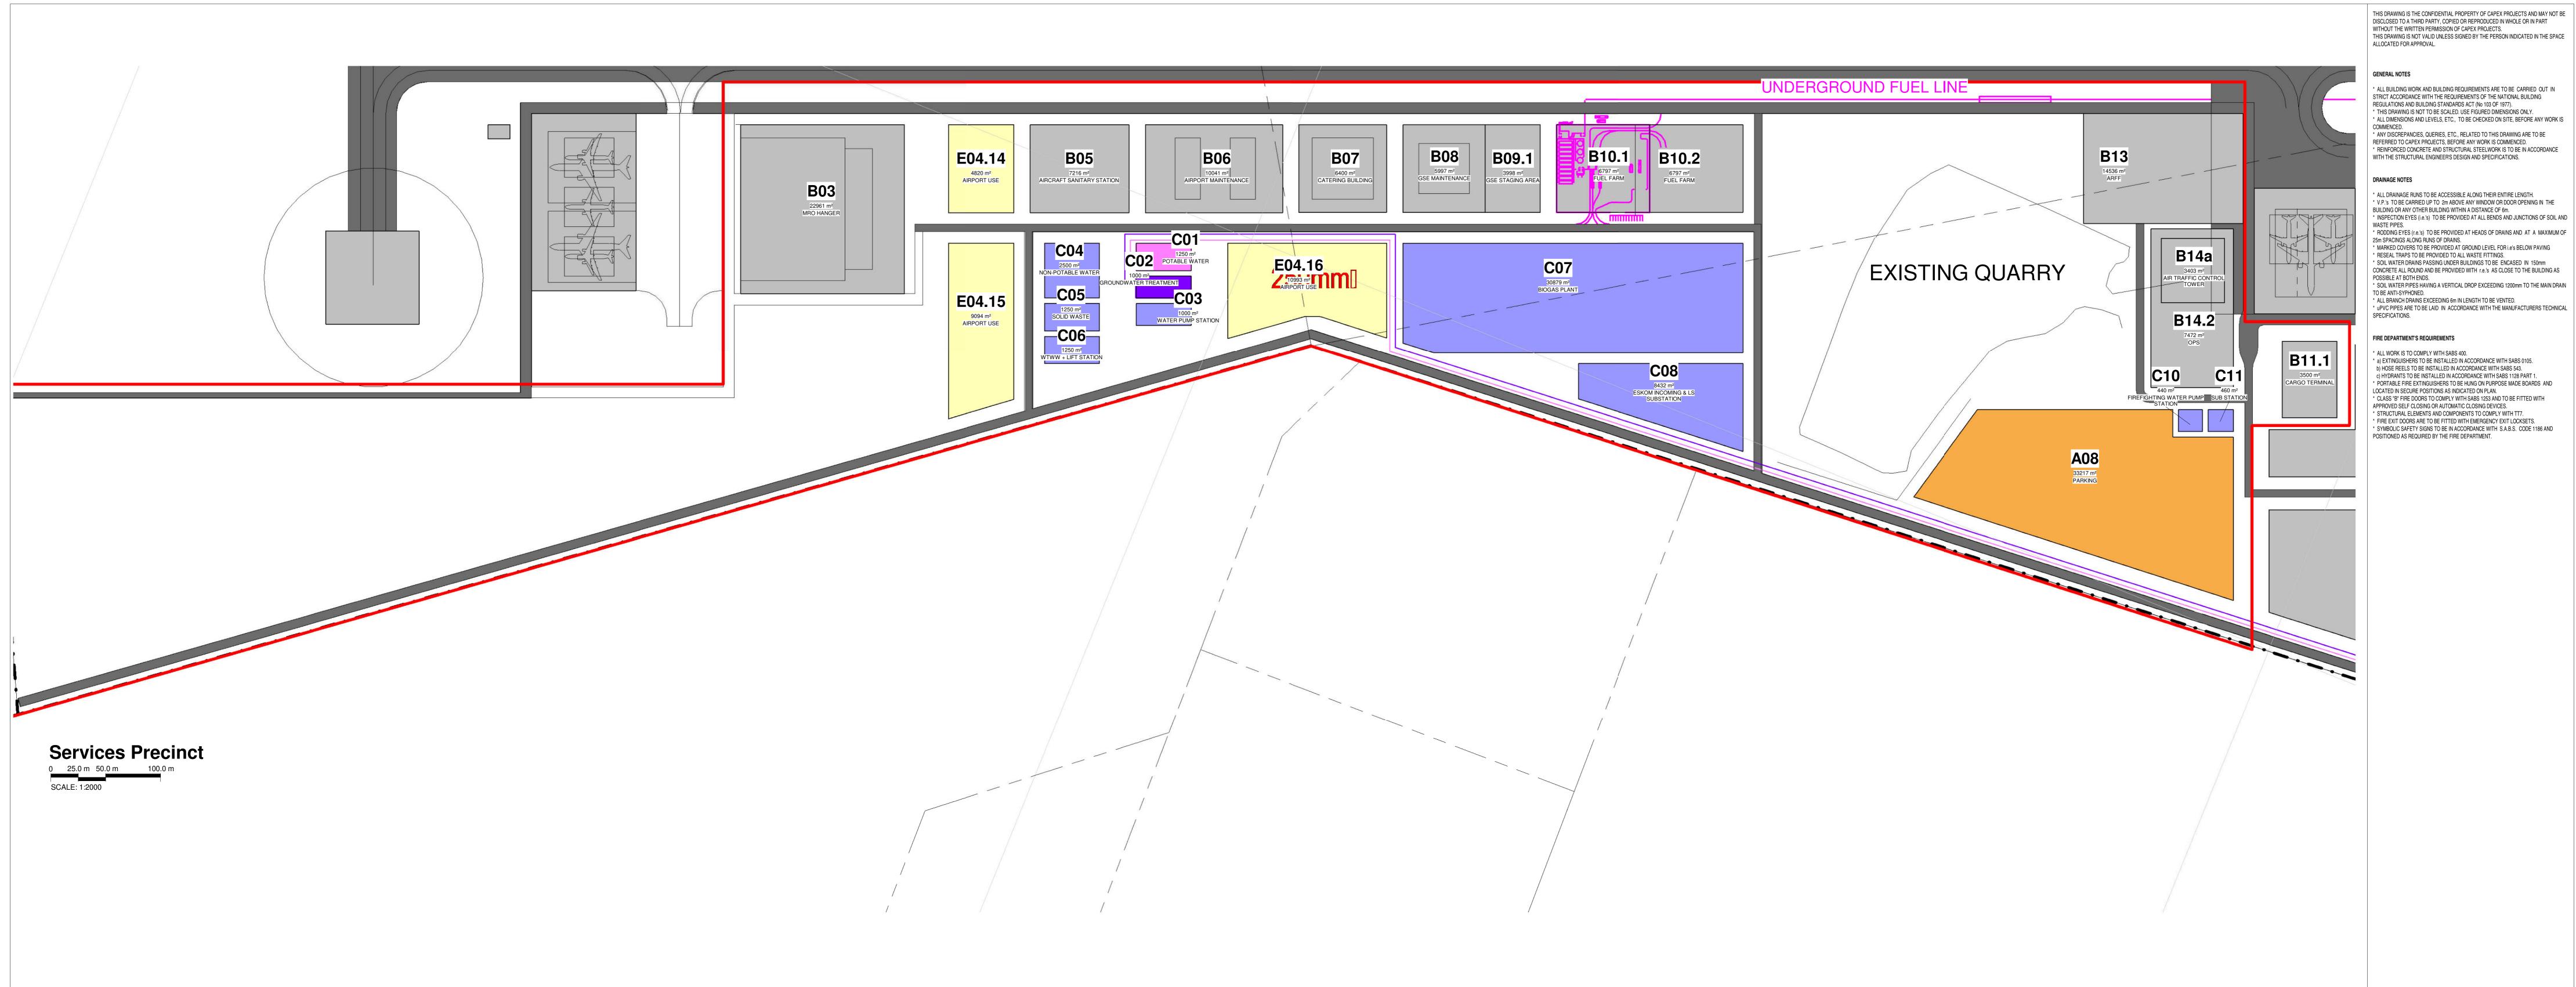

64.49 ha

Name	Occupancy	Plot Area
A08	PARKING	33217 m ²
B03	MRO HANGER	22961 m ²
B05	AIRCRAFT SANITARY STATION	7216 m ²
B06	AIRPORT MAINTENANCE	10041 m ²
B07	CATERING BUILDING	6400 m ²
B08	GSE MAINTENANCE	5997 m ²
B09.1	GSE STAGING AREA	3998 m ²
B10.1	FUEL FARM	6797 m ²
B10.2	FUEL FARM	6797 m ²
B11.1	CARGO TERMINAL	3500 m ²
B13	ARFF	14536 m ²
B14.2	OPS	7472 m ²
B14a	AIR TRAFFIC CONTROL TOWER	3403 m ²

Name	Occupancy	Plot Area
C01	POTABLE WATER	1250 m ²
C02	GROUNDWATER TREATMENT	1000 m ²
C03	WATER PUMP STATION	1000 m ²
C04	NON-POTABLE WATER	2500 m ²
C05	SOLID WASTE	1250 m ²
C06	WTWW + LIFT STATION	1250 m ²
C07	BIOGAS PLANT	30879 m ²
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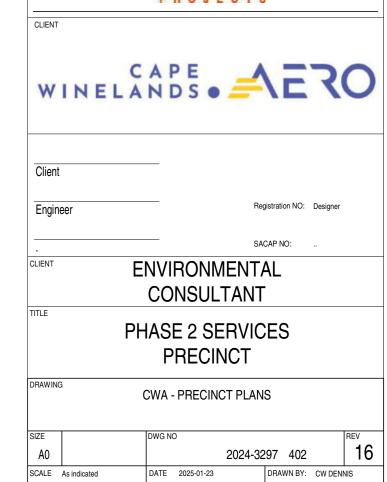
Name	Occupancy	Plot Area
E04.14	AIRPORT USE	4820 m ²
E04.15	AIRPORT USE	9094 m²
E04.16	AIRPORT USE	10993 m ²

MRO FBO GSE ARFF WTWP/WTWW RDTS PAPI


Maintenance Repairs and Operations Fixed Based Operators General Aviation Ground Support Equipment
Aircraft Rescue and Firefighting
Final Approach and Take-off (Helipad)
Wastewater Treatment Plant / Works
Remote Digital Control Tower System
Precision Approach Path Indicator

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15	BH, COCT Water Line, Fuel Line and Boundary Adjustments	2025-01-15
14	ISSUED - BOUNDARY FENCE LINE ADJUSTED	2024-08-20
13	ISSUED - PHASE 1 UPDATED	2024-08-19
12	ISSUED FOR REVIEW	2024-08-14
11	ISSUED TO PROFESSIONALS	2024-07-24
10	ISSUED	2024-07-24
)	ISSUED	2024-07-24
3	ISSUED	2024-07-23
7	Revised SDP/EIA For Comment	2024-07-23
;	Revised SDP/EIA For Comment	2024-07-23
5	Added ATCT and Helipad	2024-05-24
1	FOR REVIEW	2024-04-10
3	FOR REVIEW	2024-04-03
2	FOR REVIEW	2024-04-03
	FOR REVIEW	2024-03-28
		·
Rev	Description	Revision Date






DATE 2025-01-23 DRAWN BY: CW DENNIS

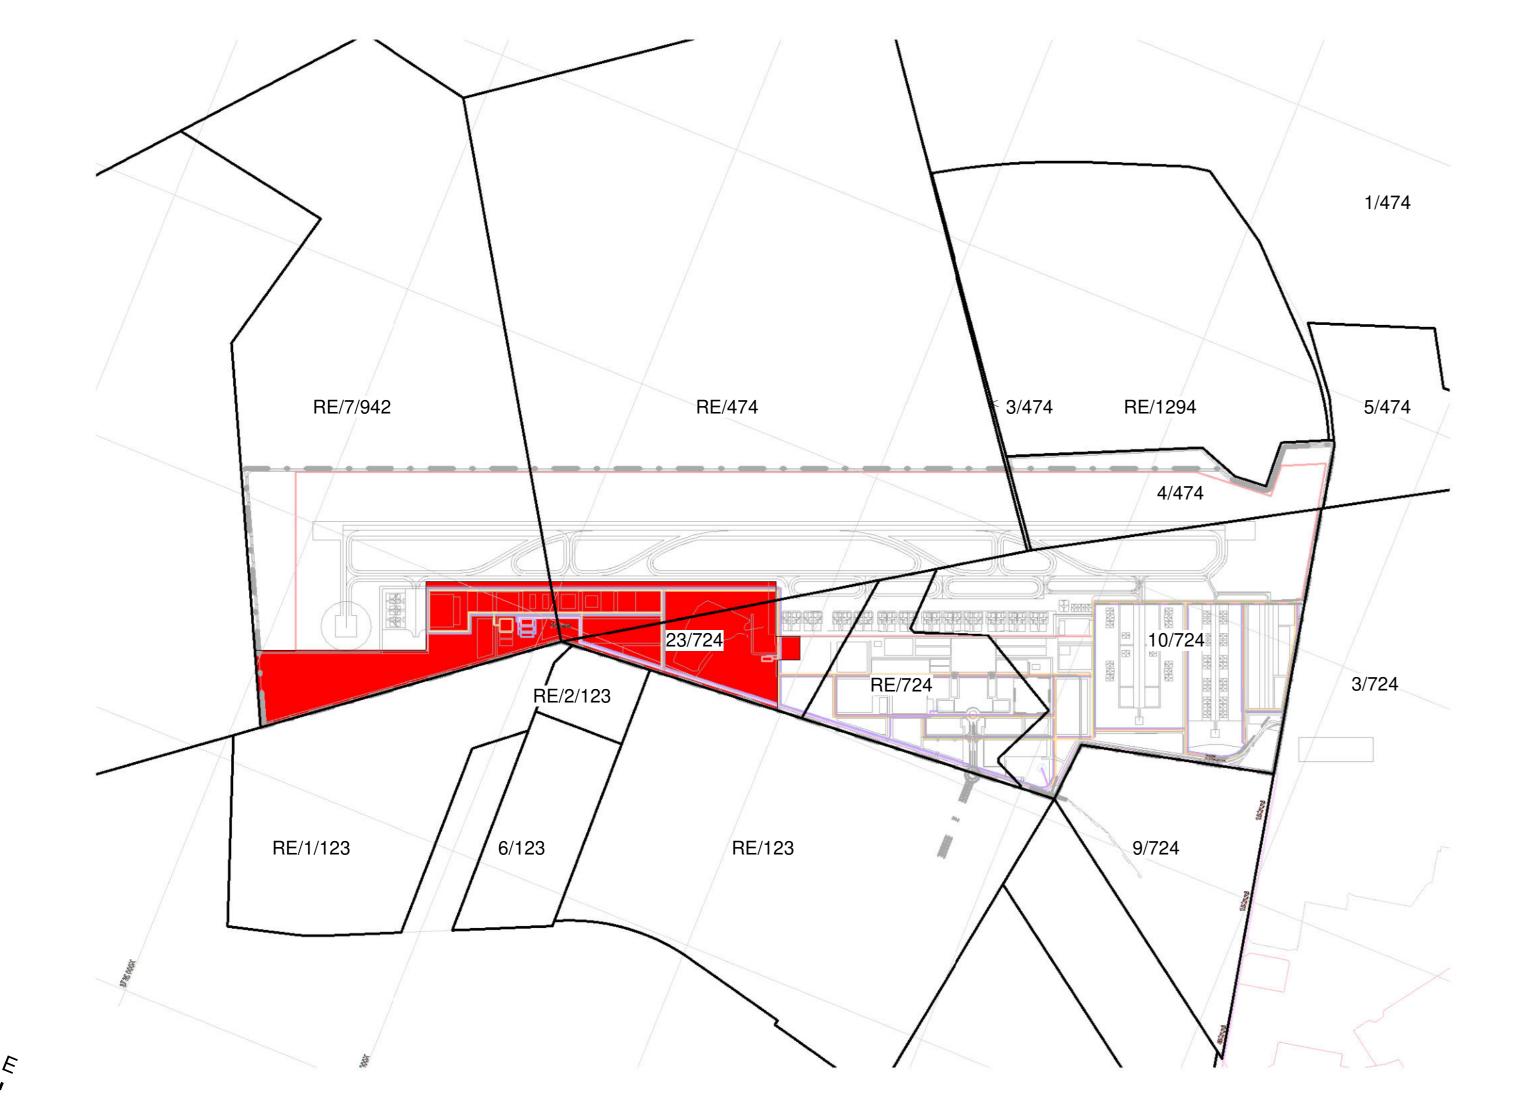

Key Plan - Services Precinct

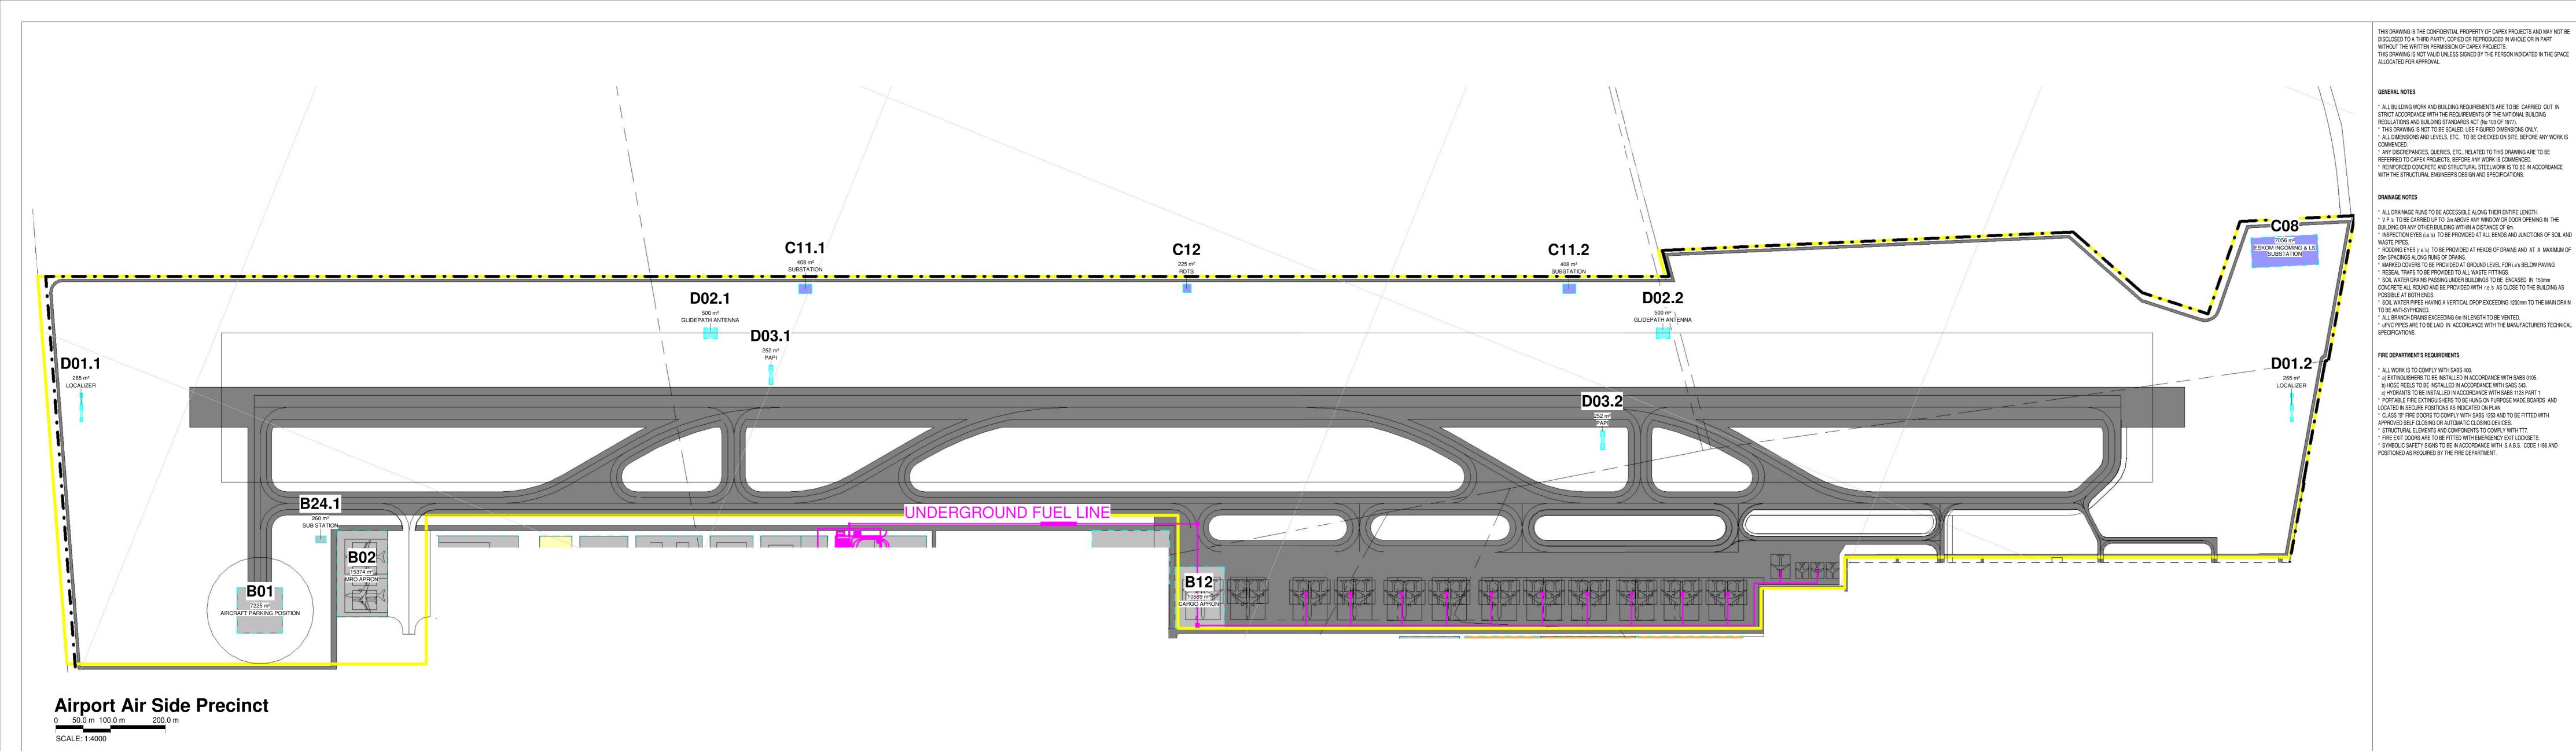


248.41 ha

Name Occupancy Plot Area ESKOM INCOMING & LS SUBSTATION 7056 m² SUBSTATION 408 m² 408 m² SUBSTATION C12 RDTS 225 m² LOCALIZER 265 m² 265 m² LOCALIZER 500 m² GLIDEPATH ANTENNA GLIDEPATH ANTENNA 500 m² D03.1 PAPI 252 m² D03.2 PAPI 252 m²

Plot Area Name Occupancy AIRCRAFT PARKING POSITION 7225 m² 15374 m² MRO APRON CARGO APRON 10589 m² SUB STATION 260 m²

Maintenance Repairs and Operations Fixed Based Operators General Aviation FBO Ground Support Equipment Aircraft Rescue and Firefighting ARFF Final Approach and Take-off (Helipad)
Wastewater Treatment Plant / Works
Remote Digital Control Tower System
Precision Approach Path Indicator FATO WTWP/WTWW PAPI

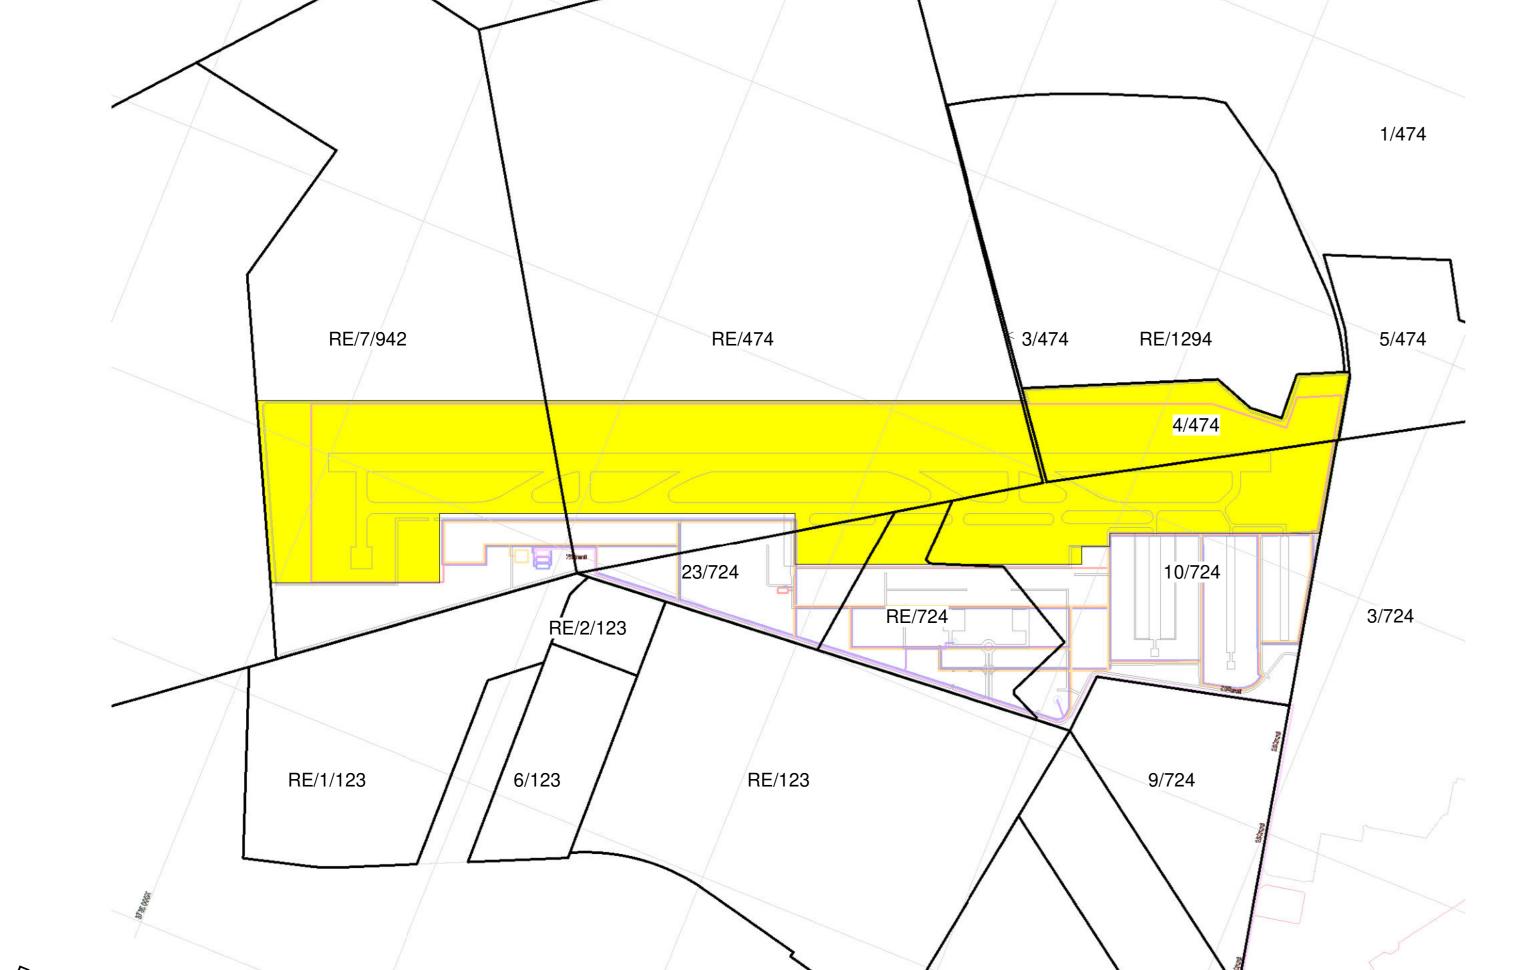

Key Plan - Airport Air Side Precinct

10

	-	
Rev	Description	Revision Date
1	FOR REVIEW	2024-03-28
2	FOR REVIEW	2024-04-03
3	FOR REVIEW	2024-04-03
4	FOR REVIEW	2024-04-10
5	Added ATCT and Helipad	2024-05-24
6	Revised SDP/EIA For Comment	2024-07-23
7	Revised SDP/EIA For Comment	2024-07-23
8	ISSUED	2024-07-23
9	ISSUED	2024-07-24
10	ISSUED	2024-07-24
11	ISSUED TO PROFESSIONALS	2024-07-24
12	ISSUED FOR REVIEW	2024-08-14
13	ISSUED - PHASE 1 UPDATED	2024-08-19
14	ISSUED - BOUNDARY FENCE LINE ADJUSTED	2024-08-20
15	BH, COCT Water Line, Fuel Line and Boundary Adjustments	2025-01-15
16	Amendment to B09, Update to table names	2025-01-23




PRECINCT

CWA - PRECINCT PLANS

2024-3297 404 16

DATE 2025-01-23 DRAWN BY: CW DENNIS

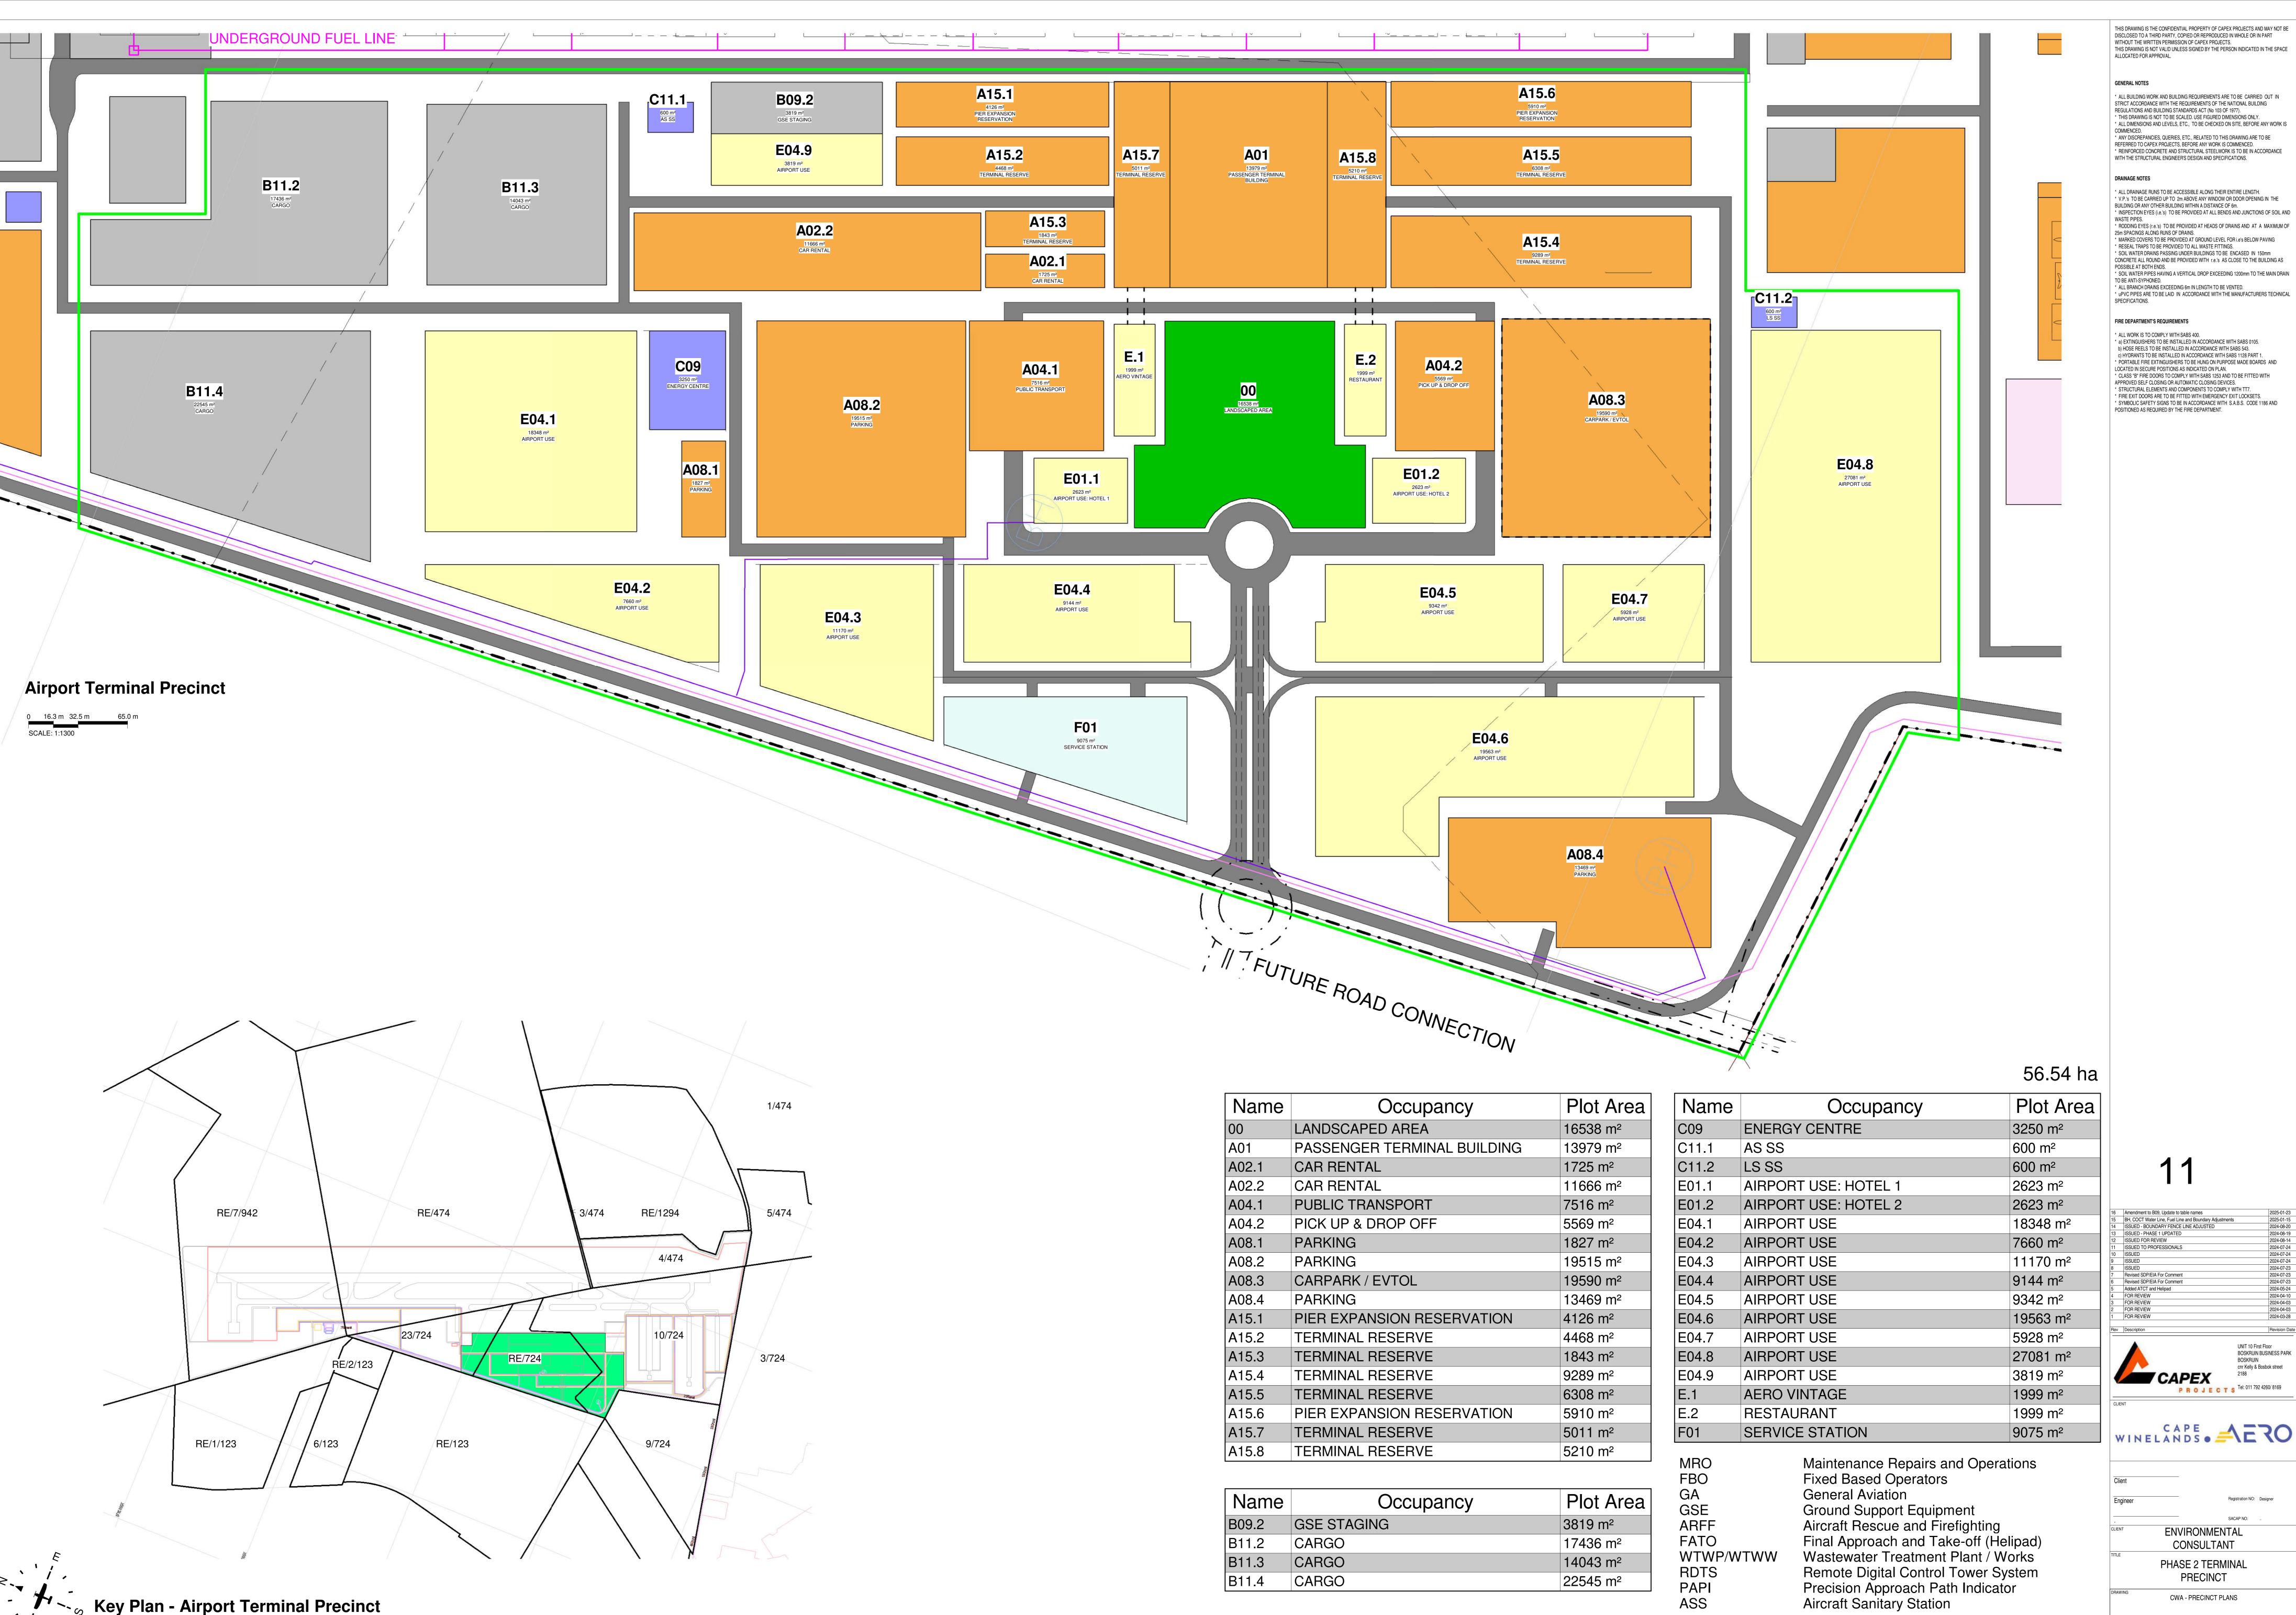

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> * ALL BUILDING WORK AND BUILDING REQUIREMENTS ARE TO BE CARRIED OUT IN STRICT ACCORDANCE WITH THE REQUIREMENTS OF THE NATIONAL BUILDING REGULATIONS AND BUILDING STANDARDS ACT (No 103 OF 1977). * THIS DRAWING IS NOT TO BE SCALED. USE FIGURED DIMENSIONS ONLY. * ALL DIMENSIONS AND LEVELS, ETC., TO BE CHECKED ON SITE, BEFORE ANY WORK IS * ANY DISCREPANCIES, QUERIES, ETC., RELATED TO THIS DRAWING ARE TO BE REFERRED TO CAPEX PROJECTS, BEFORE ANY WORK IS COMMENCED. * REINFORCED CONCRETE AND STRUCTURAL STEELWORK IS TO BE IN ACCORDANCE

* ALL DRAINAGE RUNS TO BE ACCESSIBLE ALONG THEIR ENTIRE LENGTH. * V.P.'s TO BE CARRIED UP TO 2m ABOVE ANY WINDOW OR DOOR OPENING IN THE BUILDING OR ANY OTHER BUILDING WITHIN A DISTANCE OF 6m. * INSPECTION EYES (i.e.'s) TO BE PROVIDED AT ALL BENDS AND JUNCTIONS OF SOIL AND * RODDING EYES (r.e.'s) TO BE PROVIDED AT HEADS OF DRAINS AND AT A MAXIMUM OF 25m SPACINGS ALONG RUNS OF DRAINS. MARKED COVERS TO BE PROVIDED AT GROUND LEVEL FOR i.e's BELOW PAVING * RESEAL TRAPS TO BE PROVIDED TO ALL WASTE FITTINGS. * SOIL WATER DRAINS PASSING UNDER BUILDINGS TO BE ENCASED IN 150mm CONCRETE ALL ROUND AND BE PROVIDED WITH r.e.'s AS CLOSE TO THE BUILDING AS * SOIL WATER PIPES HAVING A VERTICAL DROP EXCEEDING 1200mm TO THE MAIN DRAIN * ALL BRANCH DRAINS EXCEEDING 6m IN LENGTH TO BE VENTED. * uPVC PIPES ARE TO BE LAID IN ACCORDANCE WITH THE MANUFACTURERS TECHNICAL

ALL WORK IS TO COMPLY WITH SABS 400.

* a) EXTINGUISHERS TO BE INSTALLED IN ACCORDANCE WITH SABS 0105. b) HOSE REELS TO BE INSTALLED IN ACCORDANCE WITH SABS 543. c) HYDRANTS TO BE INSTALLED IN ACCORDANCE WITH SABS 1128 PART 1. PORTABLE FIRE EXTINGUISHERS TO BE HUNG ON PURPOSE MADE BOARDS AND LOCATED IN SECURE POSITIONS AS INDICATED ON PLAN. * CLASS "B" FIRE DOORS TO COMPLY WITH SABS 1253 AND TO BE FITTED WITH APPROVED SELF CLOSING OR AUTOMATIC CLOSING DEVICES. * STRUCTURAL ELEMENTS AND COMPONENTS TO COMPLY WITH TT7. FIRE EXIT DOORS ARE TO BE FITTED WITH EMERGENCY EXIT LOCKSETS. * SYMBOLIC SAFETY SIGNS TO BE IN ACCORDANCE WITH S.A.B.S. CODE 1186 AND POSITIONED AS REQUIRED BY THE FIRE DEPARTMENT.

11

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6	Amendment to B09, Update to table names	2025-01-23
5	BH, COCT Water Line, Fuel Line and Boundary Adjustments	2025-01-15
4	ISSUED - BOUNDARY FENCE LINE ADJUSTED	2024-08-20
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	FOR REVIEW	2024-04-10
}	FOR REVIEW	2024-04-03
	FOR REVIEW	2024-04-03
	FOR REVIEW	2024-03-28
Rev	Description	Revision Date
	<u> </u>	UNIT 10 First Floor



BOSKRUIN BUSINESS PARK BOSKRUIN cnr Kelly & Bosbok street CAPEX
PROJECTS Tel: 011 792 4260/ 8169

ENVIRONMENTAL

CONSULTANT PHASE 2 TERMINAL PRECINCT


DATE 2025-01-23

SCALE As indicated

CWA - PRECINCT PLANS

2024-3297 401 16

DRAWN BY: CW DENNIS

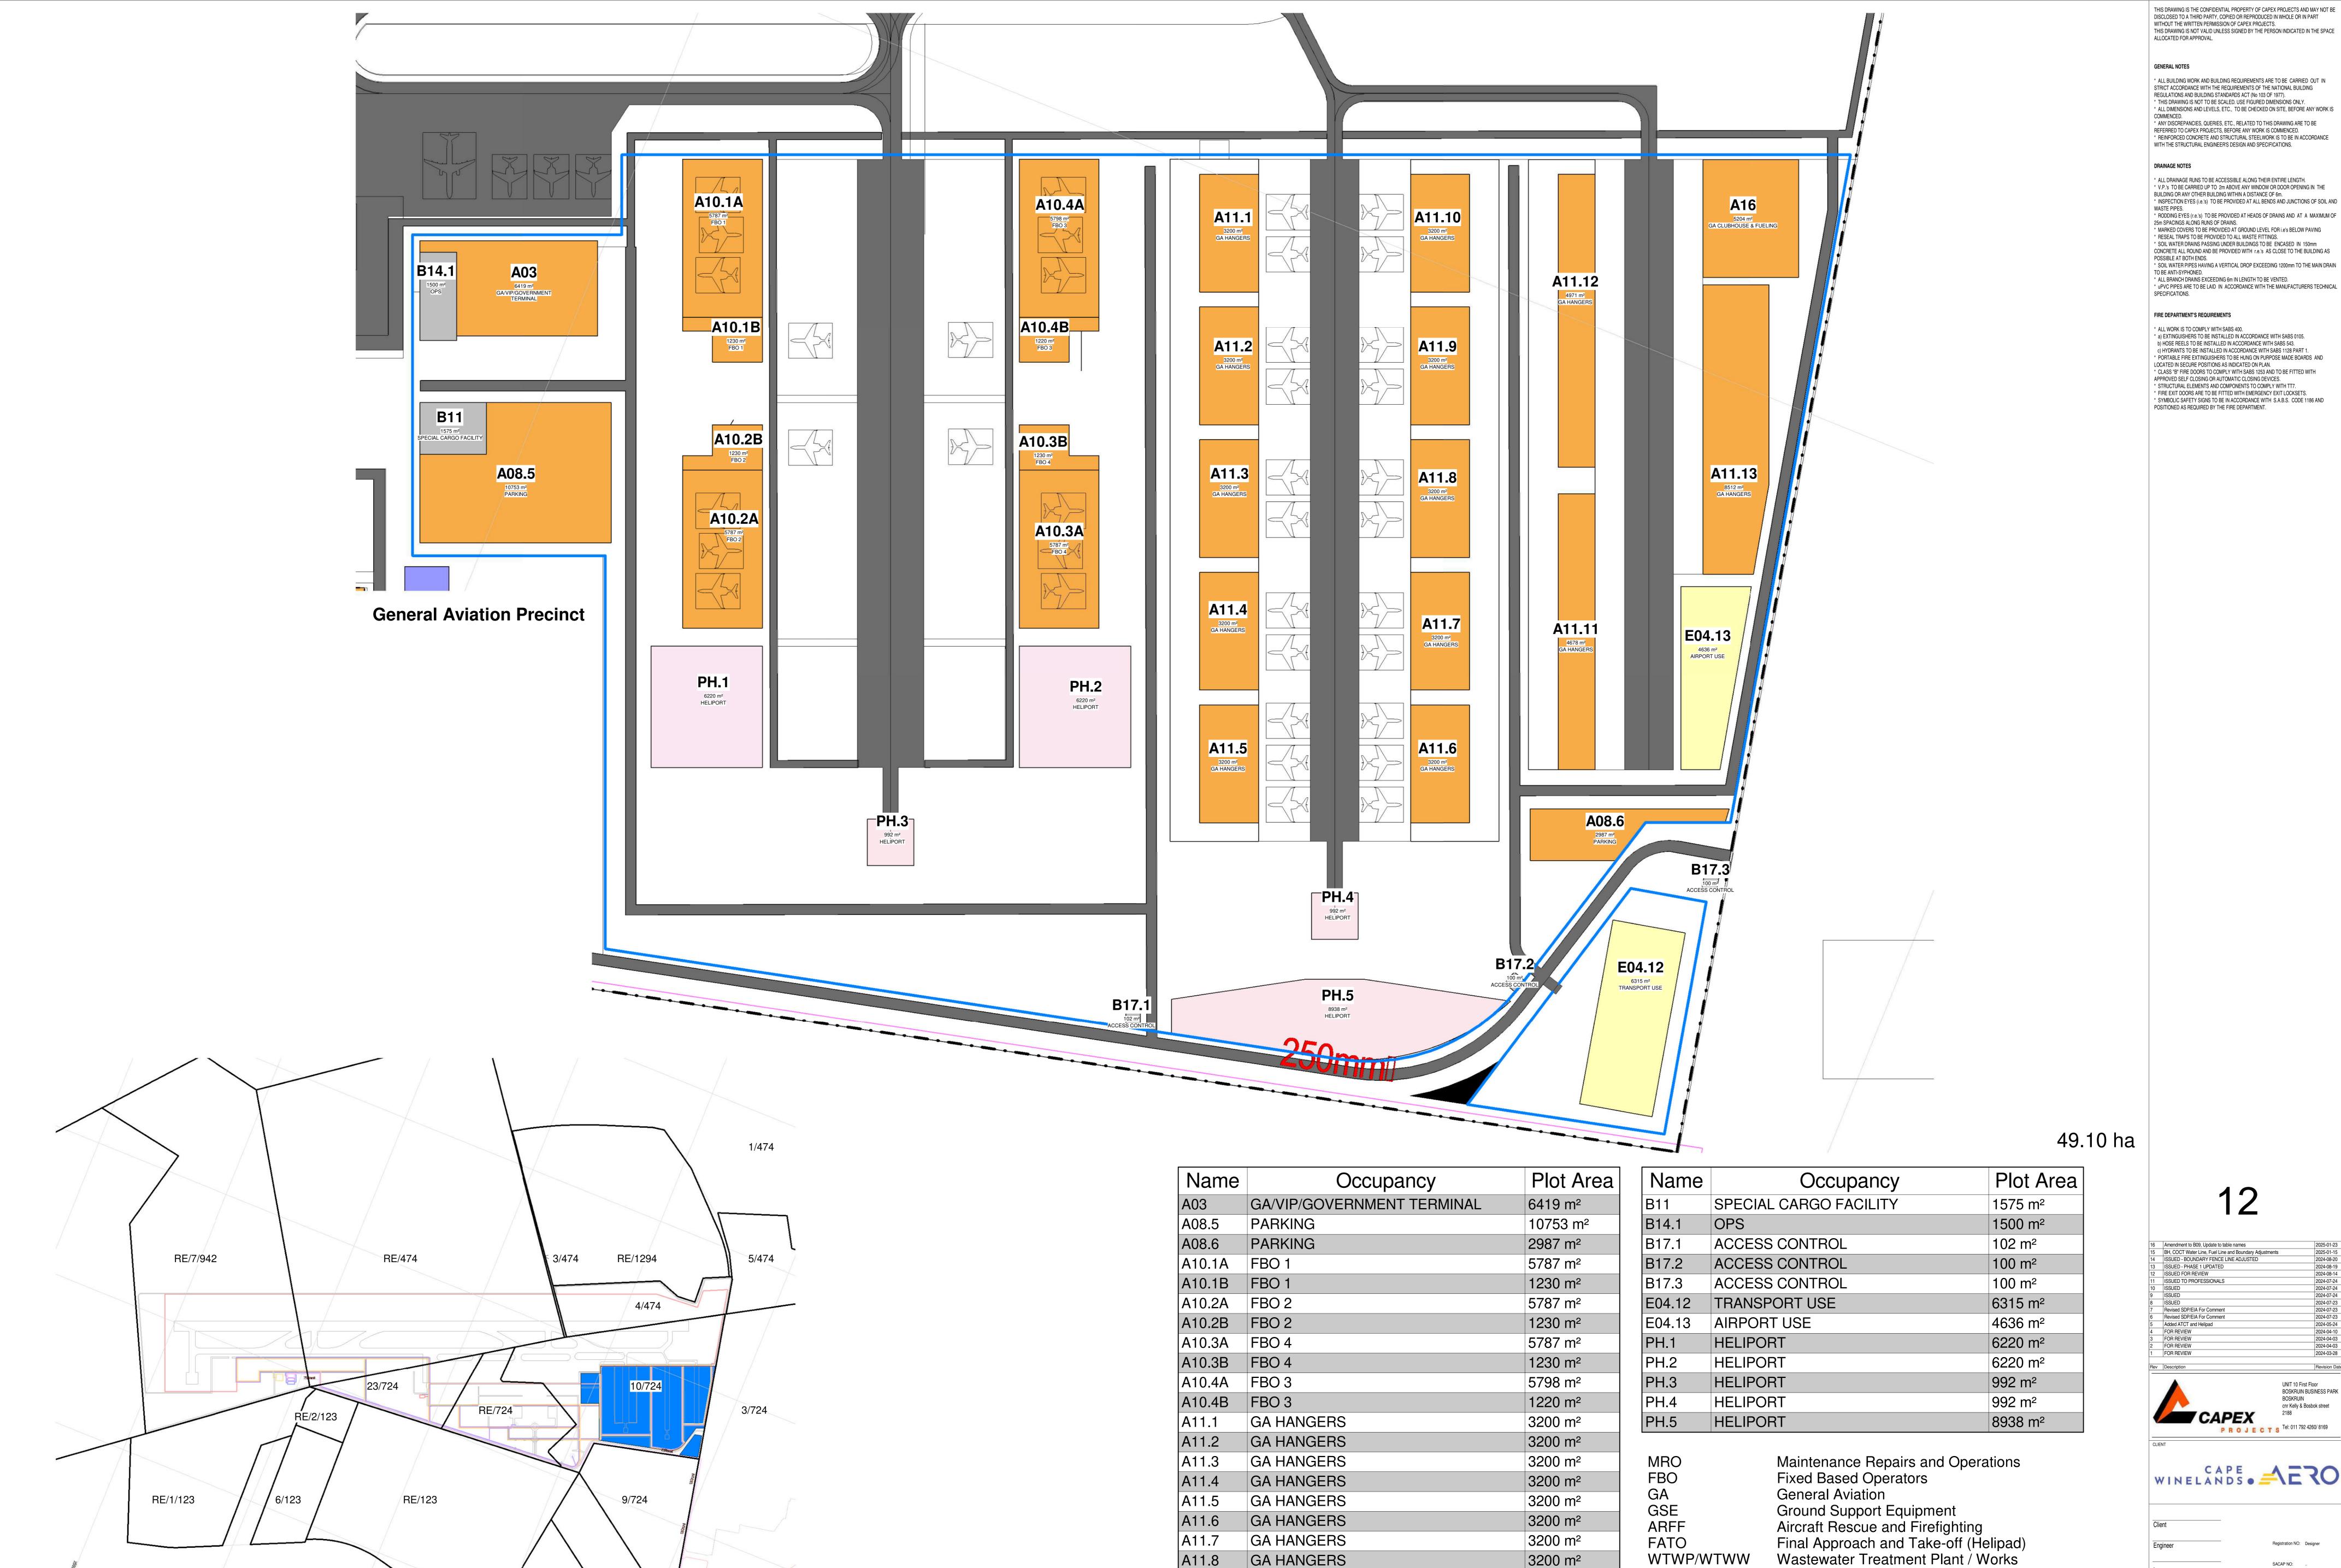

Key Plan - General Aviation Precinct

GA HANGERS

GA HANGERS

GA HANGERS

GA HANGERS

GA HANGERS

GA HANGERS

GA CLUBHOUSE & FUELING

c) HYDRANTS TO BE INSTALLED IN ACCORDANCE WITH SABS 1128 PART 1. * PORTABLE FIRE EXTINGUISHERS TO BE HUNG ON PURPOSE MADE BOARDS AND * CLASS "B" FIRE DOORS TO COMPLY WITH SABS 1253 AND TO BE FITTED WITH APPROVED SELF CLOSING OR AUTOMATIC CLOSING DEVICES. * STRUCTURAL ELEMENTS AND COMPONENTS TO COMPLY WITH TT7.

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	FOR REVIEW	2024-03-28
lev	Description	Revision Date



FATO

RDTS

PAPI

3200 m²

3200 m²

3200 m²

4678 m²

4971 m²

8512 m²

5204 m²

WTWP/WTWW

Remote Digital Control Tower System

Precision Approach Path Indicator

UNIT 10 First Floor BOSKRUIN BUSINESS PARK BOSKRUIN cnr Kelly & Bosbok street

WINELANDS . AERO ENVIRONMENTAL CONSULTANT

PHASE 2 GENERAL **AVIATION PRECINCT** CWA - PRECINCT PLANS

2024-3297 403 16


DRAWN BY: CW DENNIS

DATE 2025-01-23


SCALE As indicated





Pink line adjacent to Mellish Road leading from Lichtenburg Road towards the main entrance of the Airport Precinct indicating placement of 12 to 15 proposed billboards (Sept 2024)

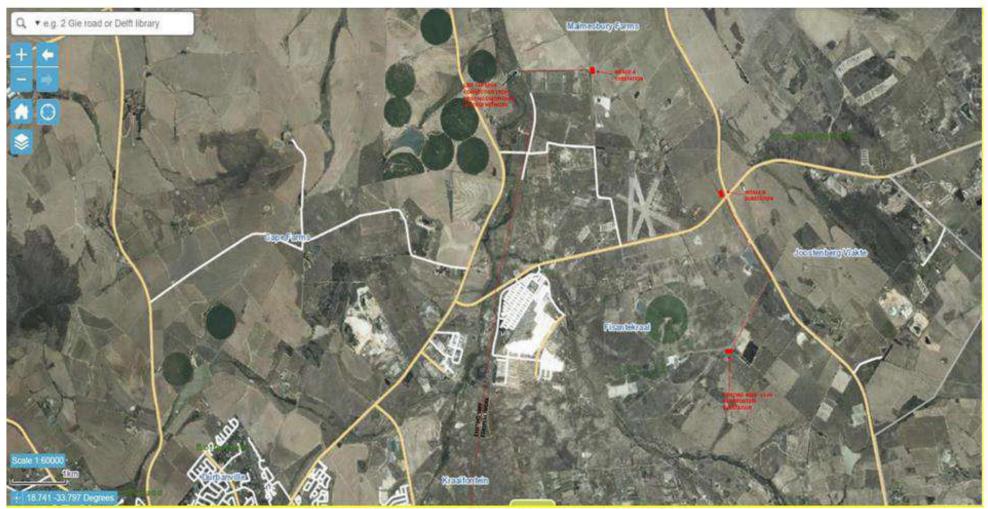

Eskom Bulk High Voltage Feeder Routing

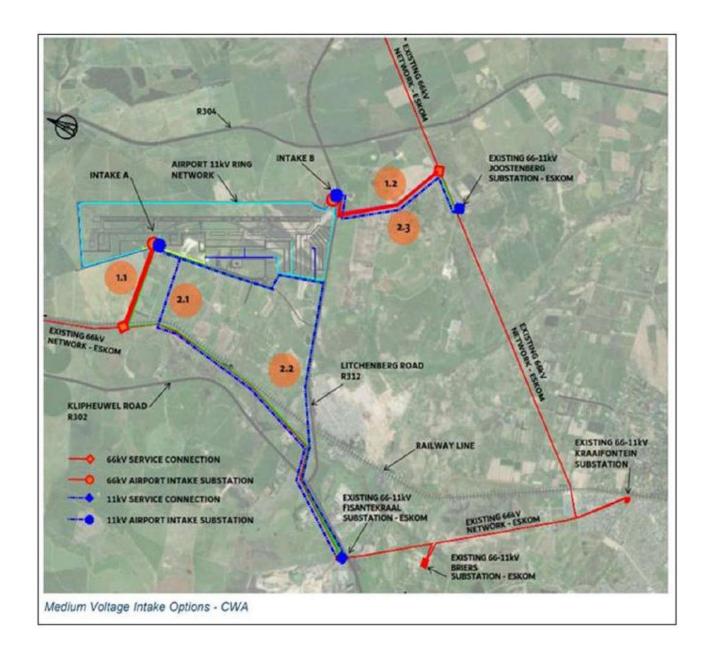

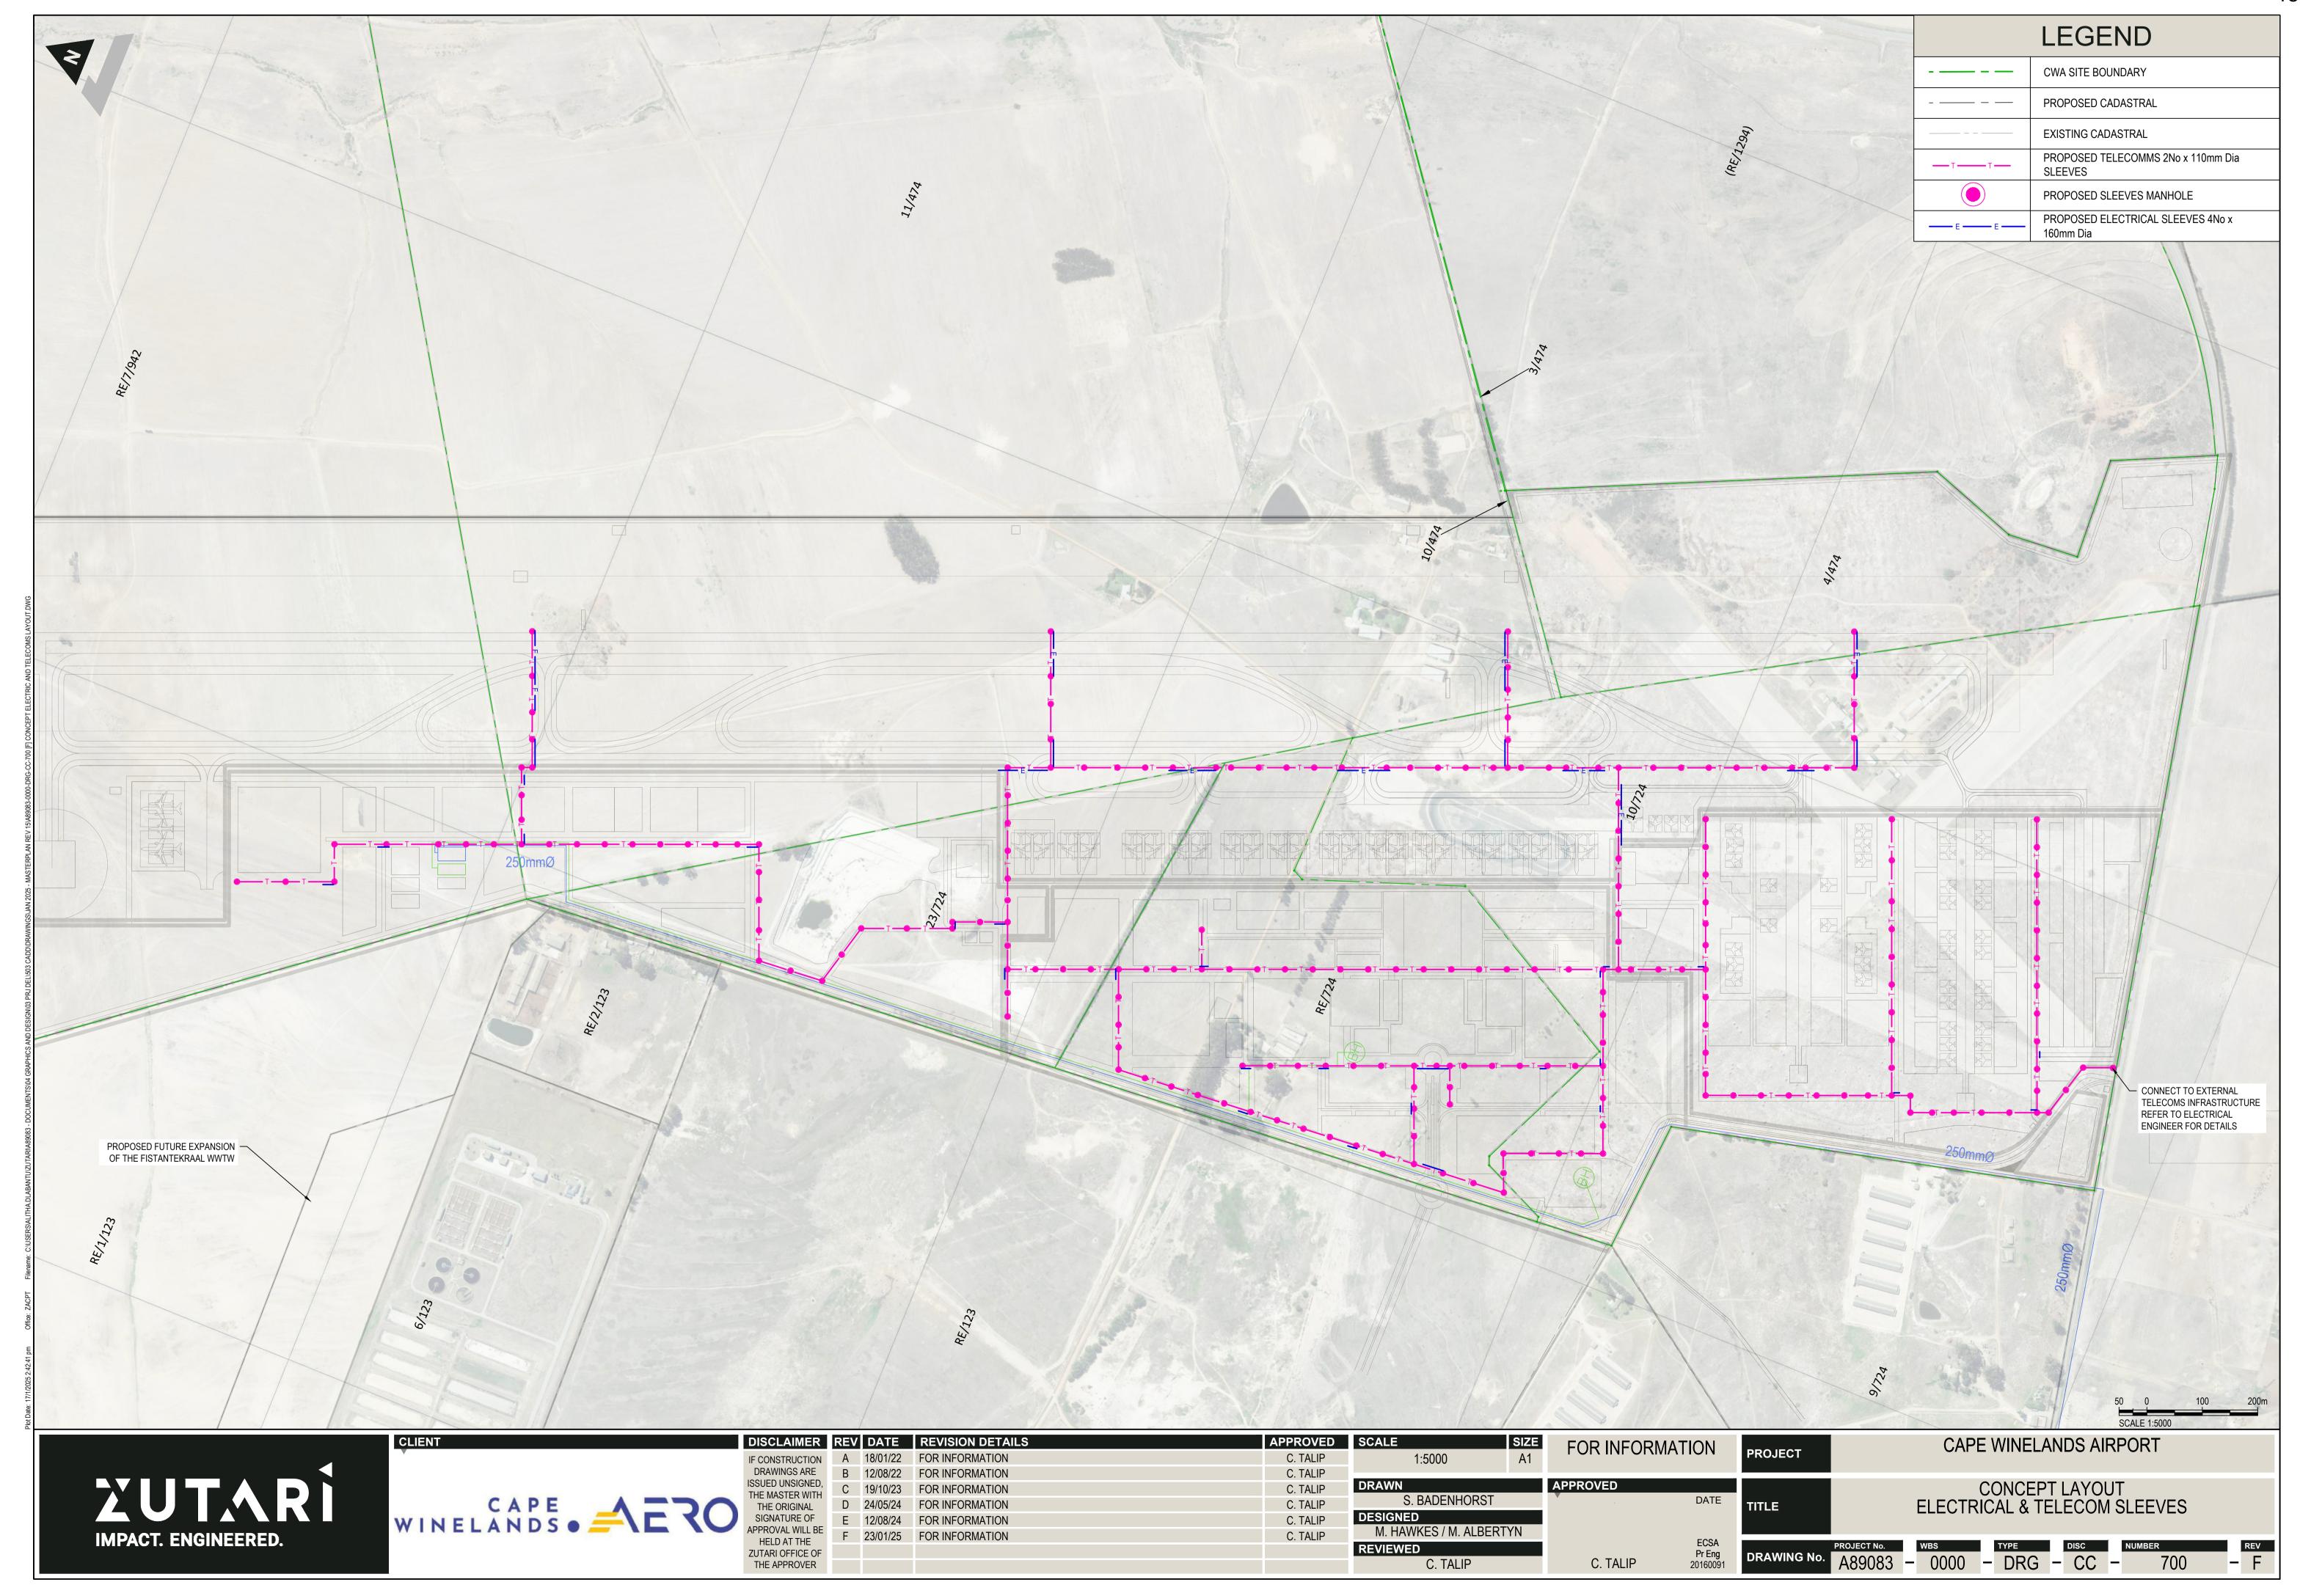

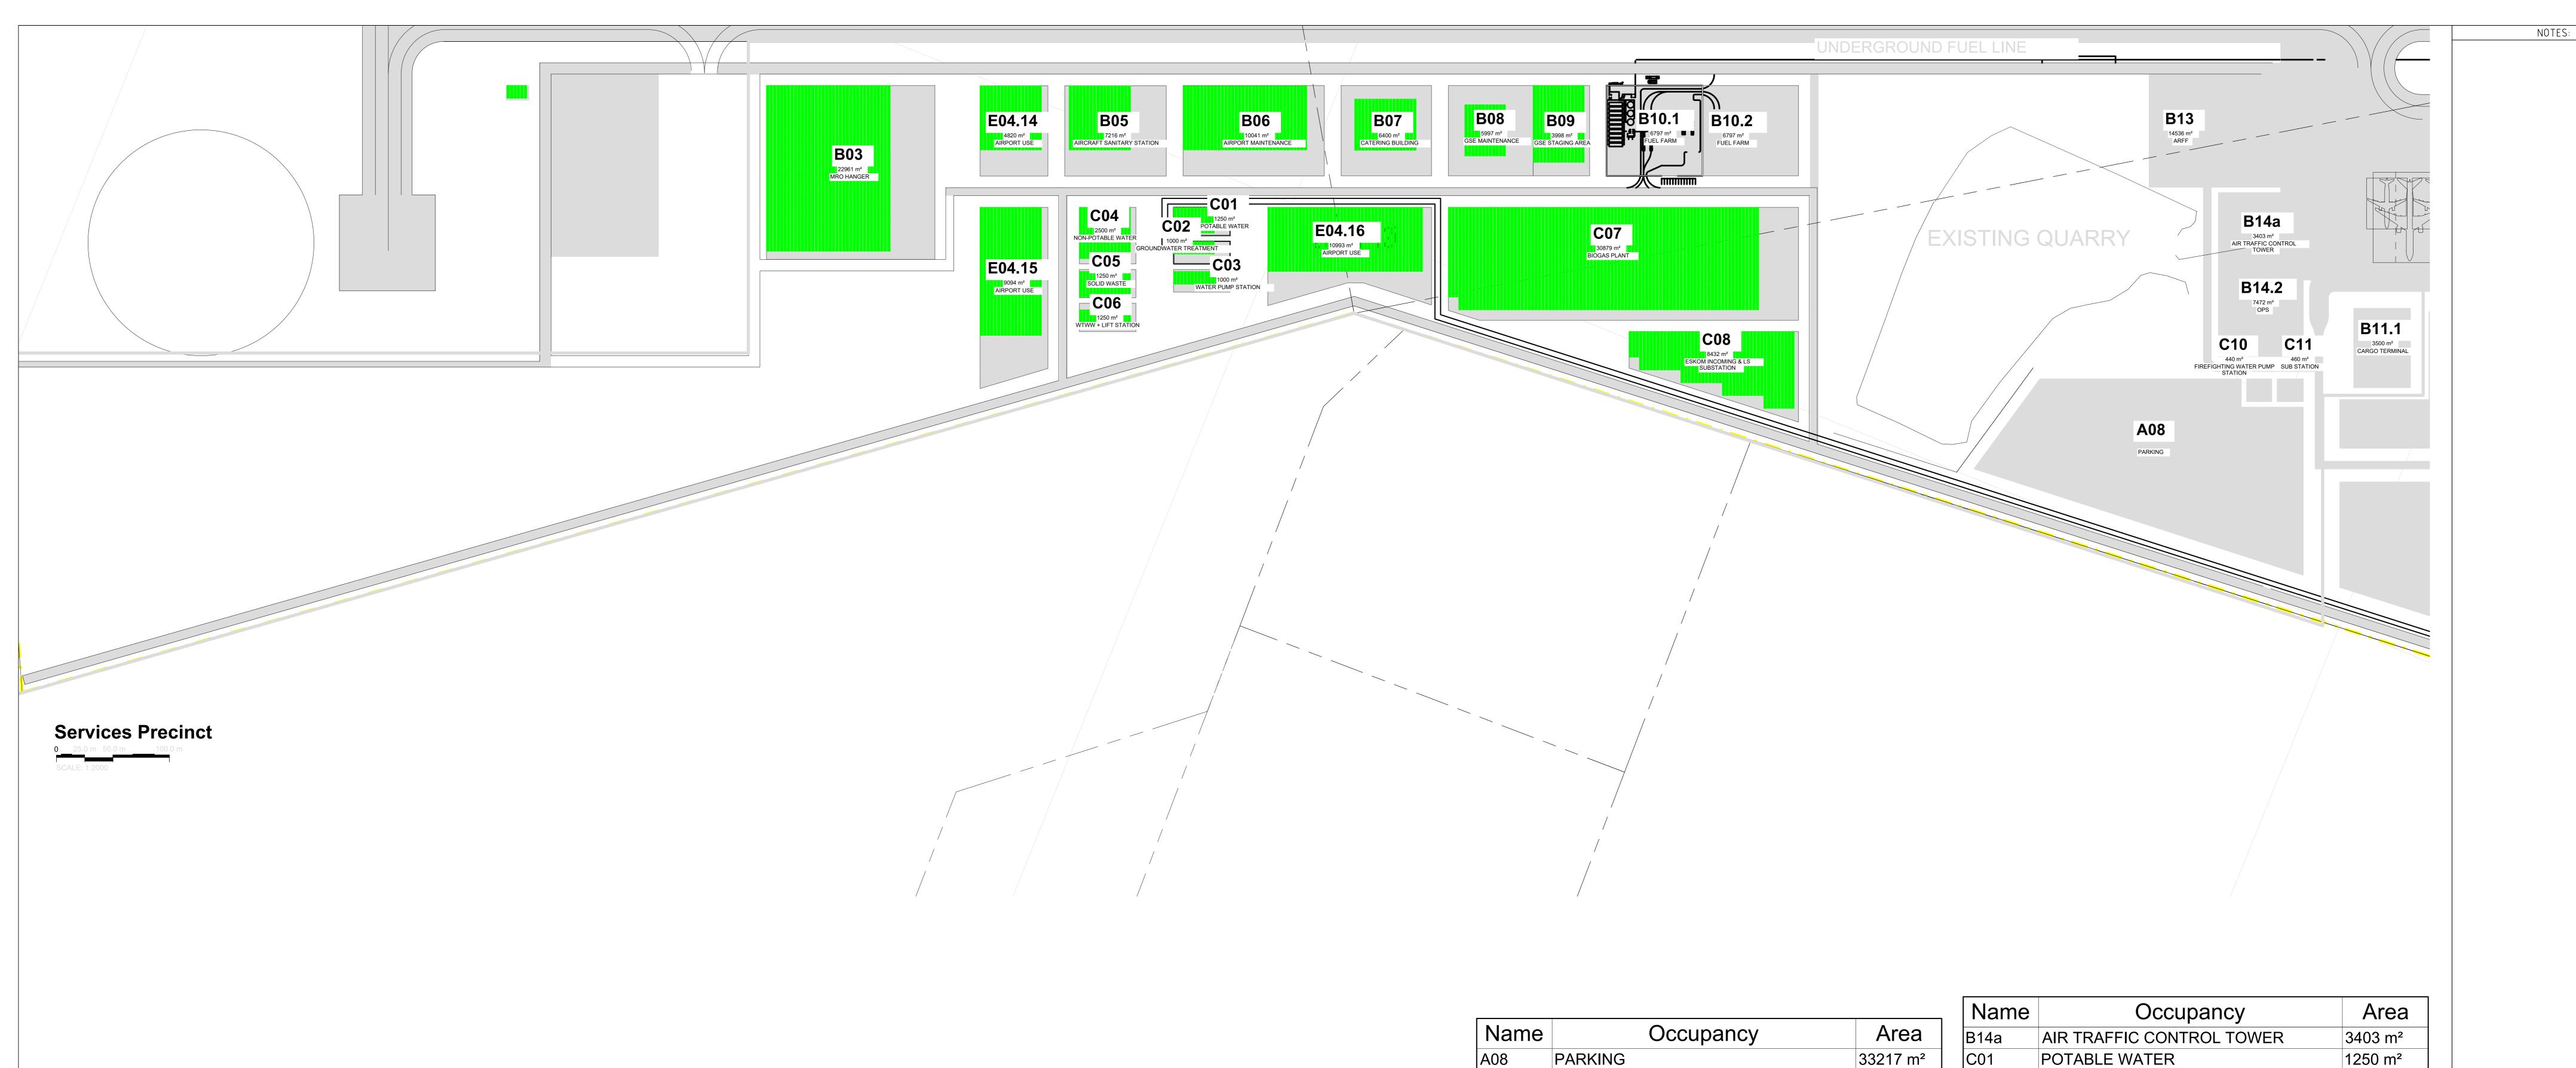

Name	Occupancy	Area
A08	PARKING	33217 m²
B03	MRO HANGER	22961 m ²
B05	AIRCRAFT SANITARY STATION	7216 m ²
B06	AIRPORT MAINTENANCE	10041 m²
B07	CATERING BUILDING	6400 m ²
B08	GSE MAINTENANCE	5997 m ²
B09	GSE STAGING AREA	3998 m²
B09	STAGING	3819 m²
B10.1	FUEL FARM	6797 m²
B10.2	FUEL FARM	6797 m²
B11.1	CARGO TERMINAL	3500 m ²
B13	ARFF	14536 m²
B14.2	OPS	7472 m ²

Name	Occupancy	Area
314a	AIR TRAFFIC CONTROL TOWER	3403 m ²
C01	POTABLE WATER	1250 m ²
02	GROUNDWATER TREATMENT	1000 m ²
203	WATER PUMP STATION	1000 m ²
C04	NON-POTABLE WATER	2500 m ²
C05	SOLID WASTE	1250 m ²
206	WTWW + LIFT STATION	1250 m ²
C07	BIOGAS PLANT	30879 m ²
208	ESKOM INCOMING & LS SUBSTATION	8432 m²
C10	FIREFIGHTING WATER PUMP STATION	440 m ²

Name	Occupancy	Area
C11	SUB STATION	460 m ²
E04.14	AIRPORT USE	4820 m²
E04.15	AIRPORT USE	9094 m²
E04.16	AIRPORT USE	10993 m ²

MRO FBO GA GSE ARFF FATO WTWP/WTWW RDTS PAPI

Maintenance Repairs and Operations
Fixed Based Operators
General Aviation
Ground Support Equipment
Aircraft Rescue and Firefighting
Final Approach and Take-off (Helipad)
Wastewater Treatment Plant / Works
Remote Digital Control Tower System
Precision Approach Path Indicator

16A







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03 REMOVED PANELS FOR GLARE
04/03/2025 AGS CFS CFS
02 FOR INFORMATION
06/08/2024 AGS CFS CFS

 03
 REMOVED PANELS FOR GLARE
 04/03/2025 AGS CFS

 02
 FOR INFORMATION
 20/01/2025 AGS CFS

 01
 FOR INFORMATION
 06/08/2024 AGS CFS

 REV
 DESCRIPTION
 DATE DRN CHI

 REVISIONS

14 Cyclonite Street, The Interchange, Somerset West, 7130
P.O. Box 226
REPUBLIC OF SOUTH AFRICA
Tel: +27 21 852 5095
Fax: +27 21 852 5070
Email: info@selkirkandselkirk.co.za

Email: info@selkirkandselkirk.co.za
PROJECT:

CAPE WINELANDS AERO


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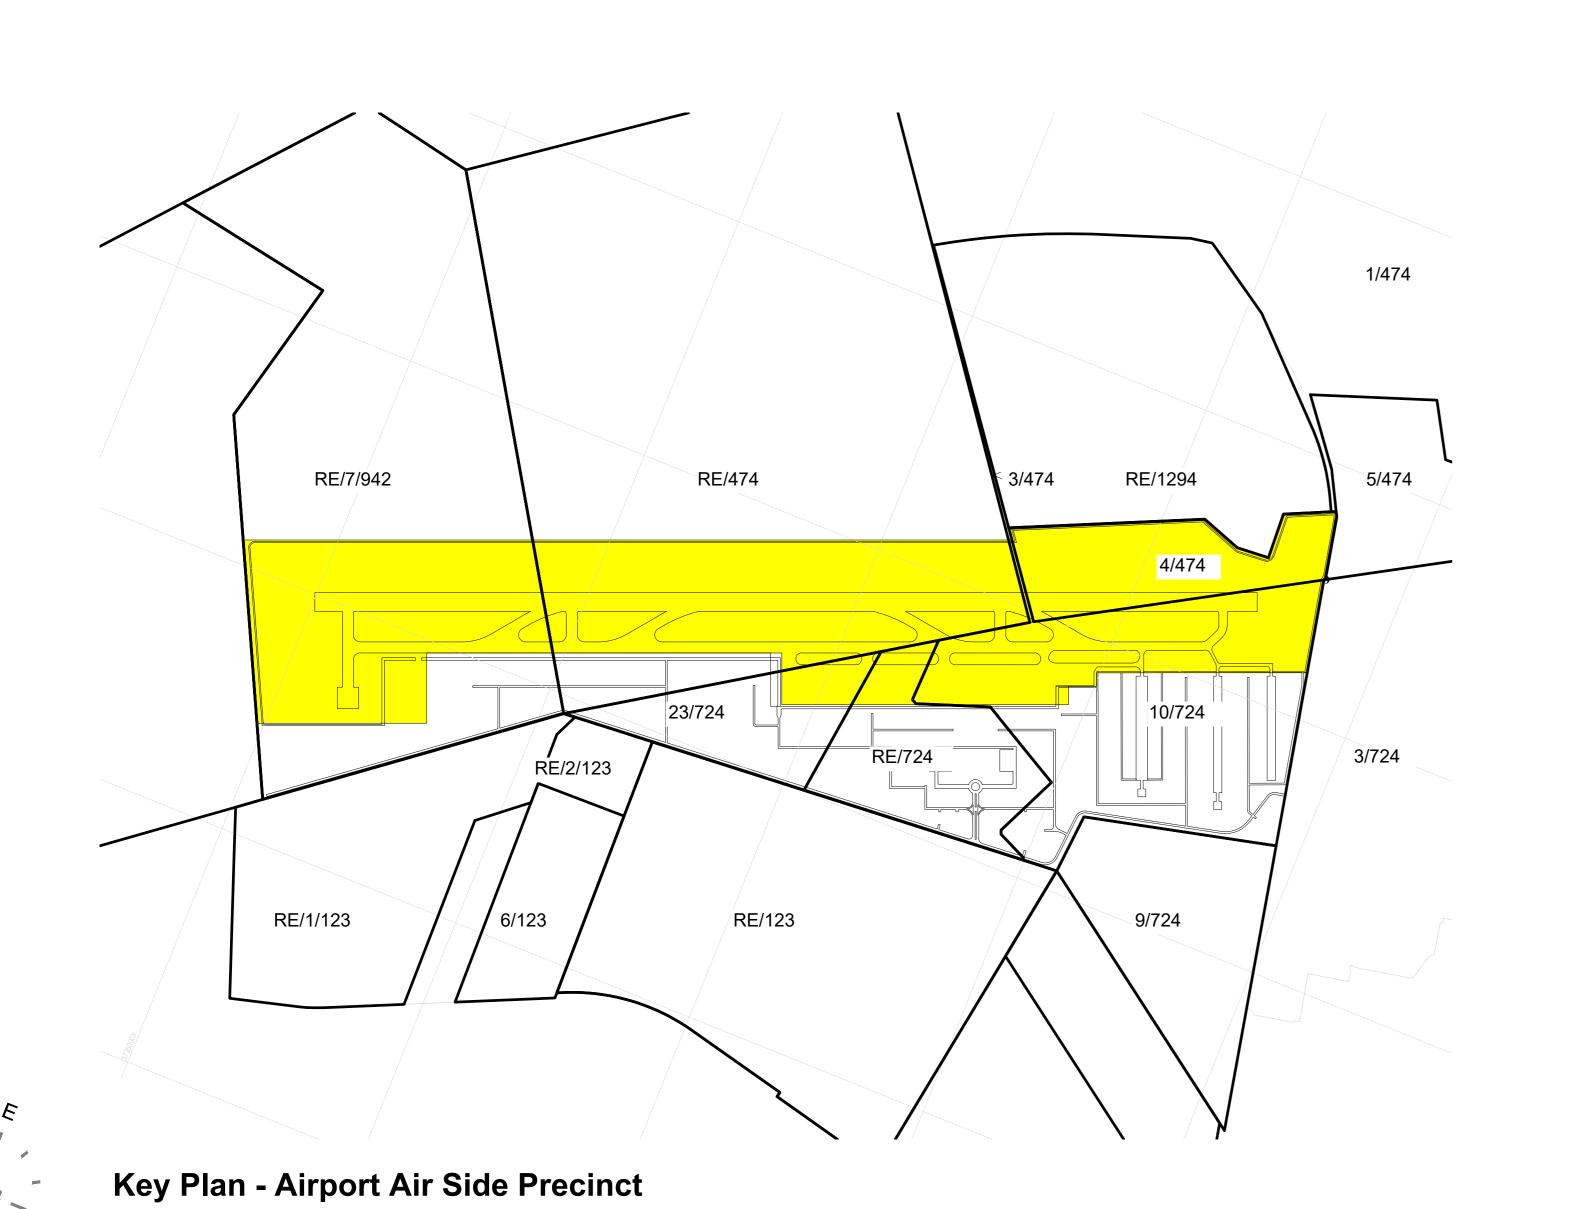
PHASE 2 SERVICES PRECINCT PV ARRANGMENT

 DESIGN
 DATE
 DRG NUMBER
 REV
 SCALE
 SIZE

 CFS
 04/03/2025
 E558-2004
 03
 A0

Key Plan - Services Precinct



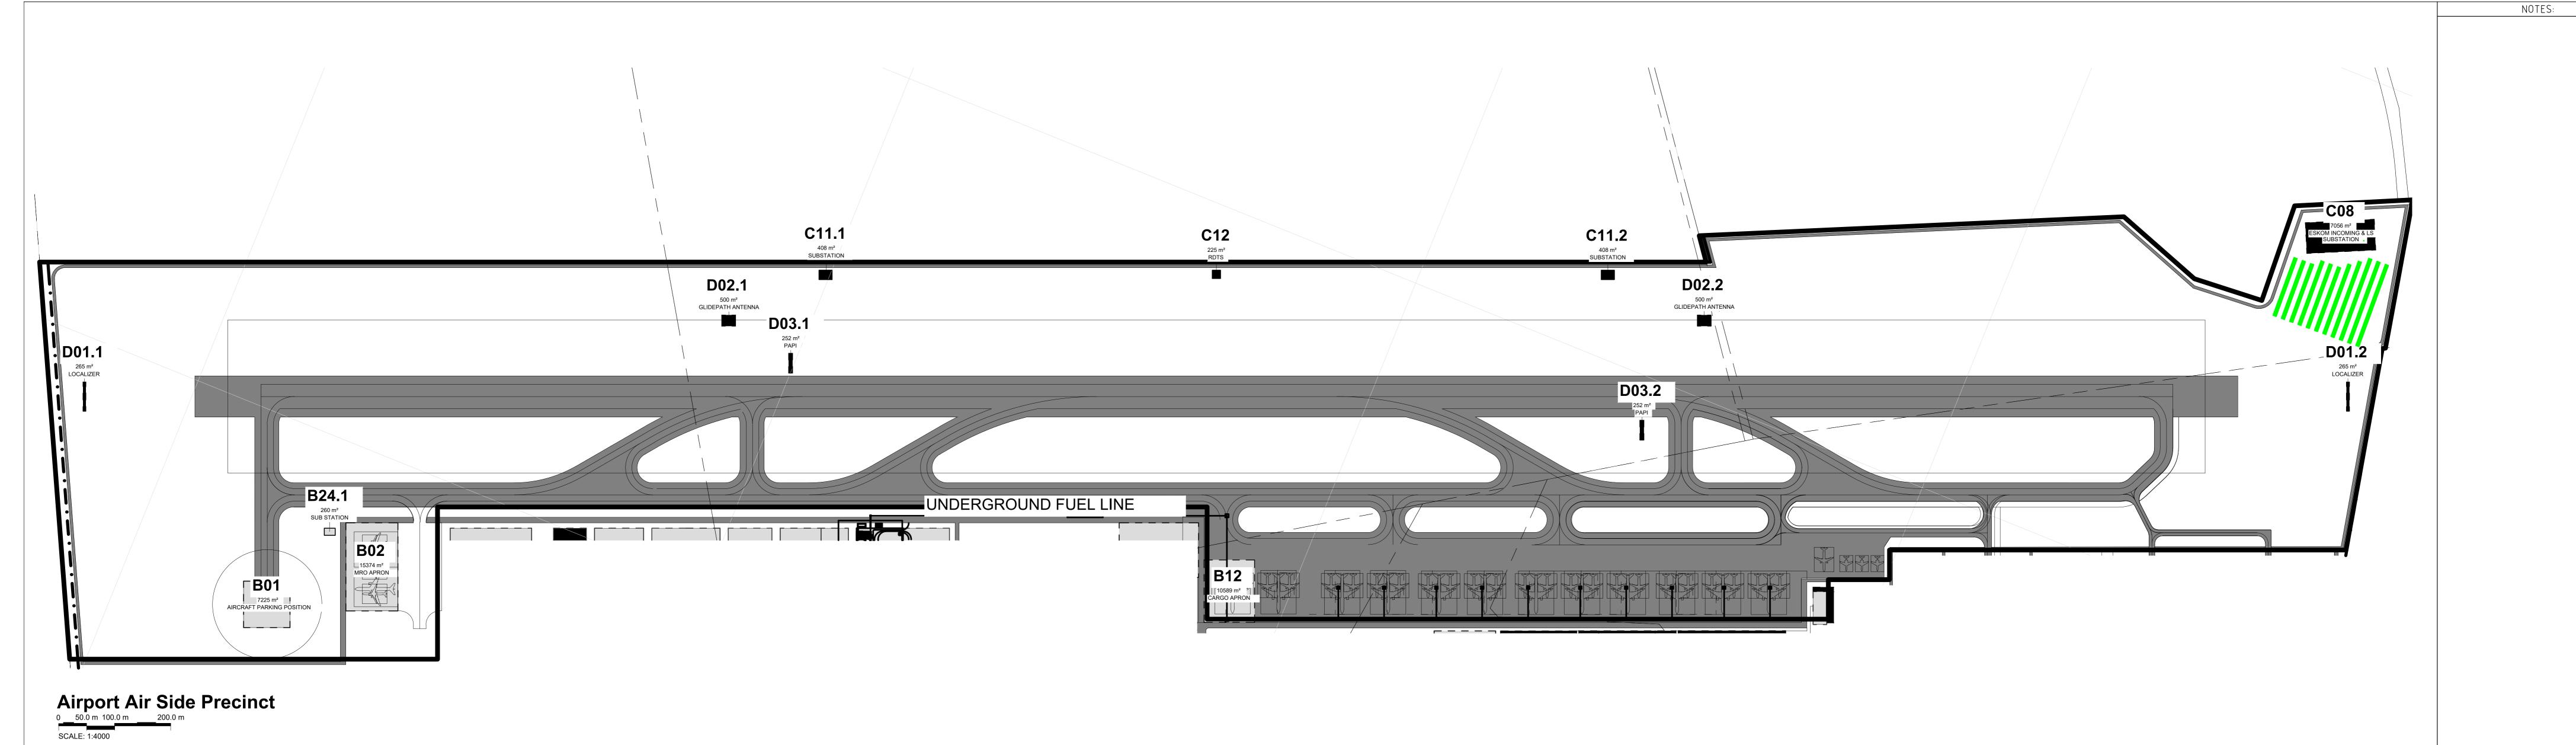


Name	Occupancy	Area
B01	AIRCRAFT PARKING POSITION	7225 m ²
B02	MRO APRON	15374 m²
B12	CARGO APRON	10589 m²
B24.1	SUB STATION	260 m ²


MRO FBO GA GSE ARFF FATO WTWP/WTWW RDTS	Maintenance Repairs and Operations Fixed Based Operators General Aviation Ground Support Equipment Aircraft Rescue and Firefighting Final Approach and Take-off (Helipad) Wastewater Treatment Plant / Works Remote Digital Control Tower System
RDTS	Remote Digital Control Tower System
PAPI	Precision Approach Path Indicator

Name	Occupancy	Area
C08	ESKOM INCOMING & LS SUBSTATION	7056 m²
C11.1	SUBSTATION	408 m ²
C11.2	SUBSTATION	408 m²
C12	RDTS	225 m ²
D01.1	LOCALIZER	265 m ²
D01.2	LOCALIZER	265 m ²
D02.1	GLIDEPATH ANTENNA	500 m ²
D02.2	GLIDEPATH ANTENNA	500 m ²
D03.1	PAPI	252 m²
D03.2	PAPI	252 m²

248.41 ha

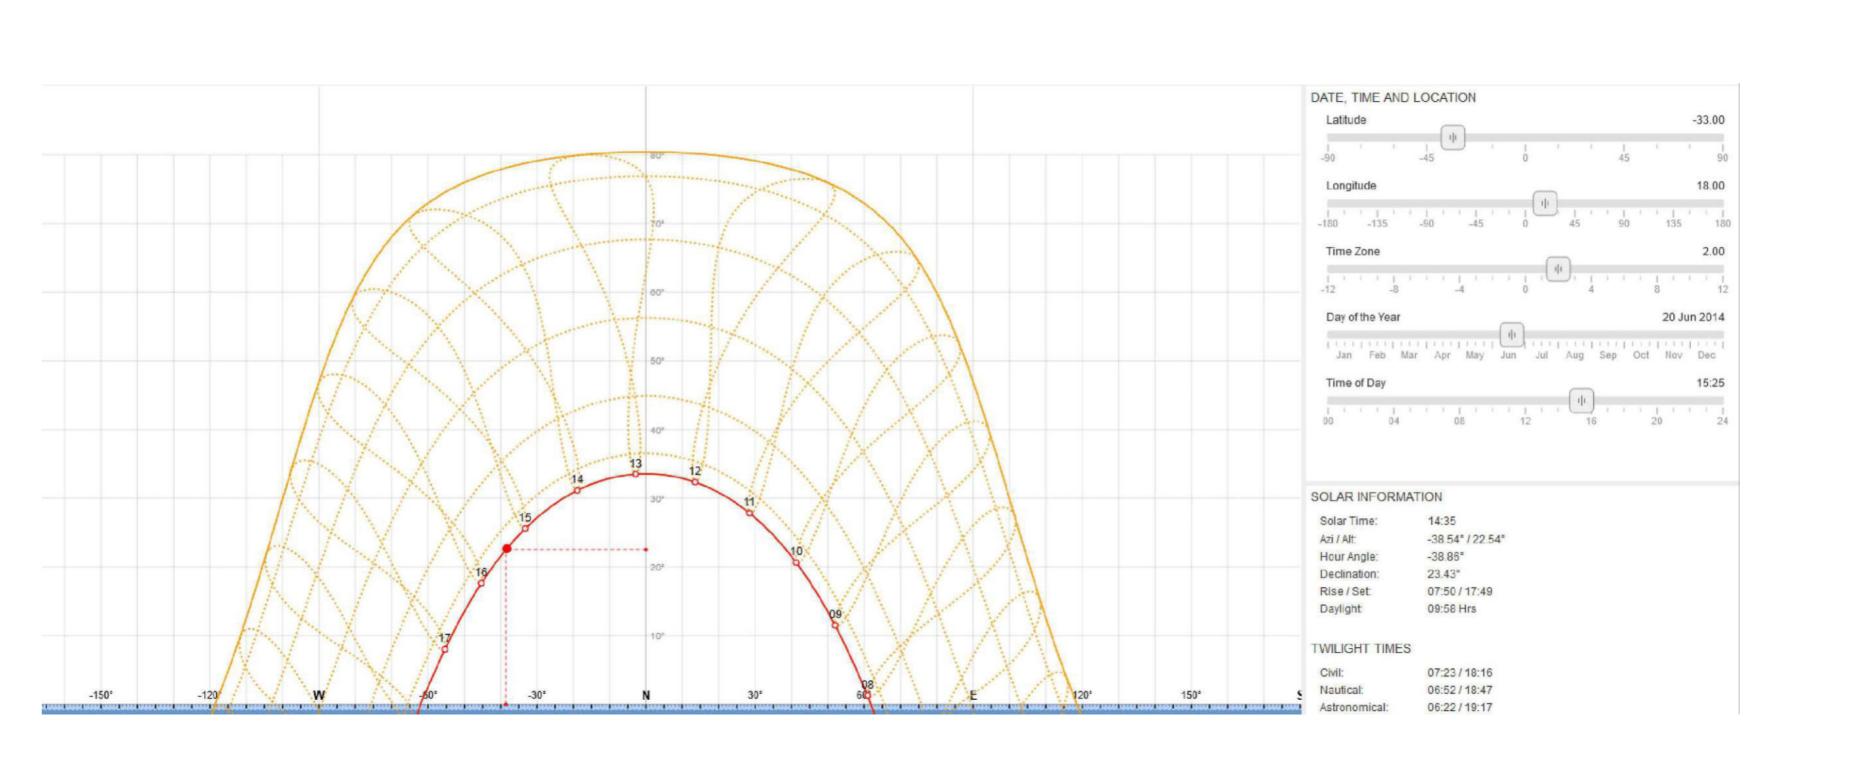



16b

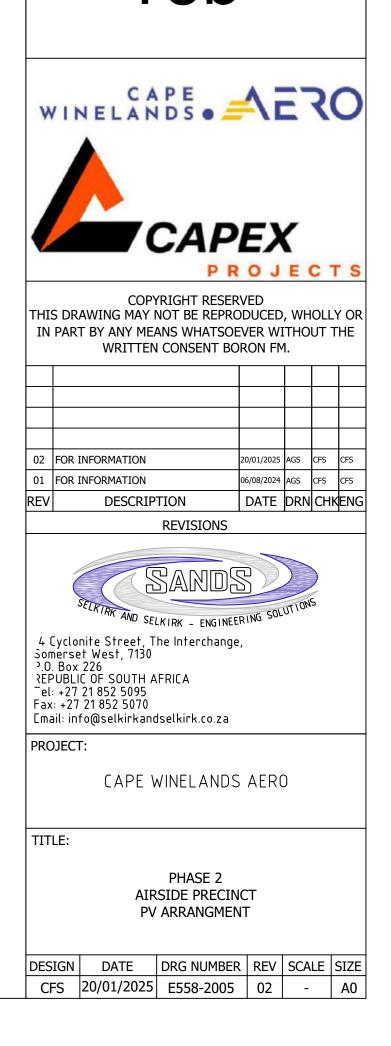








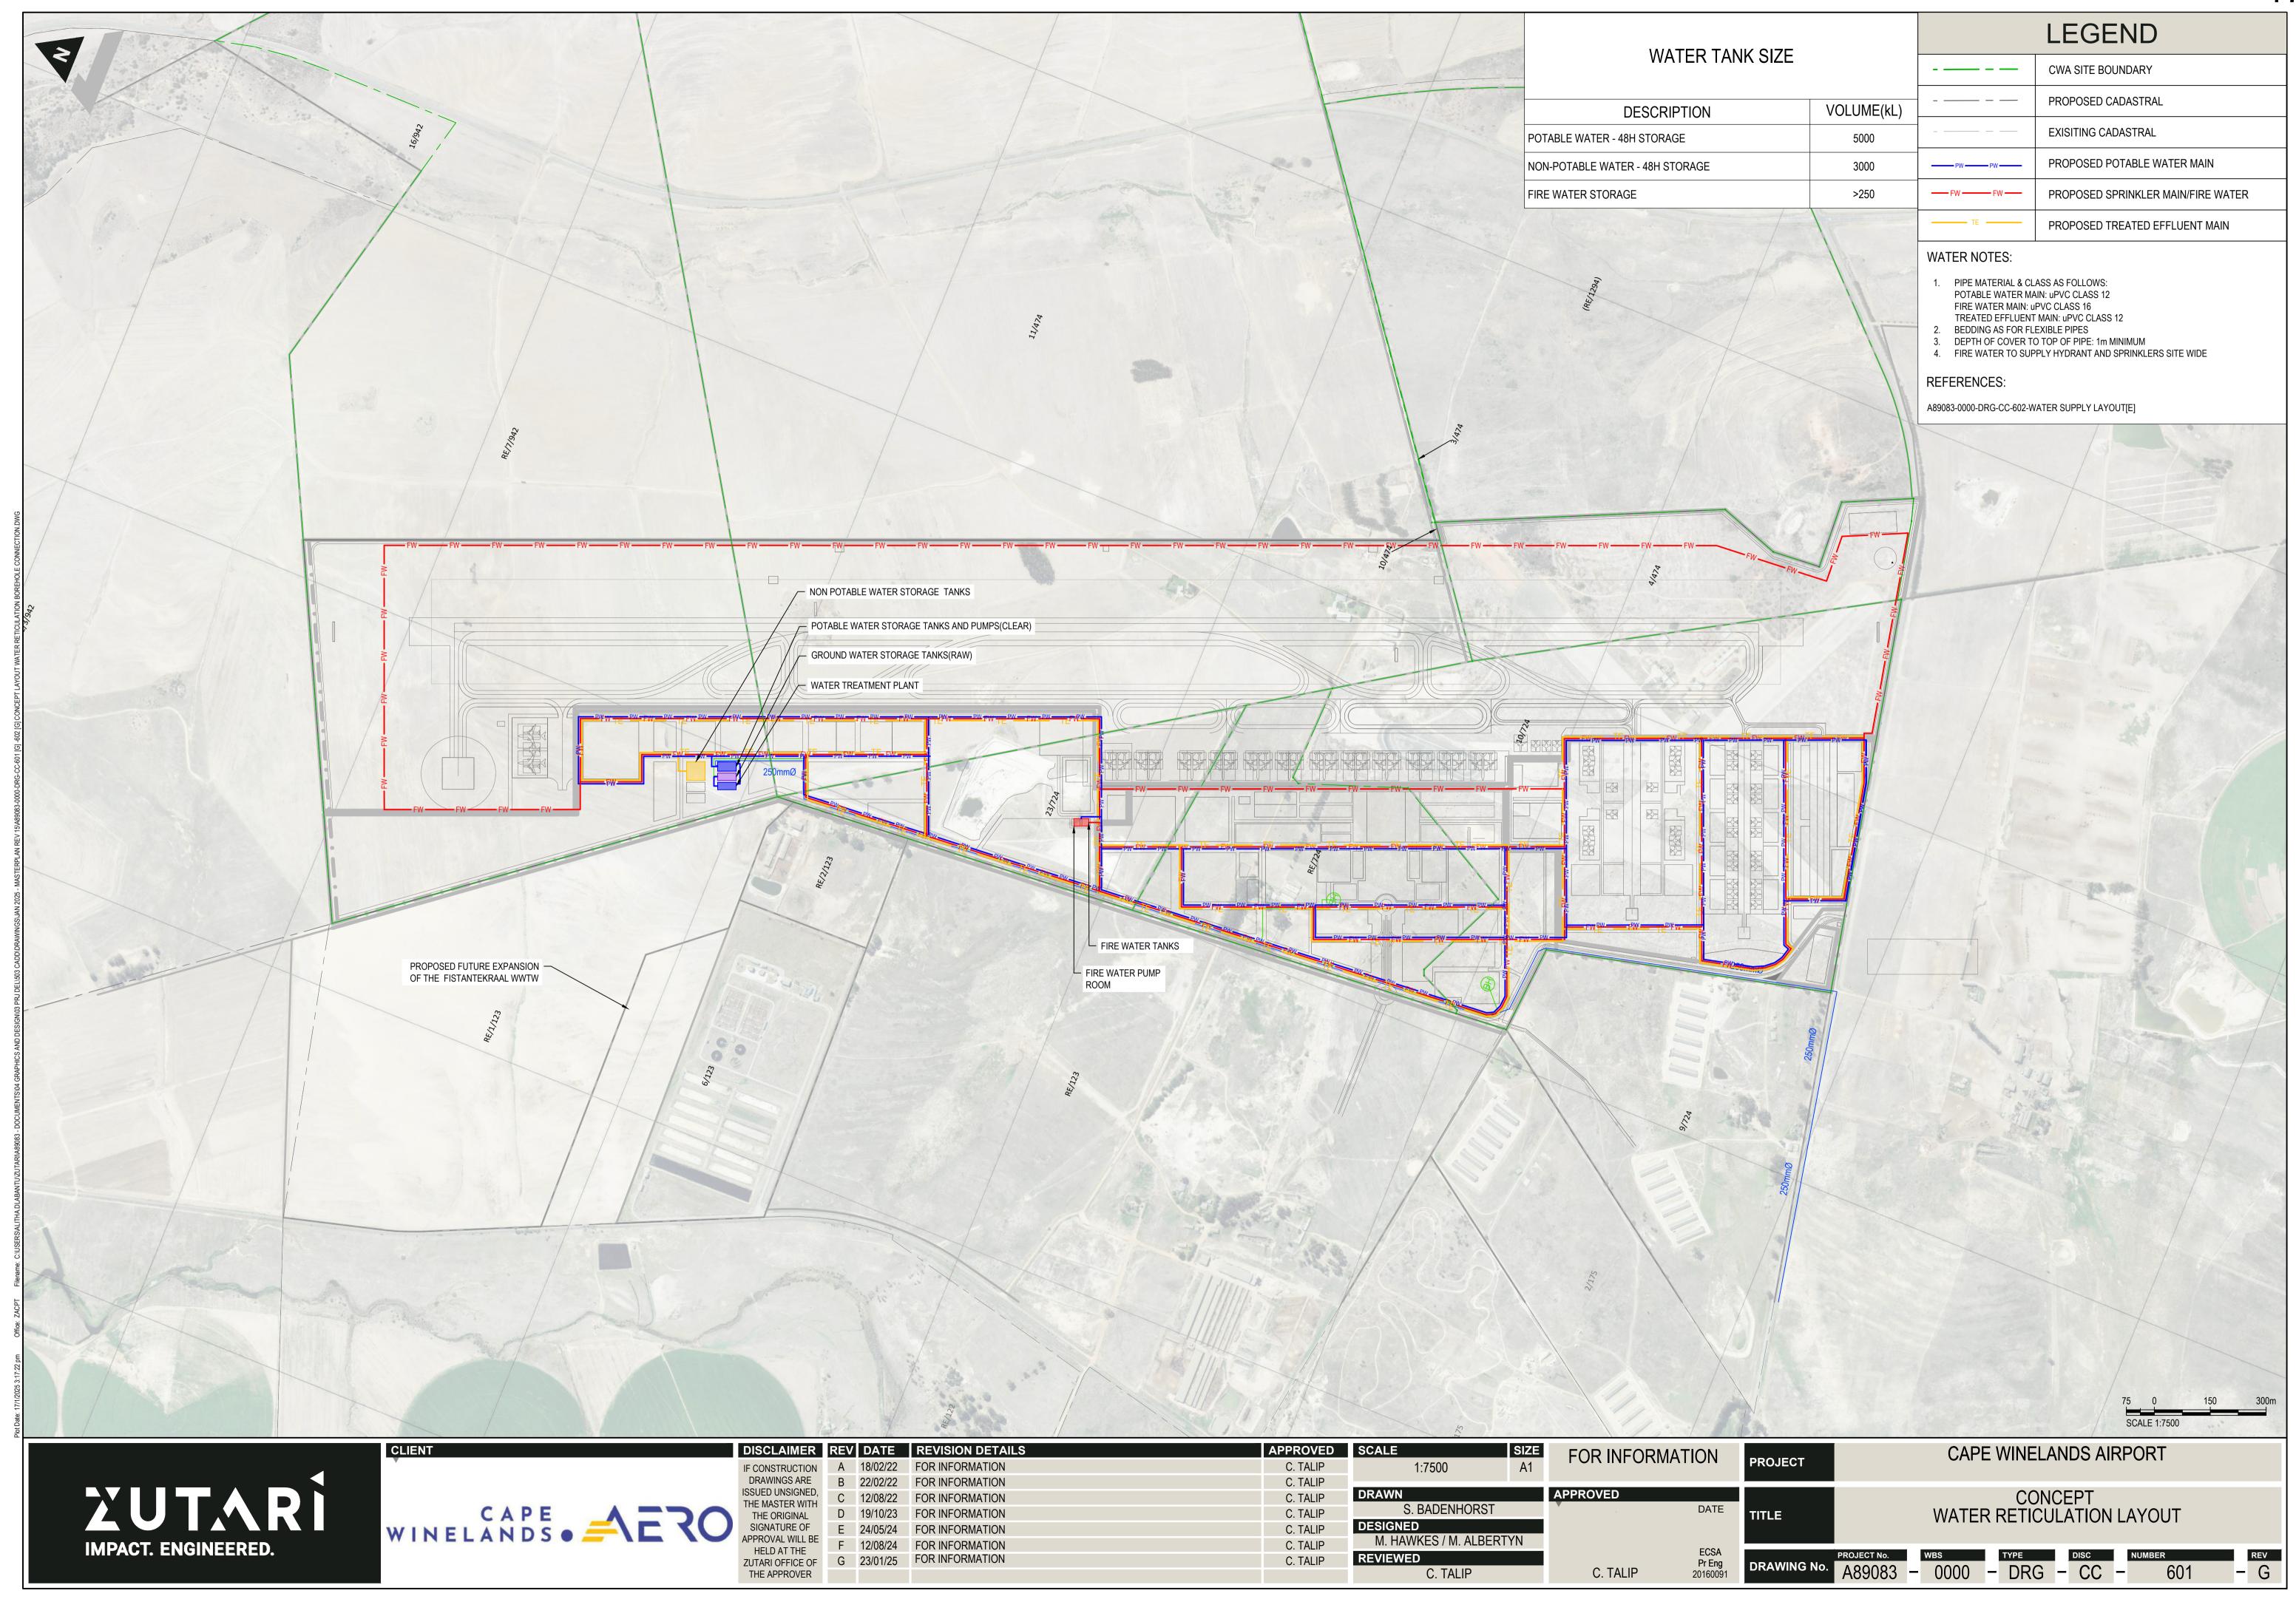


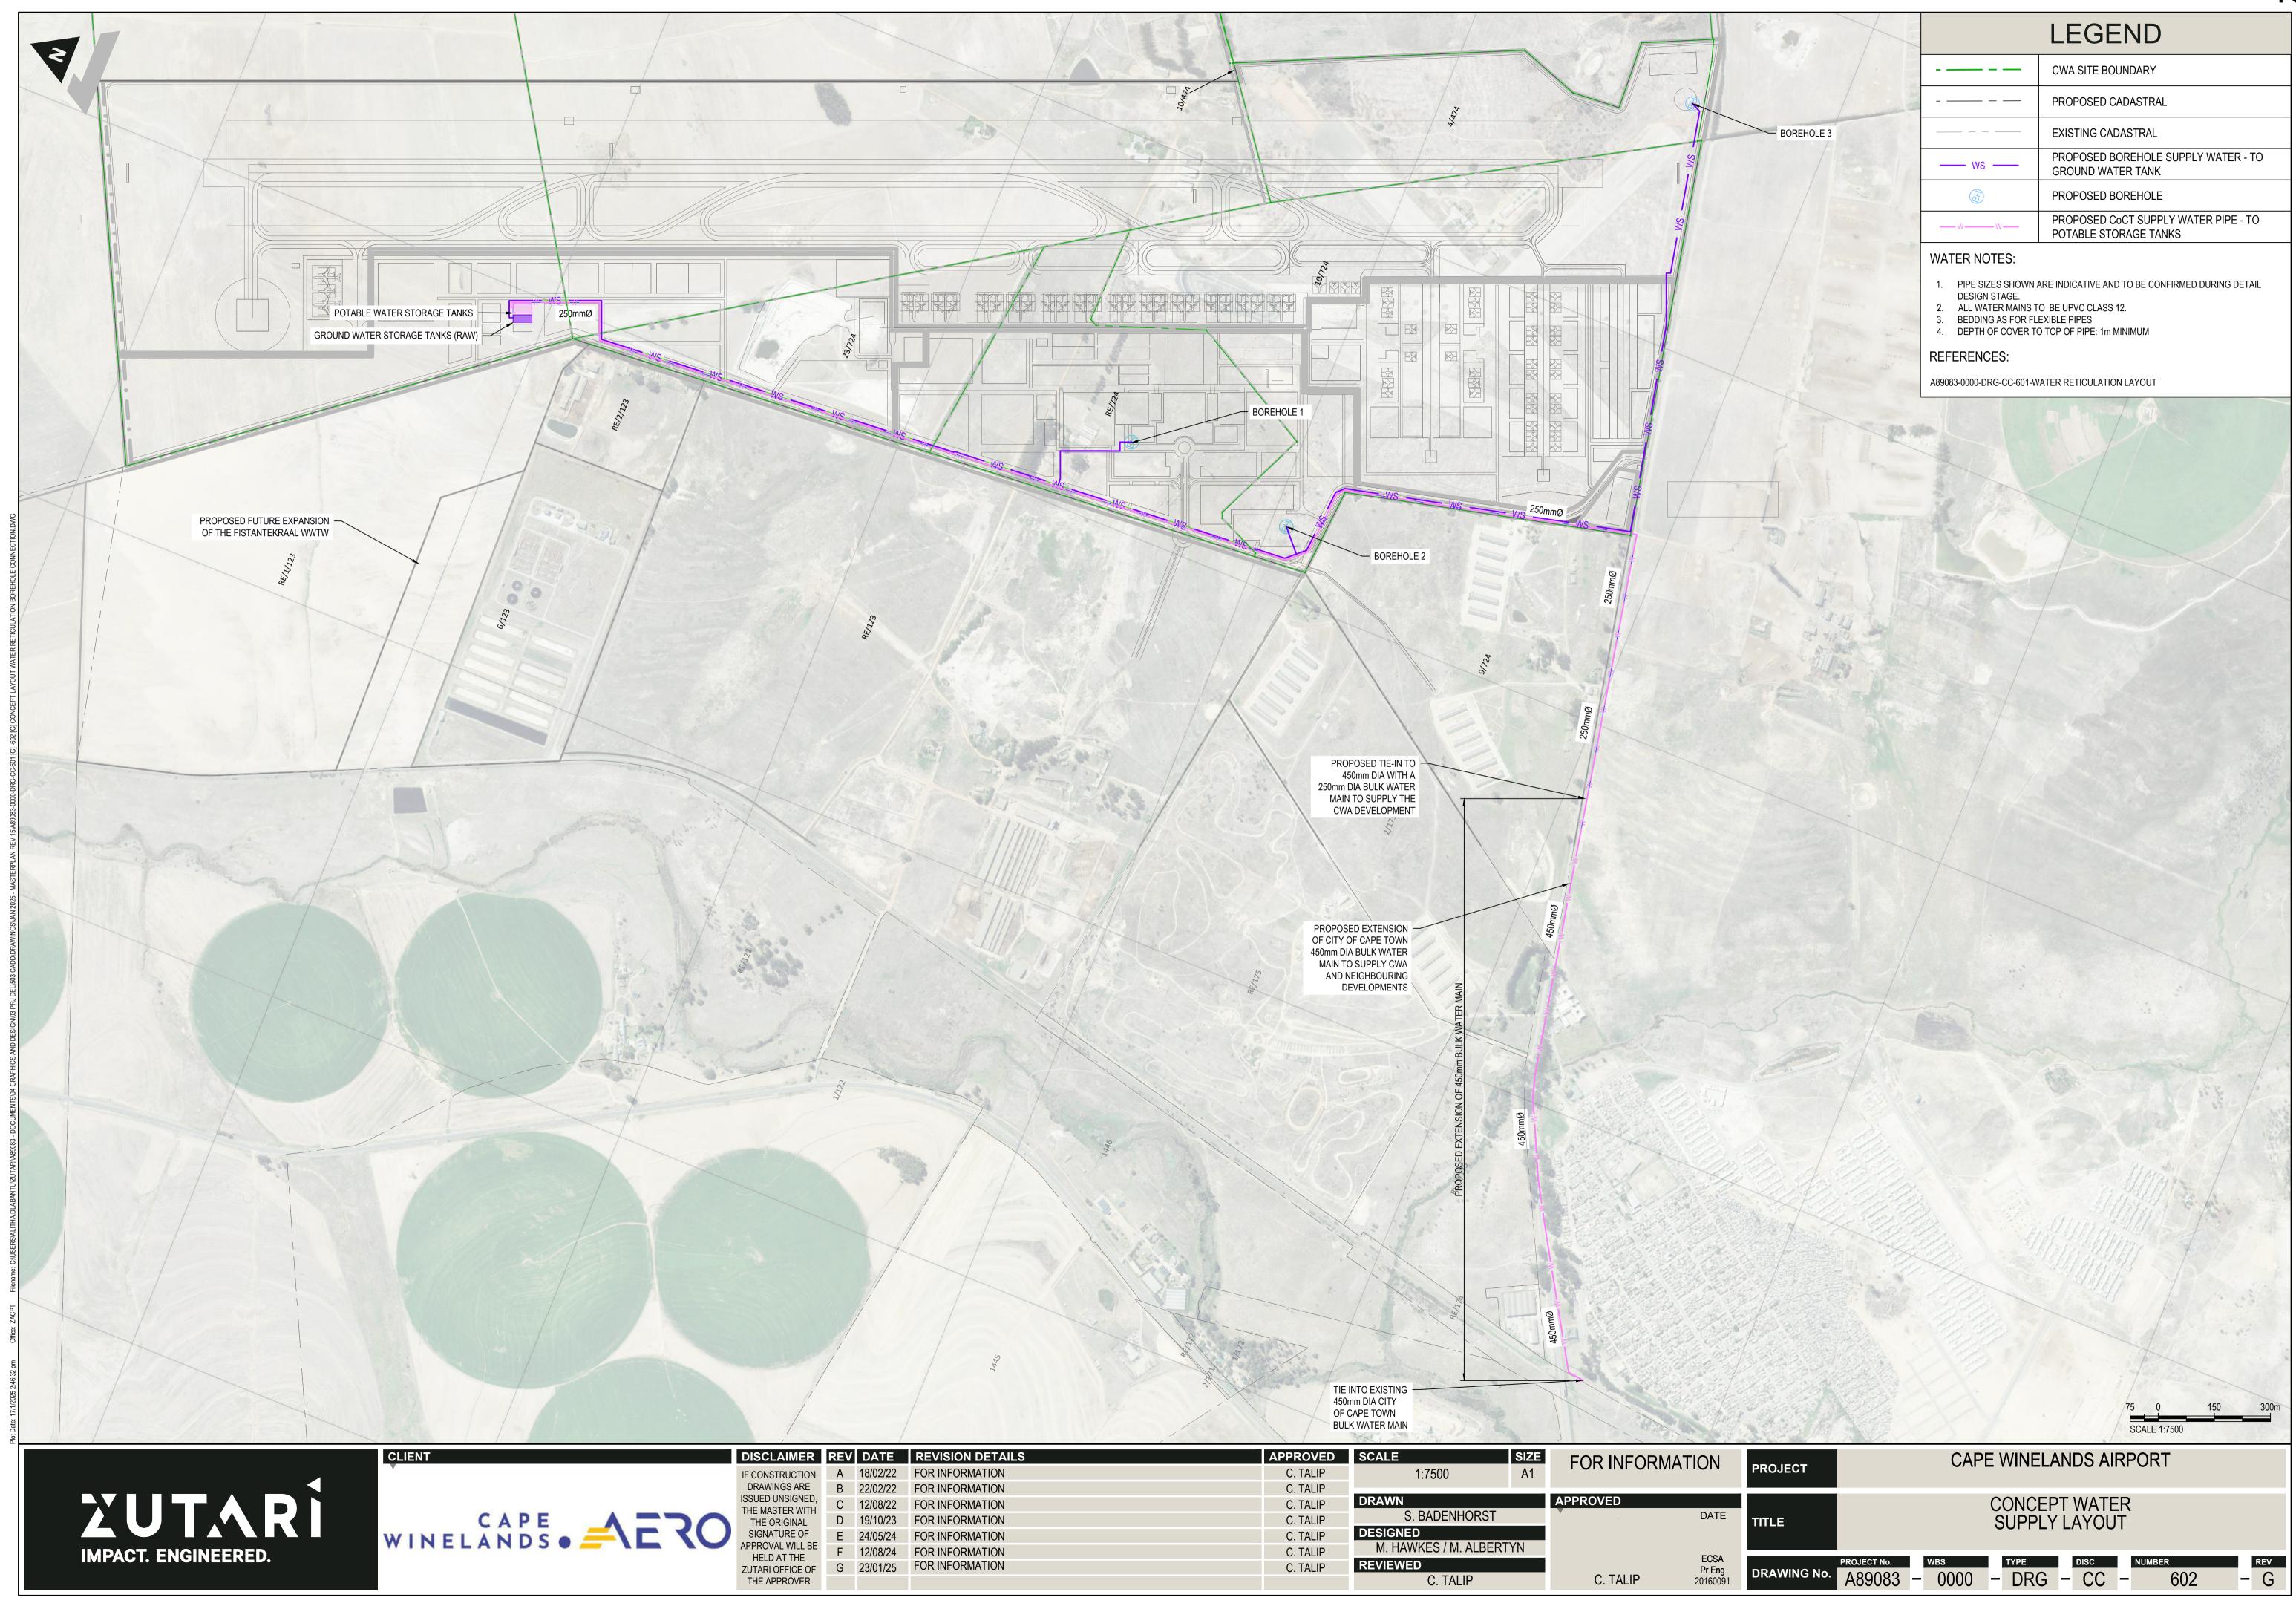


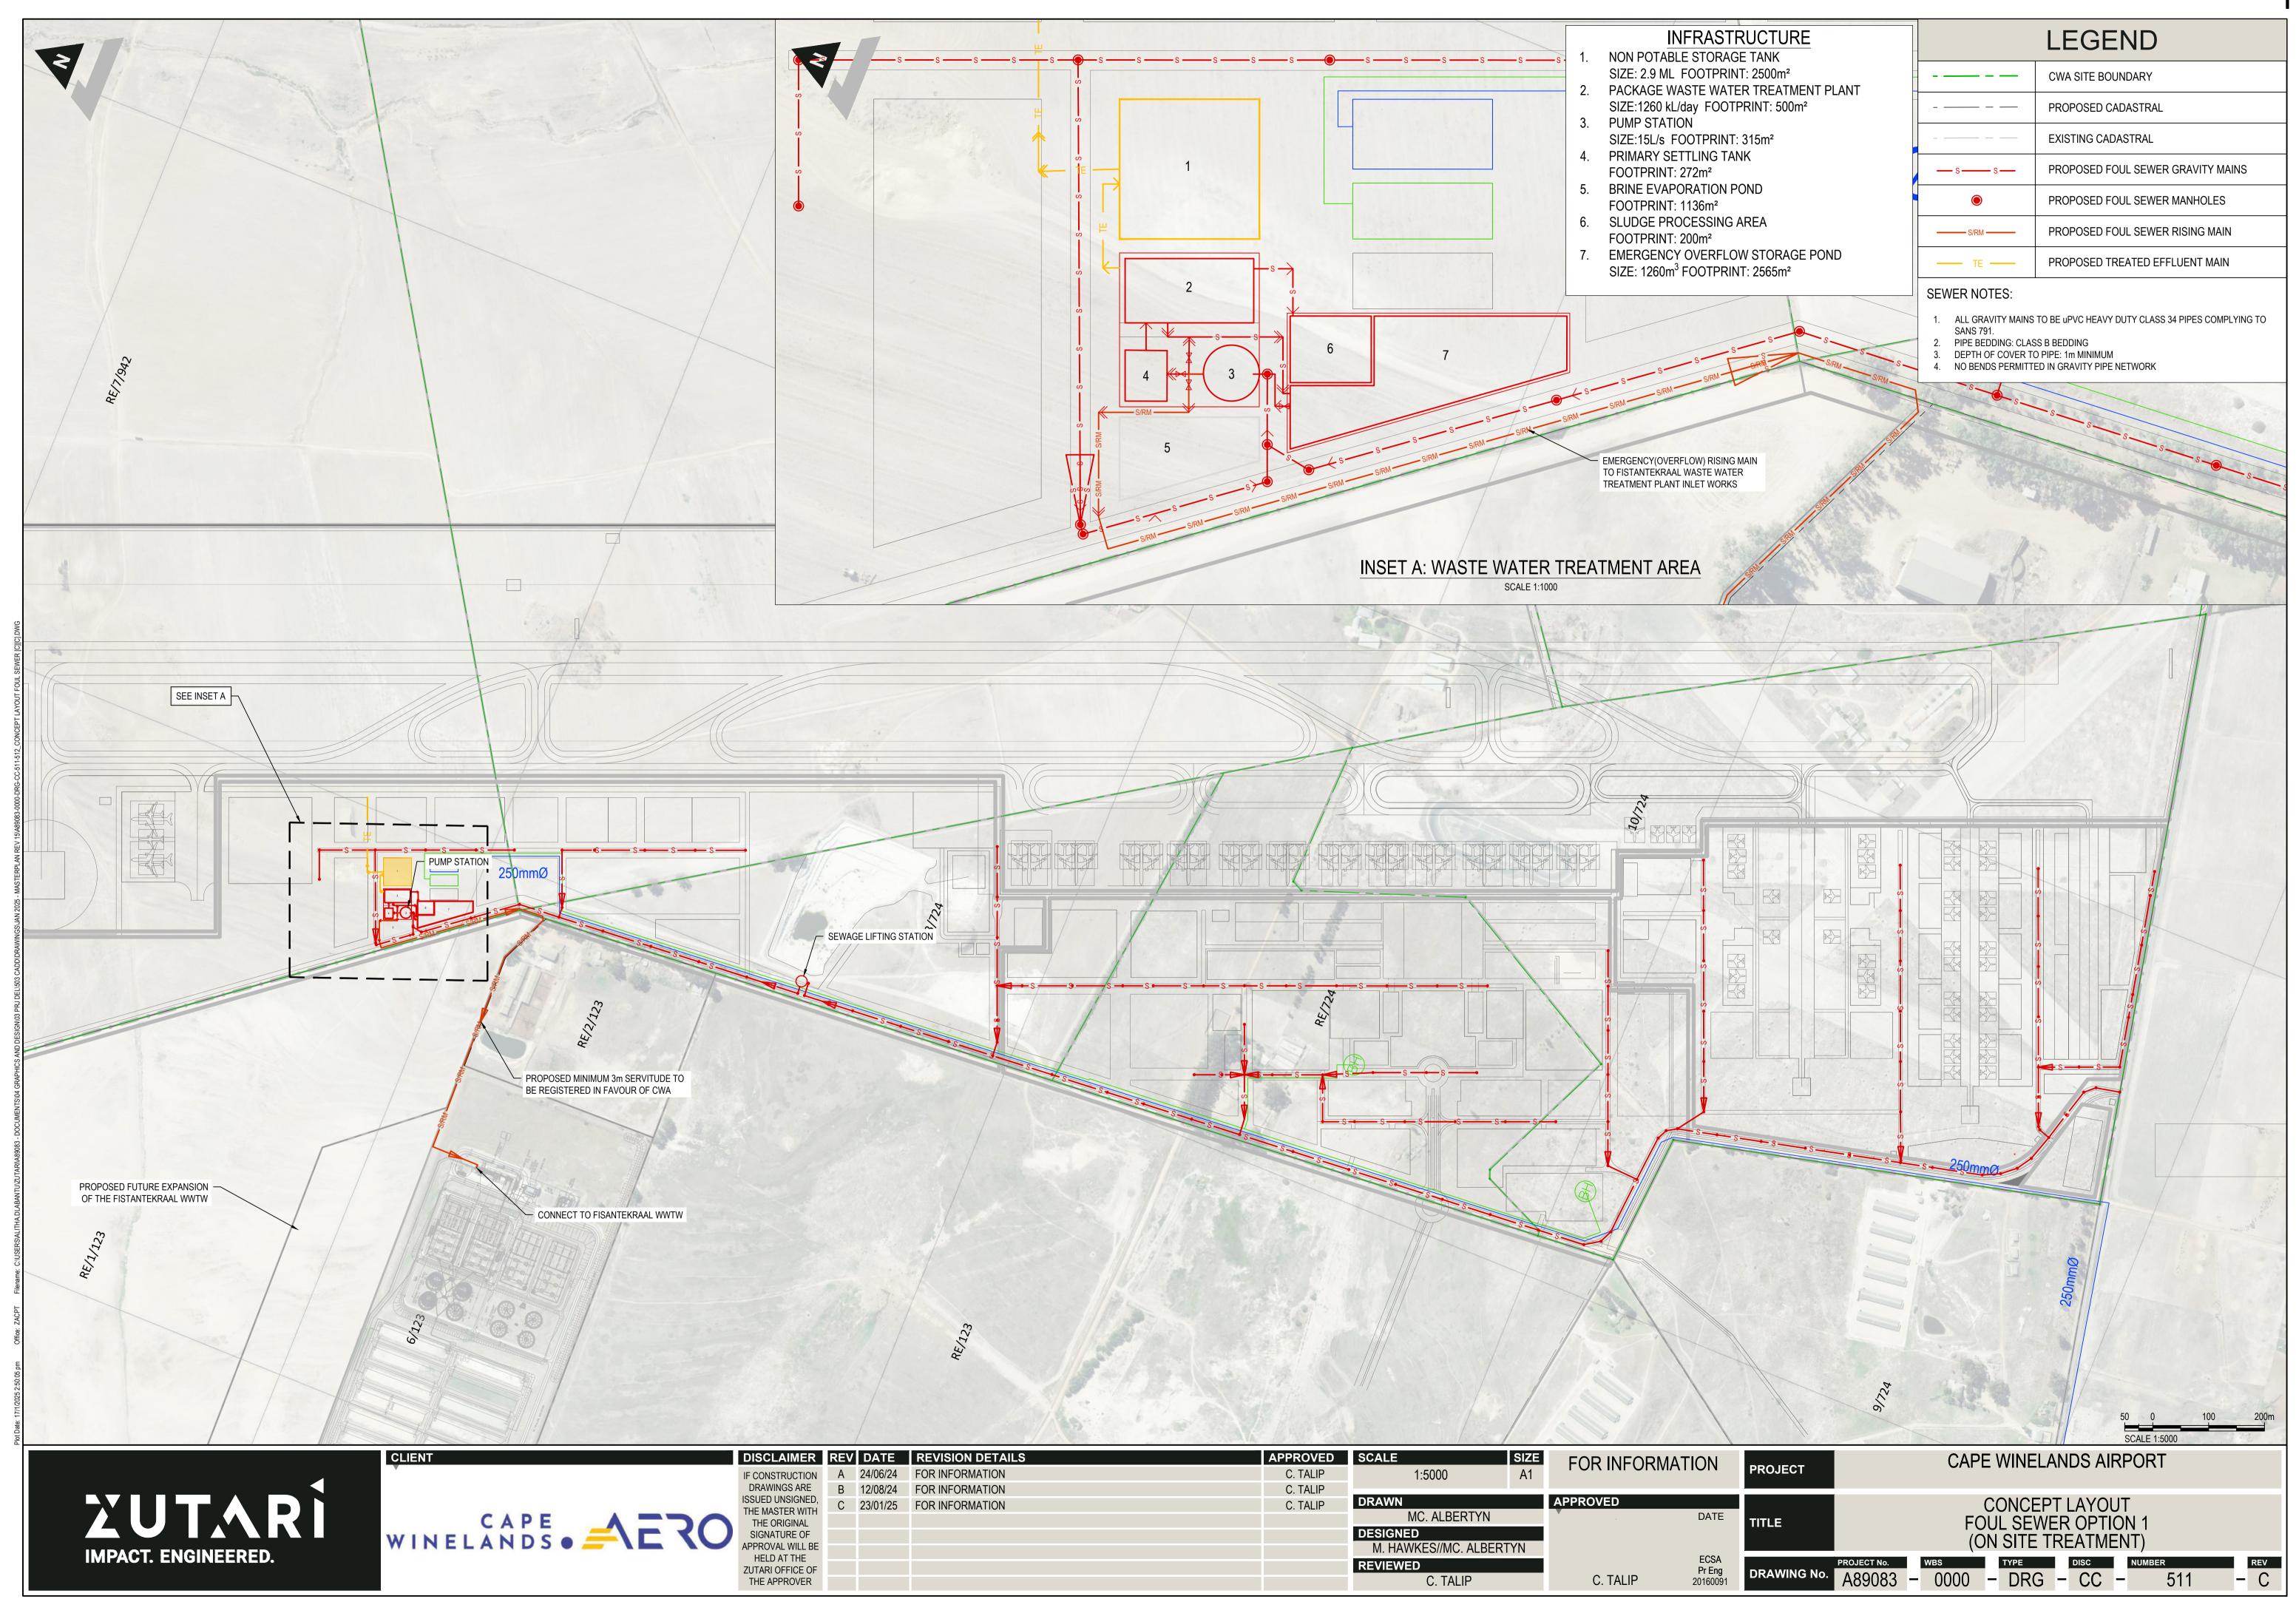


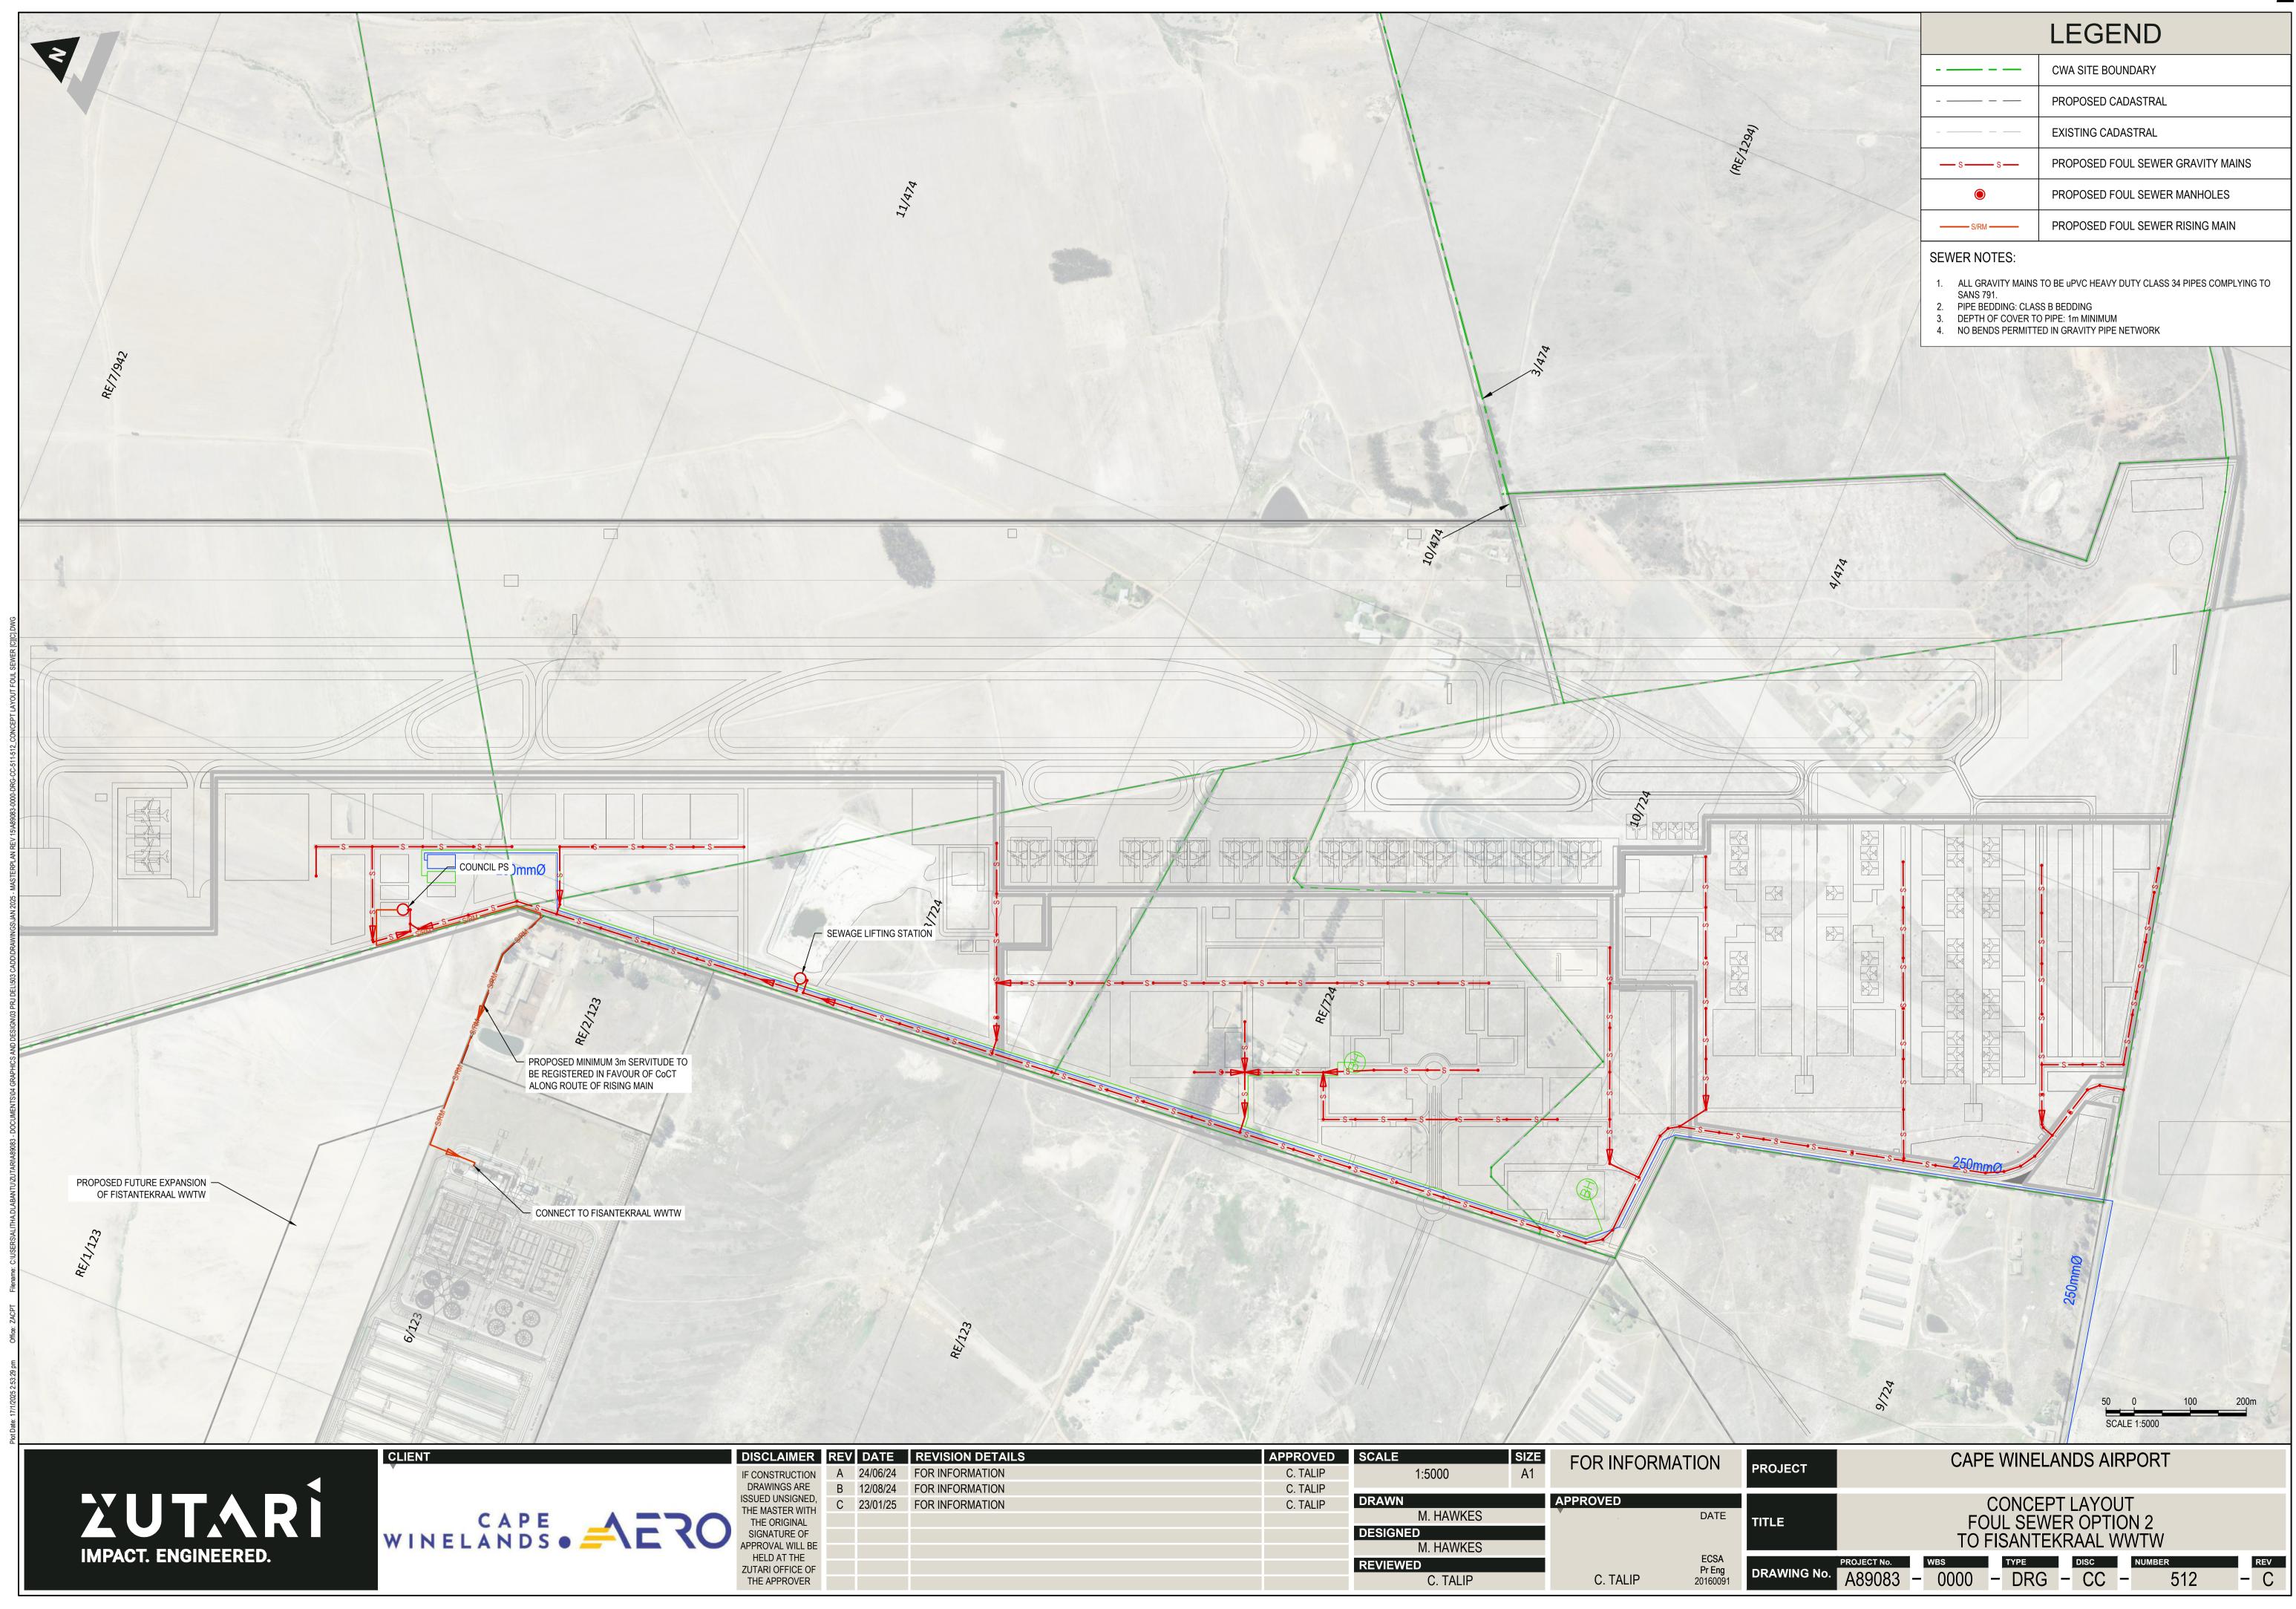


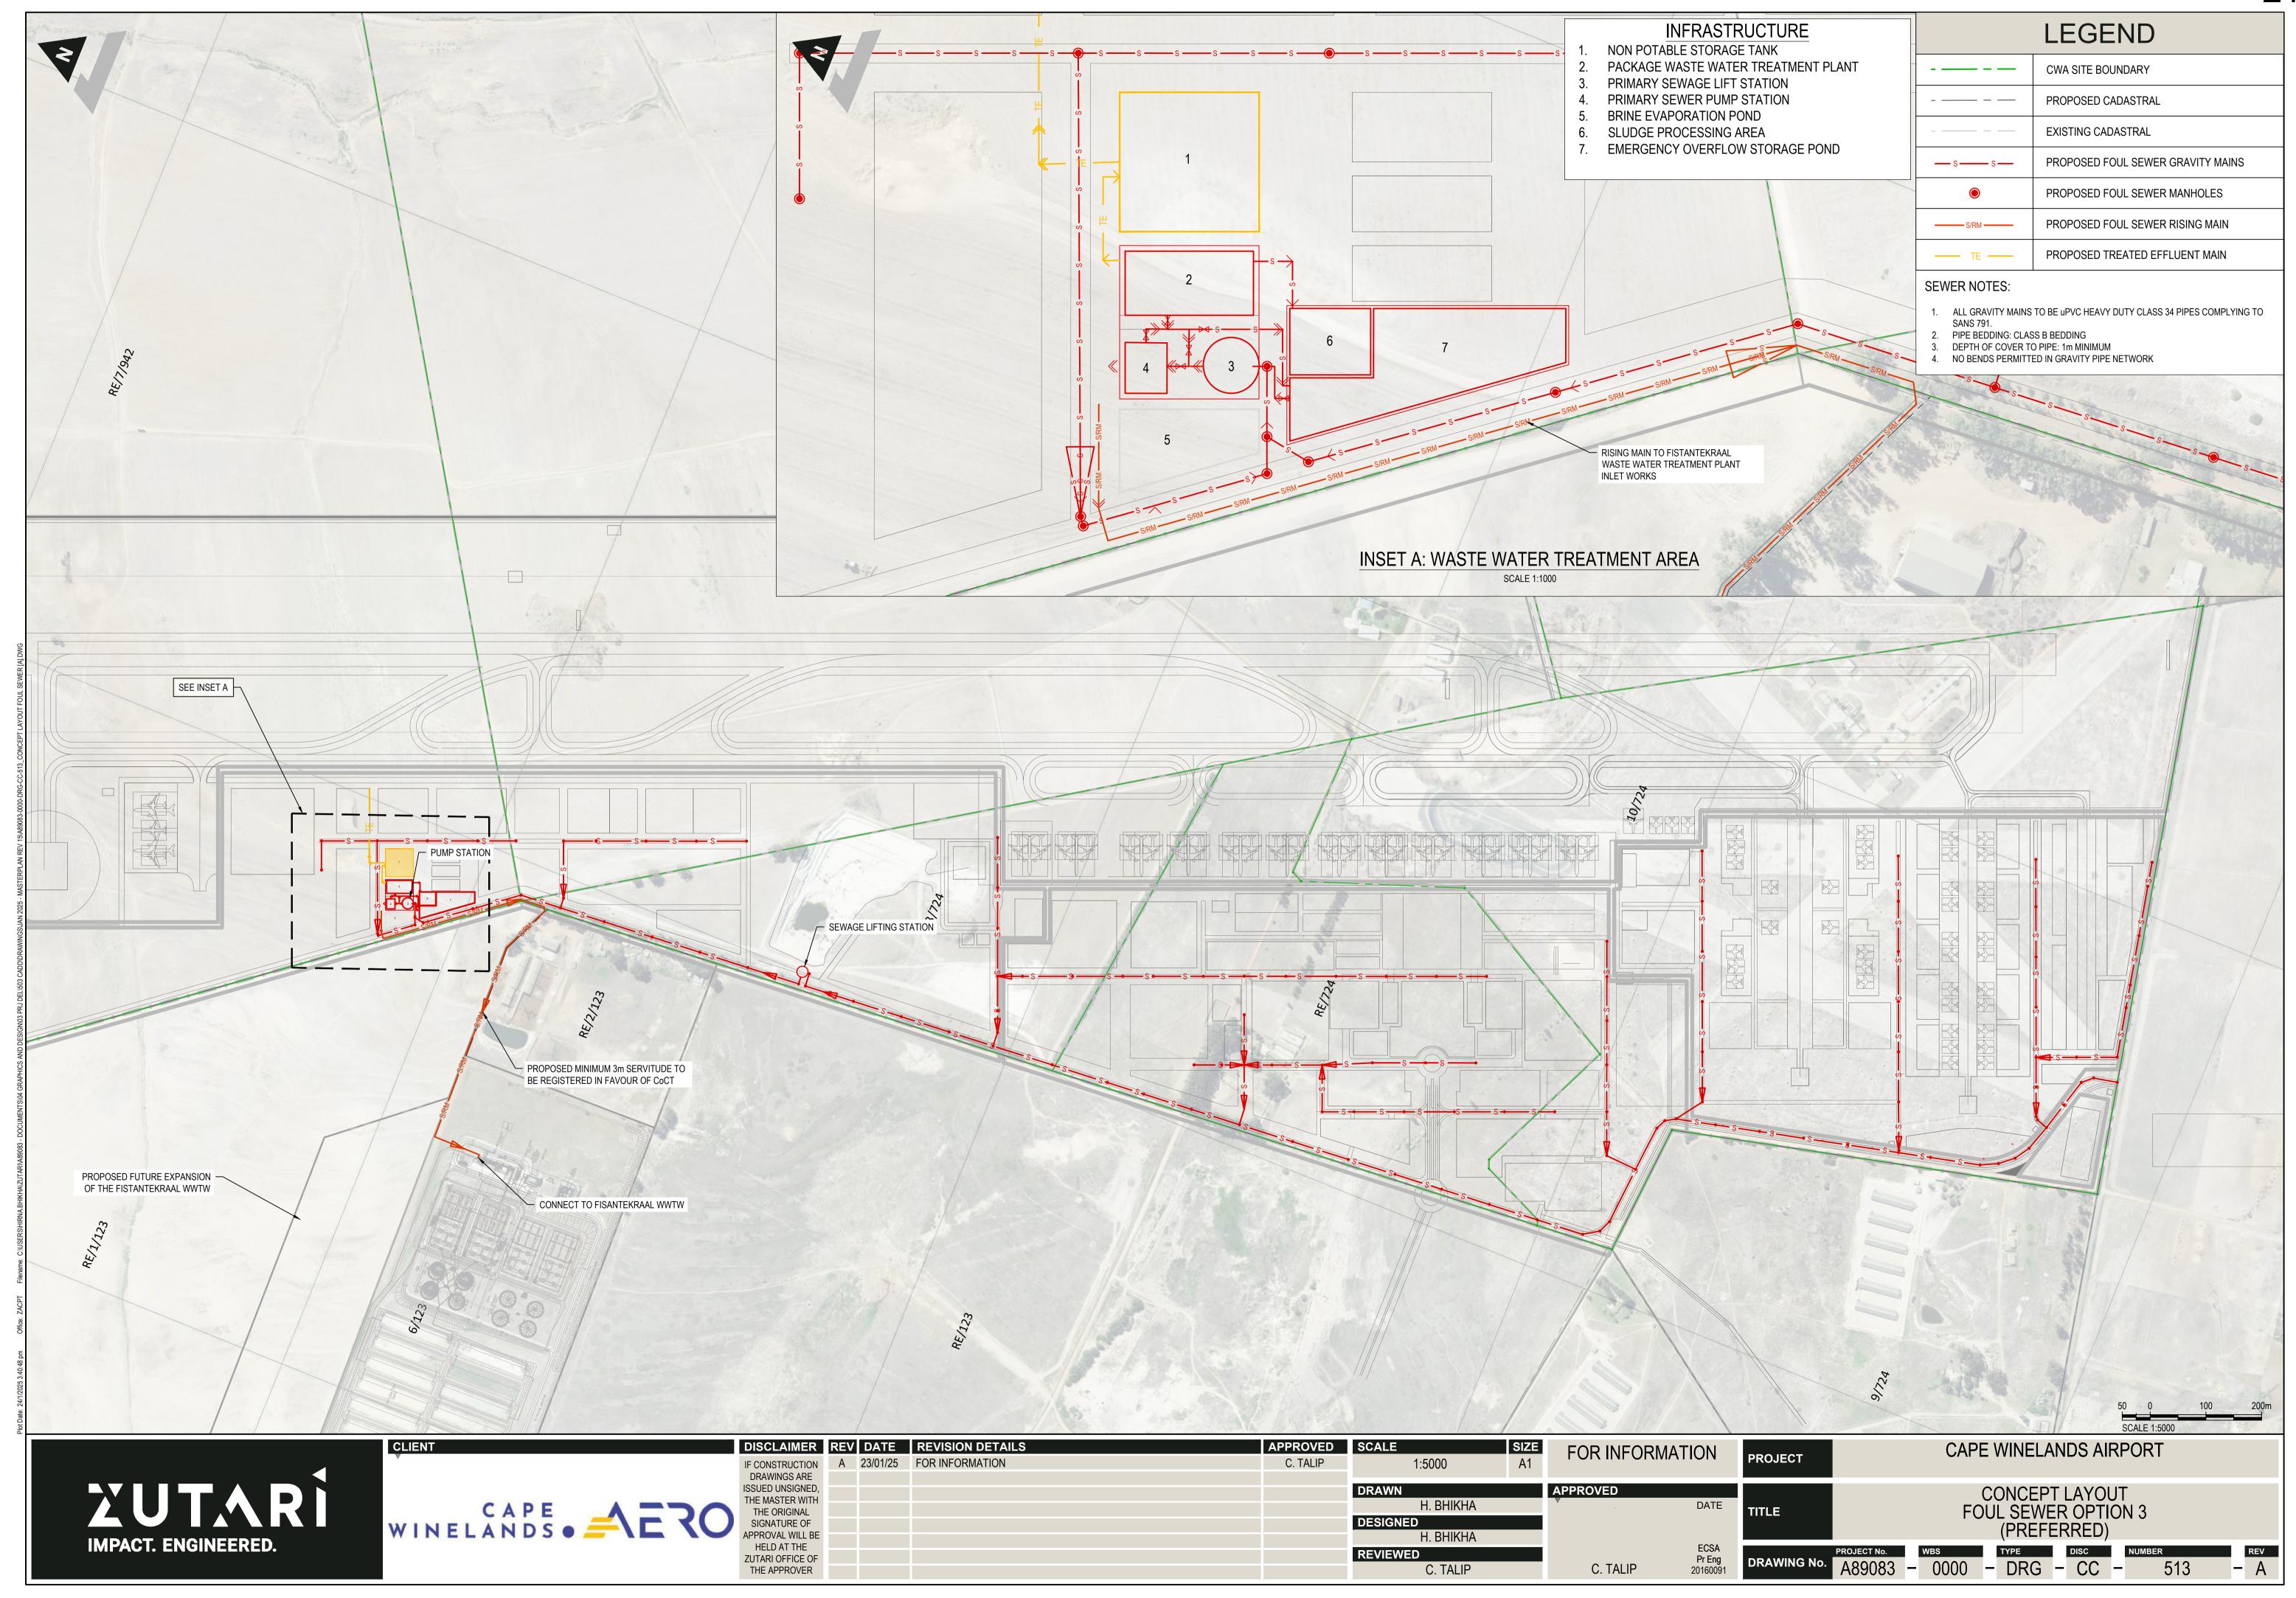


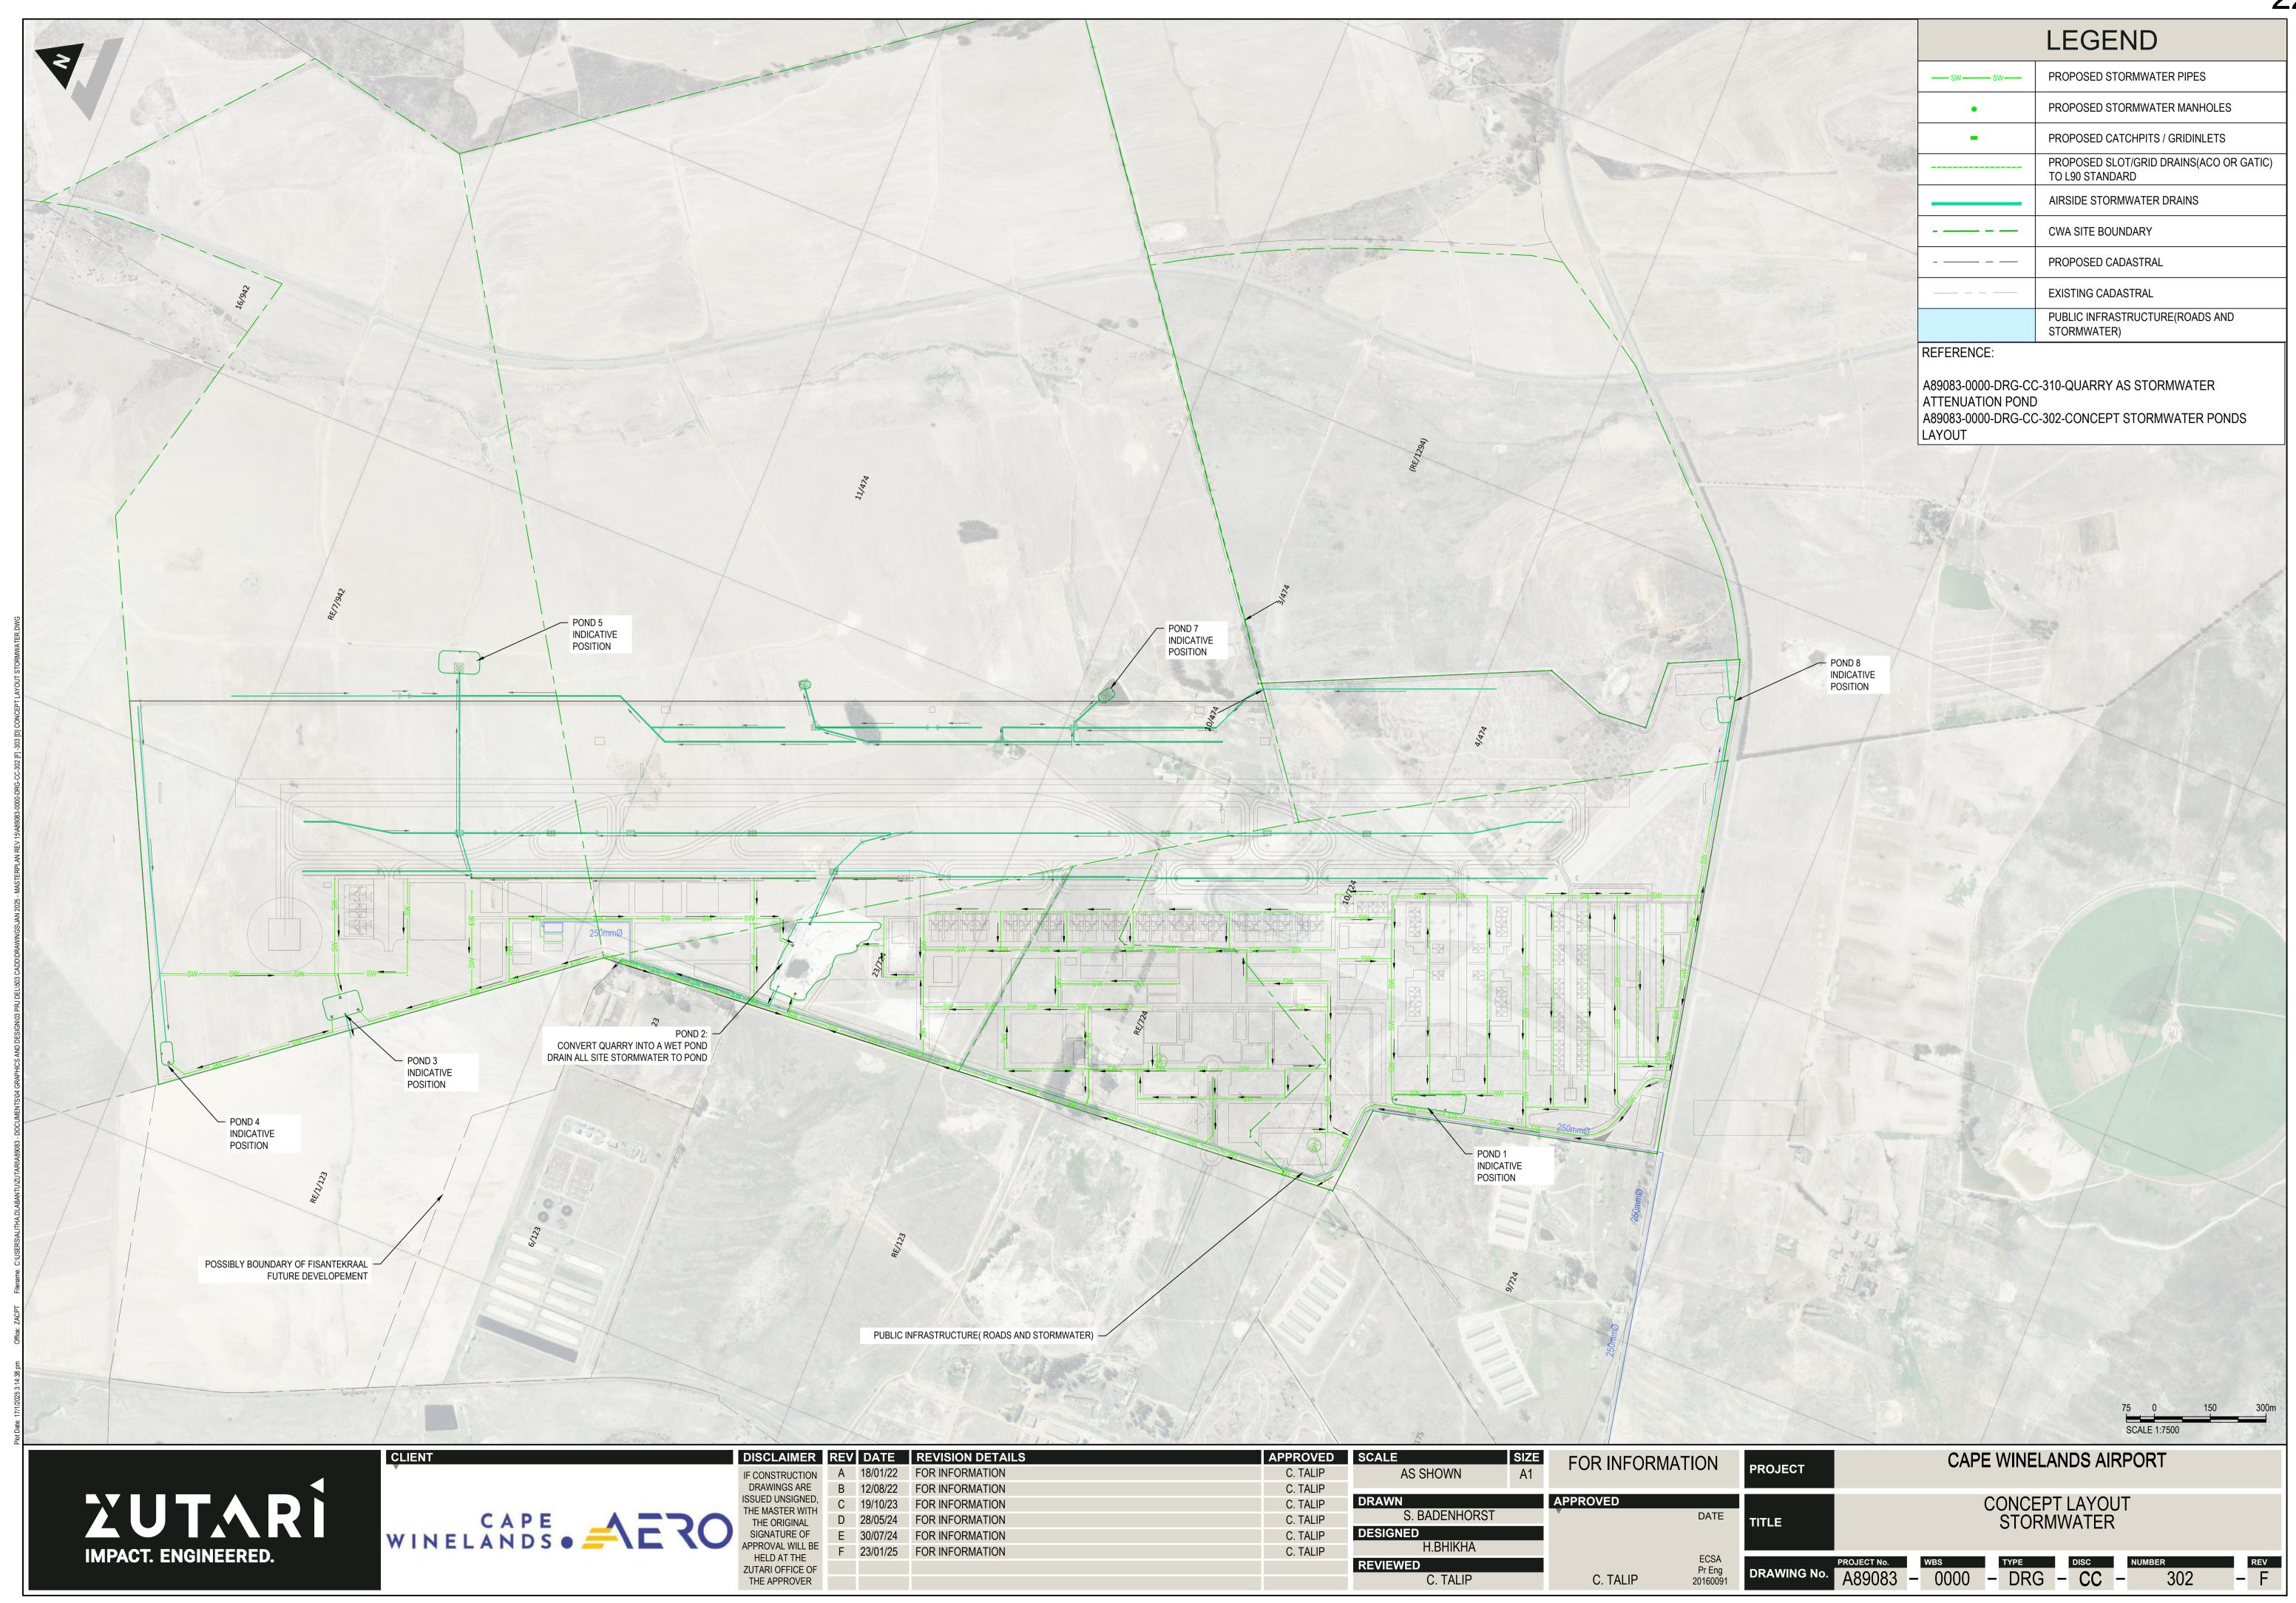


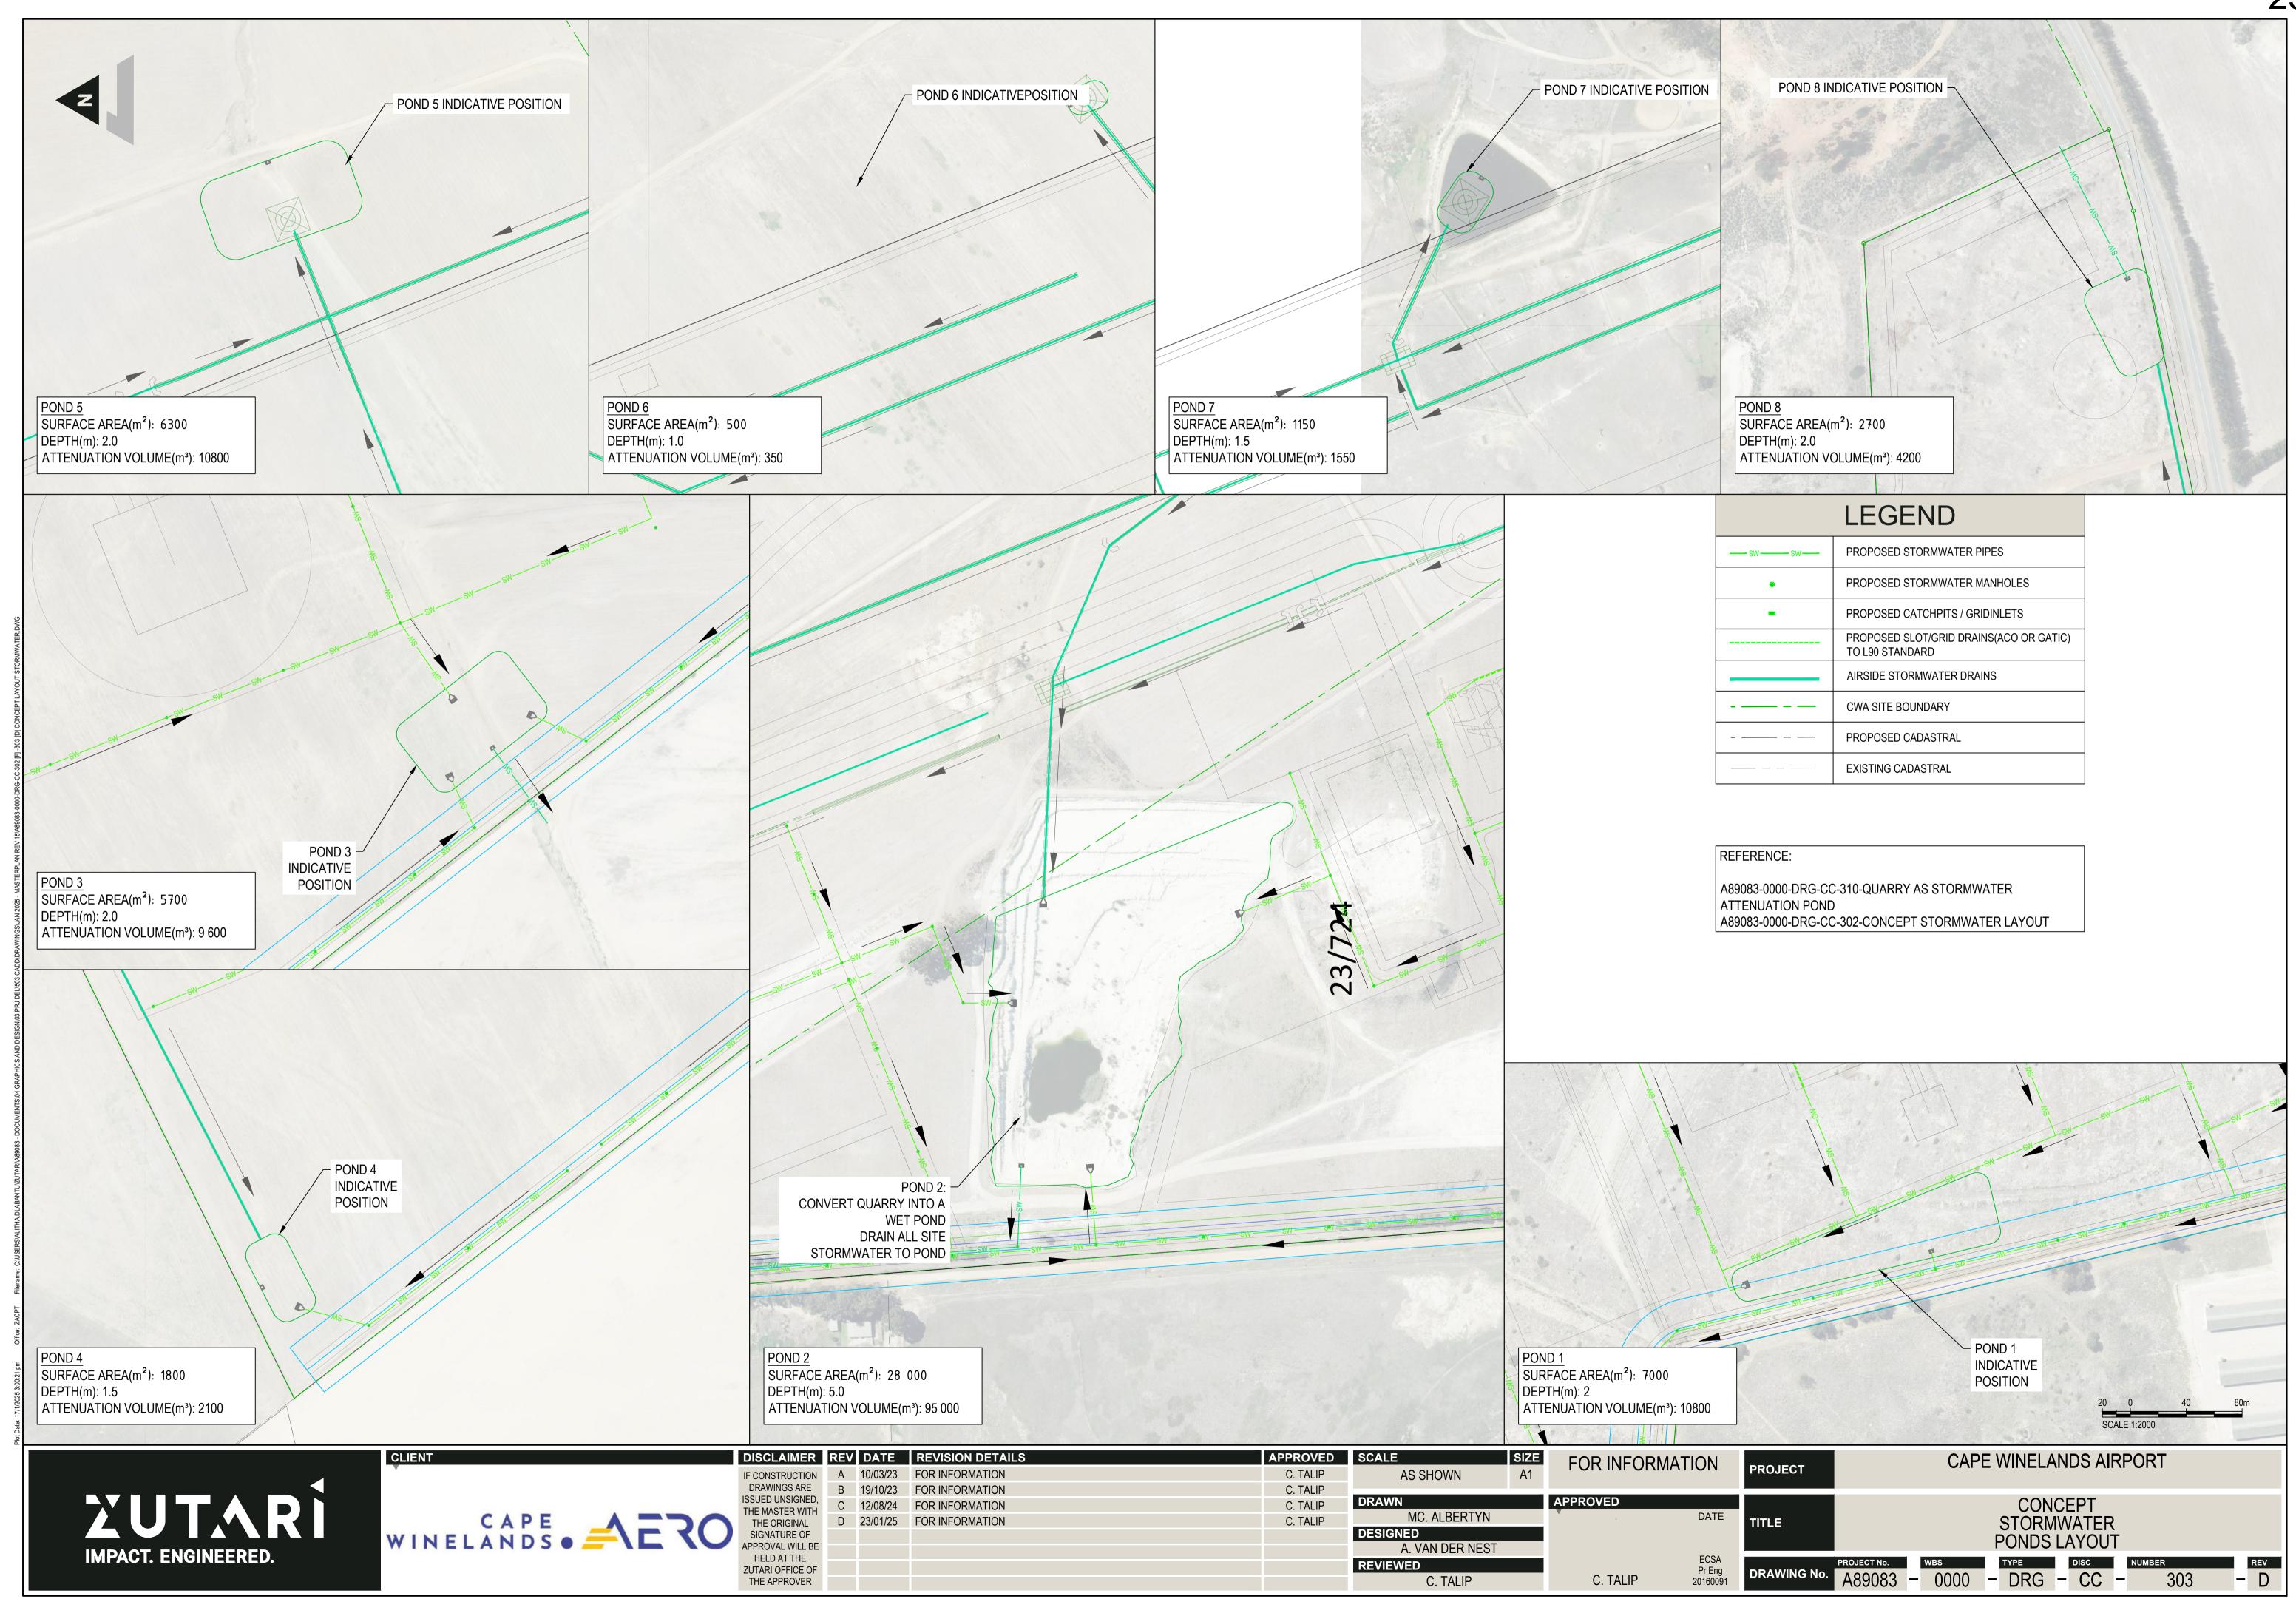


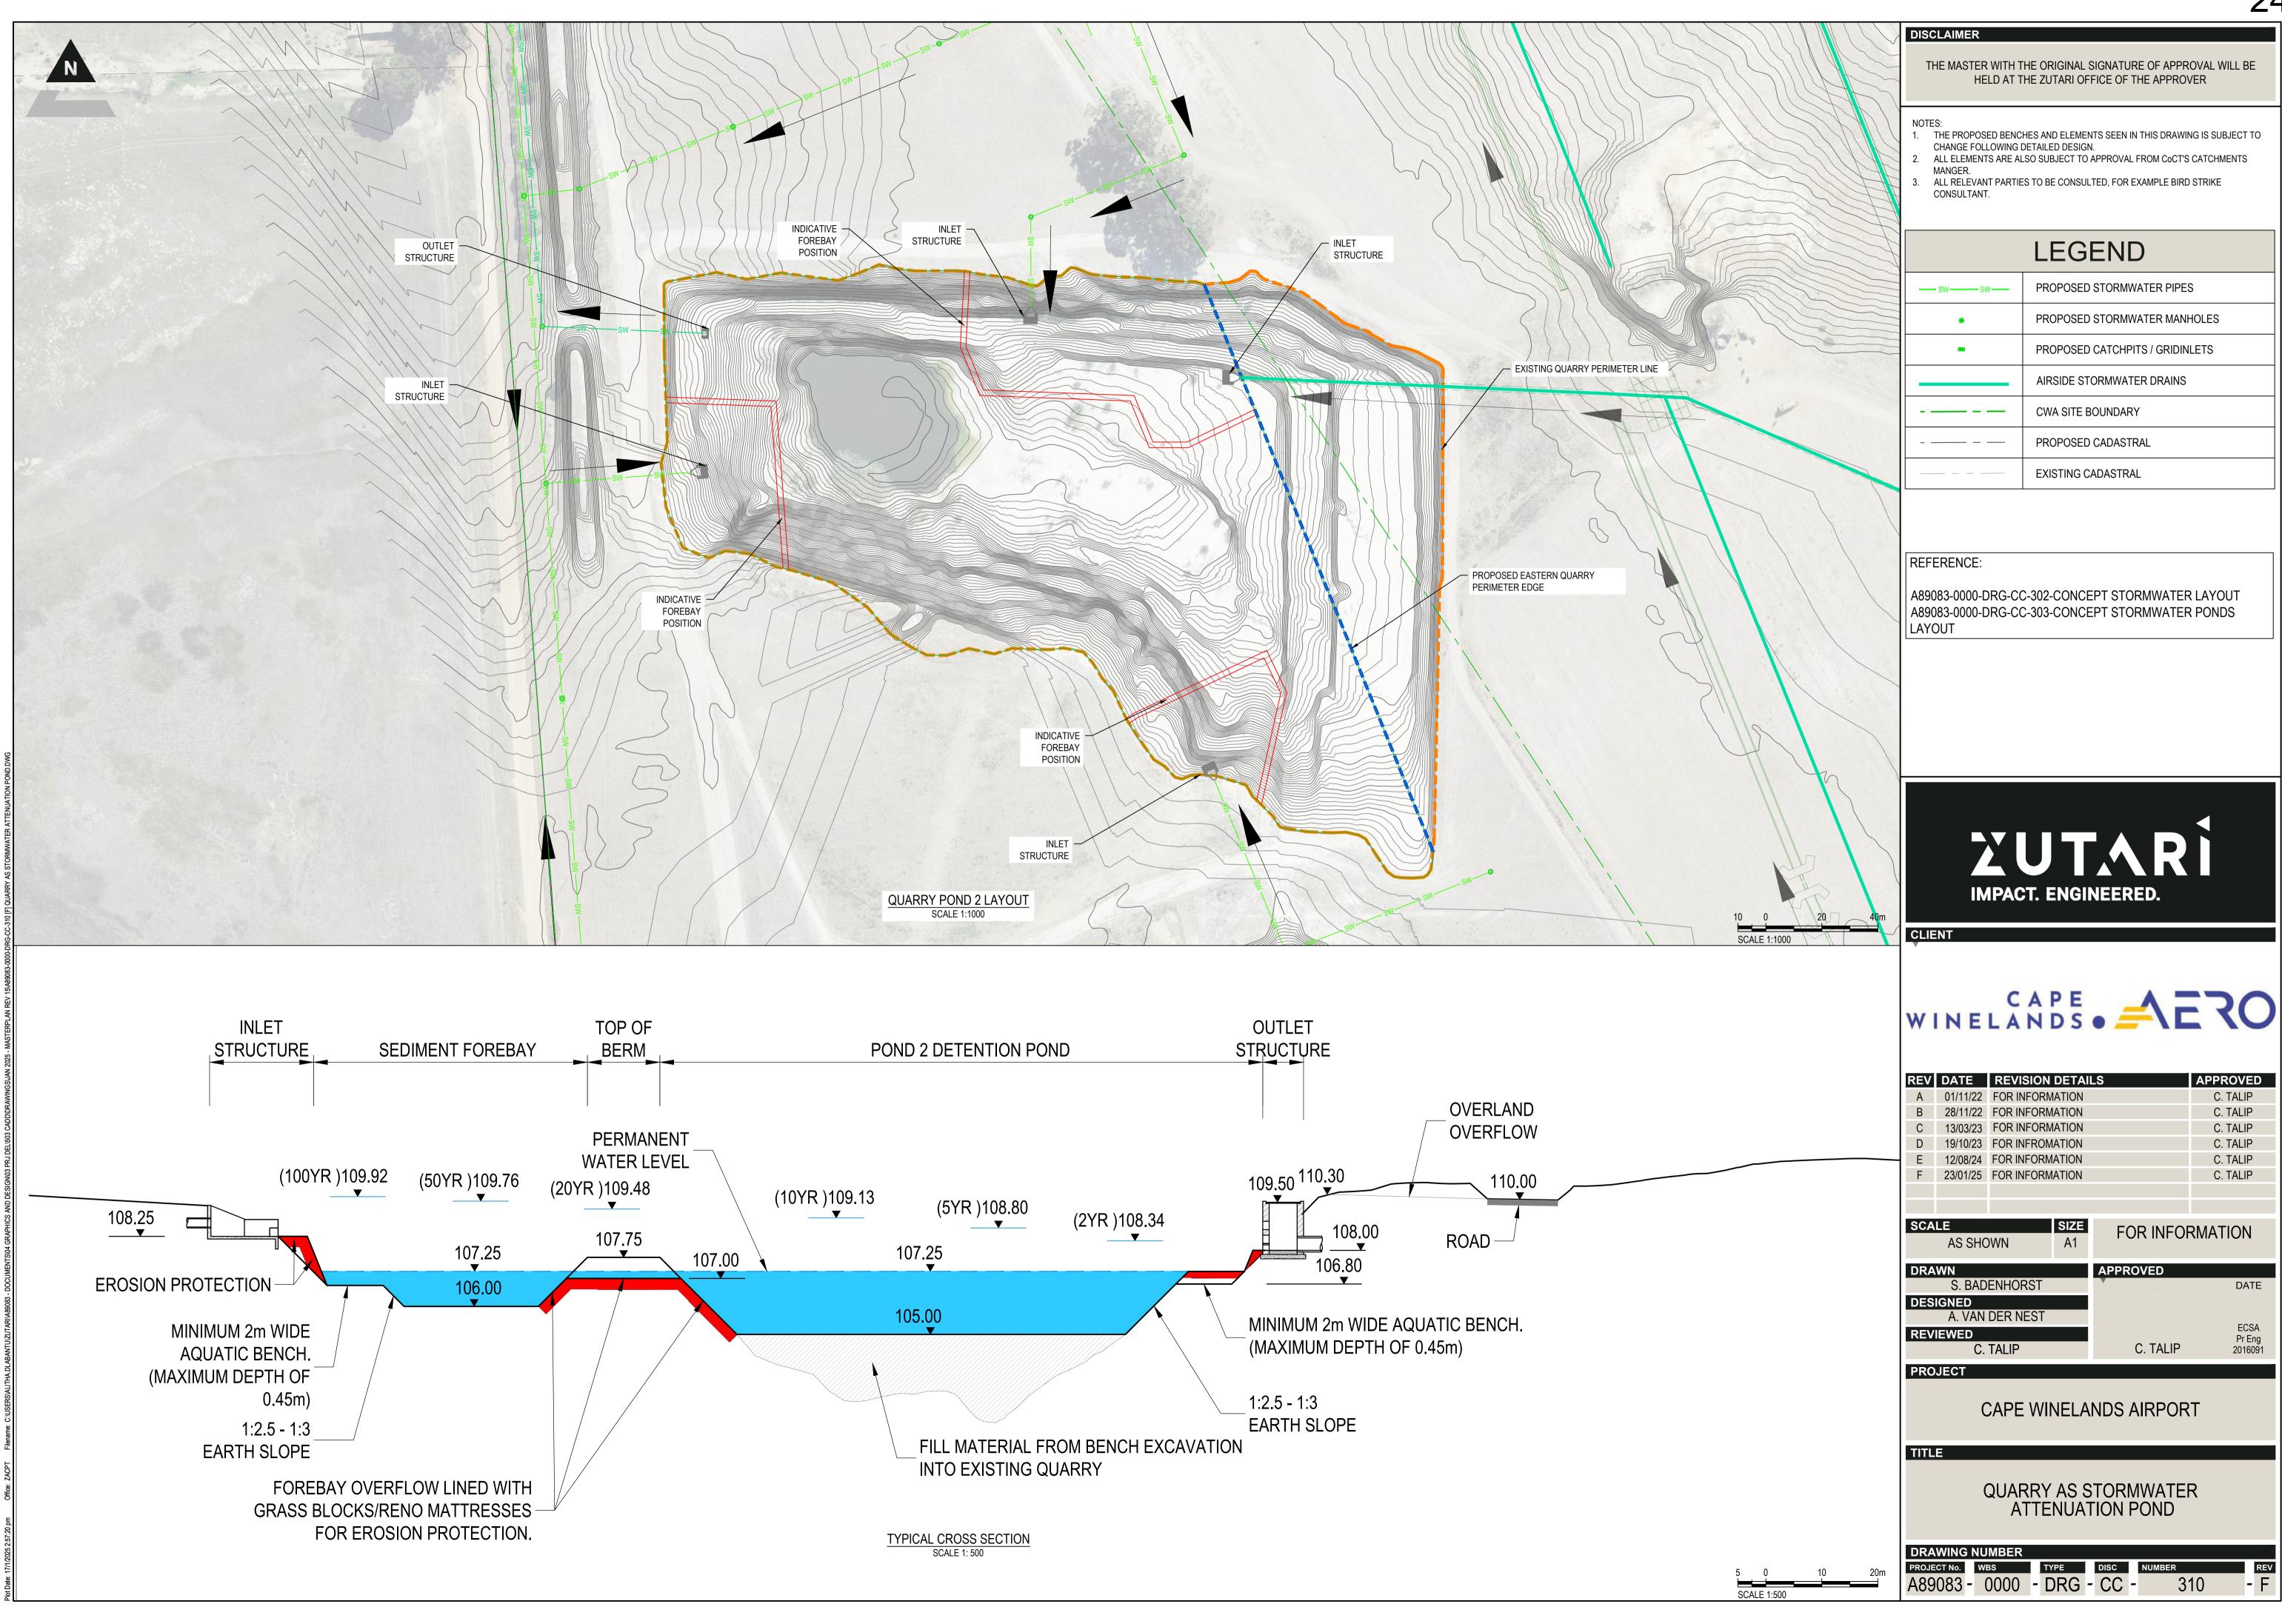


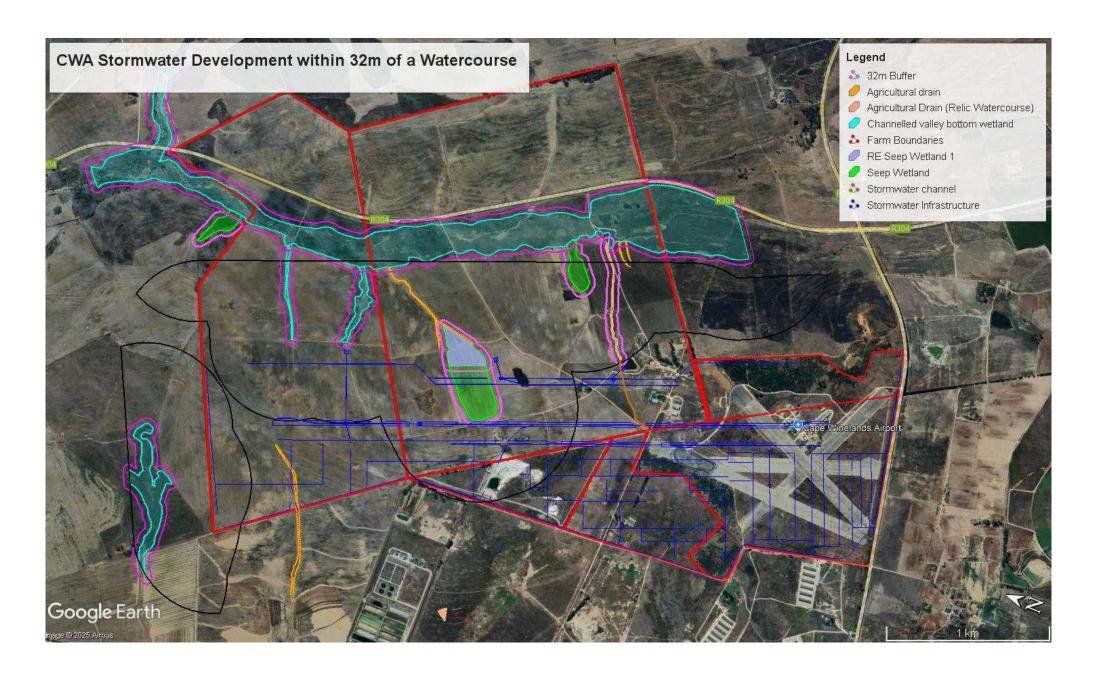


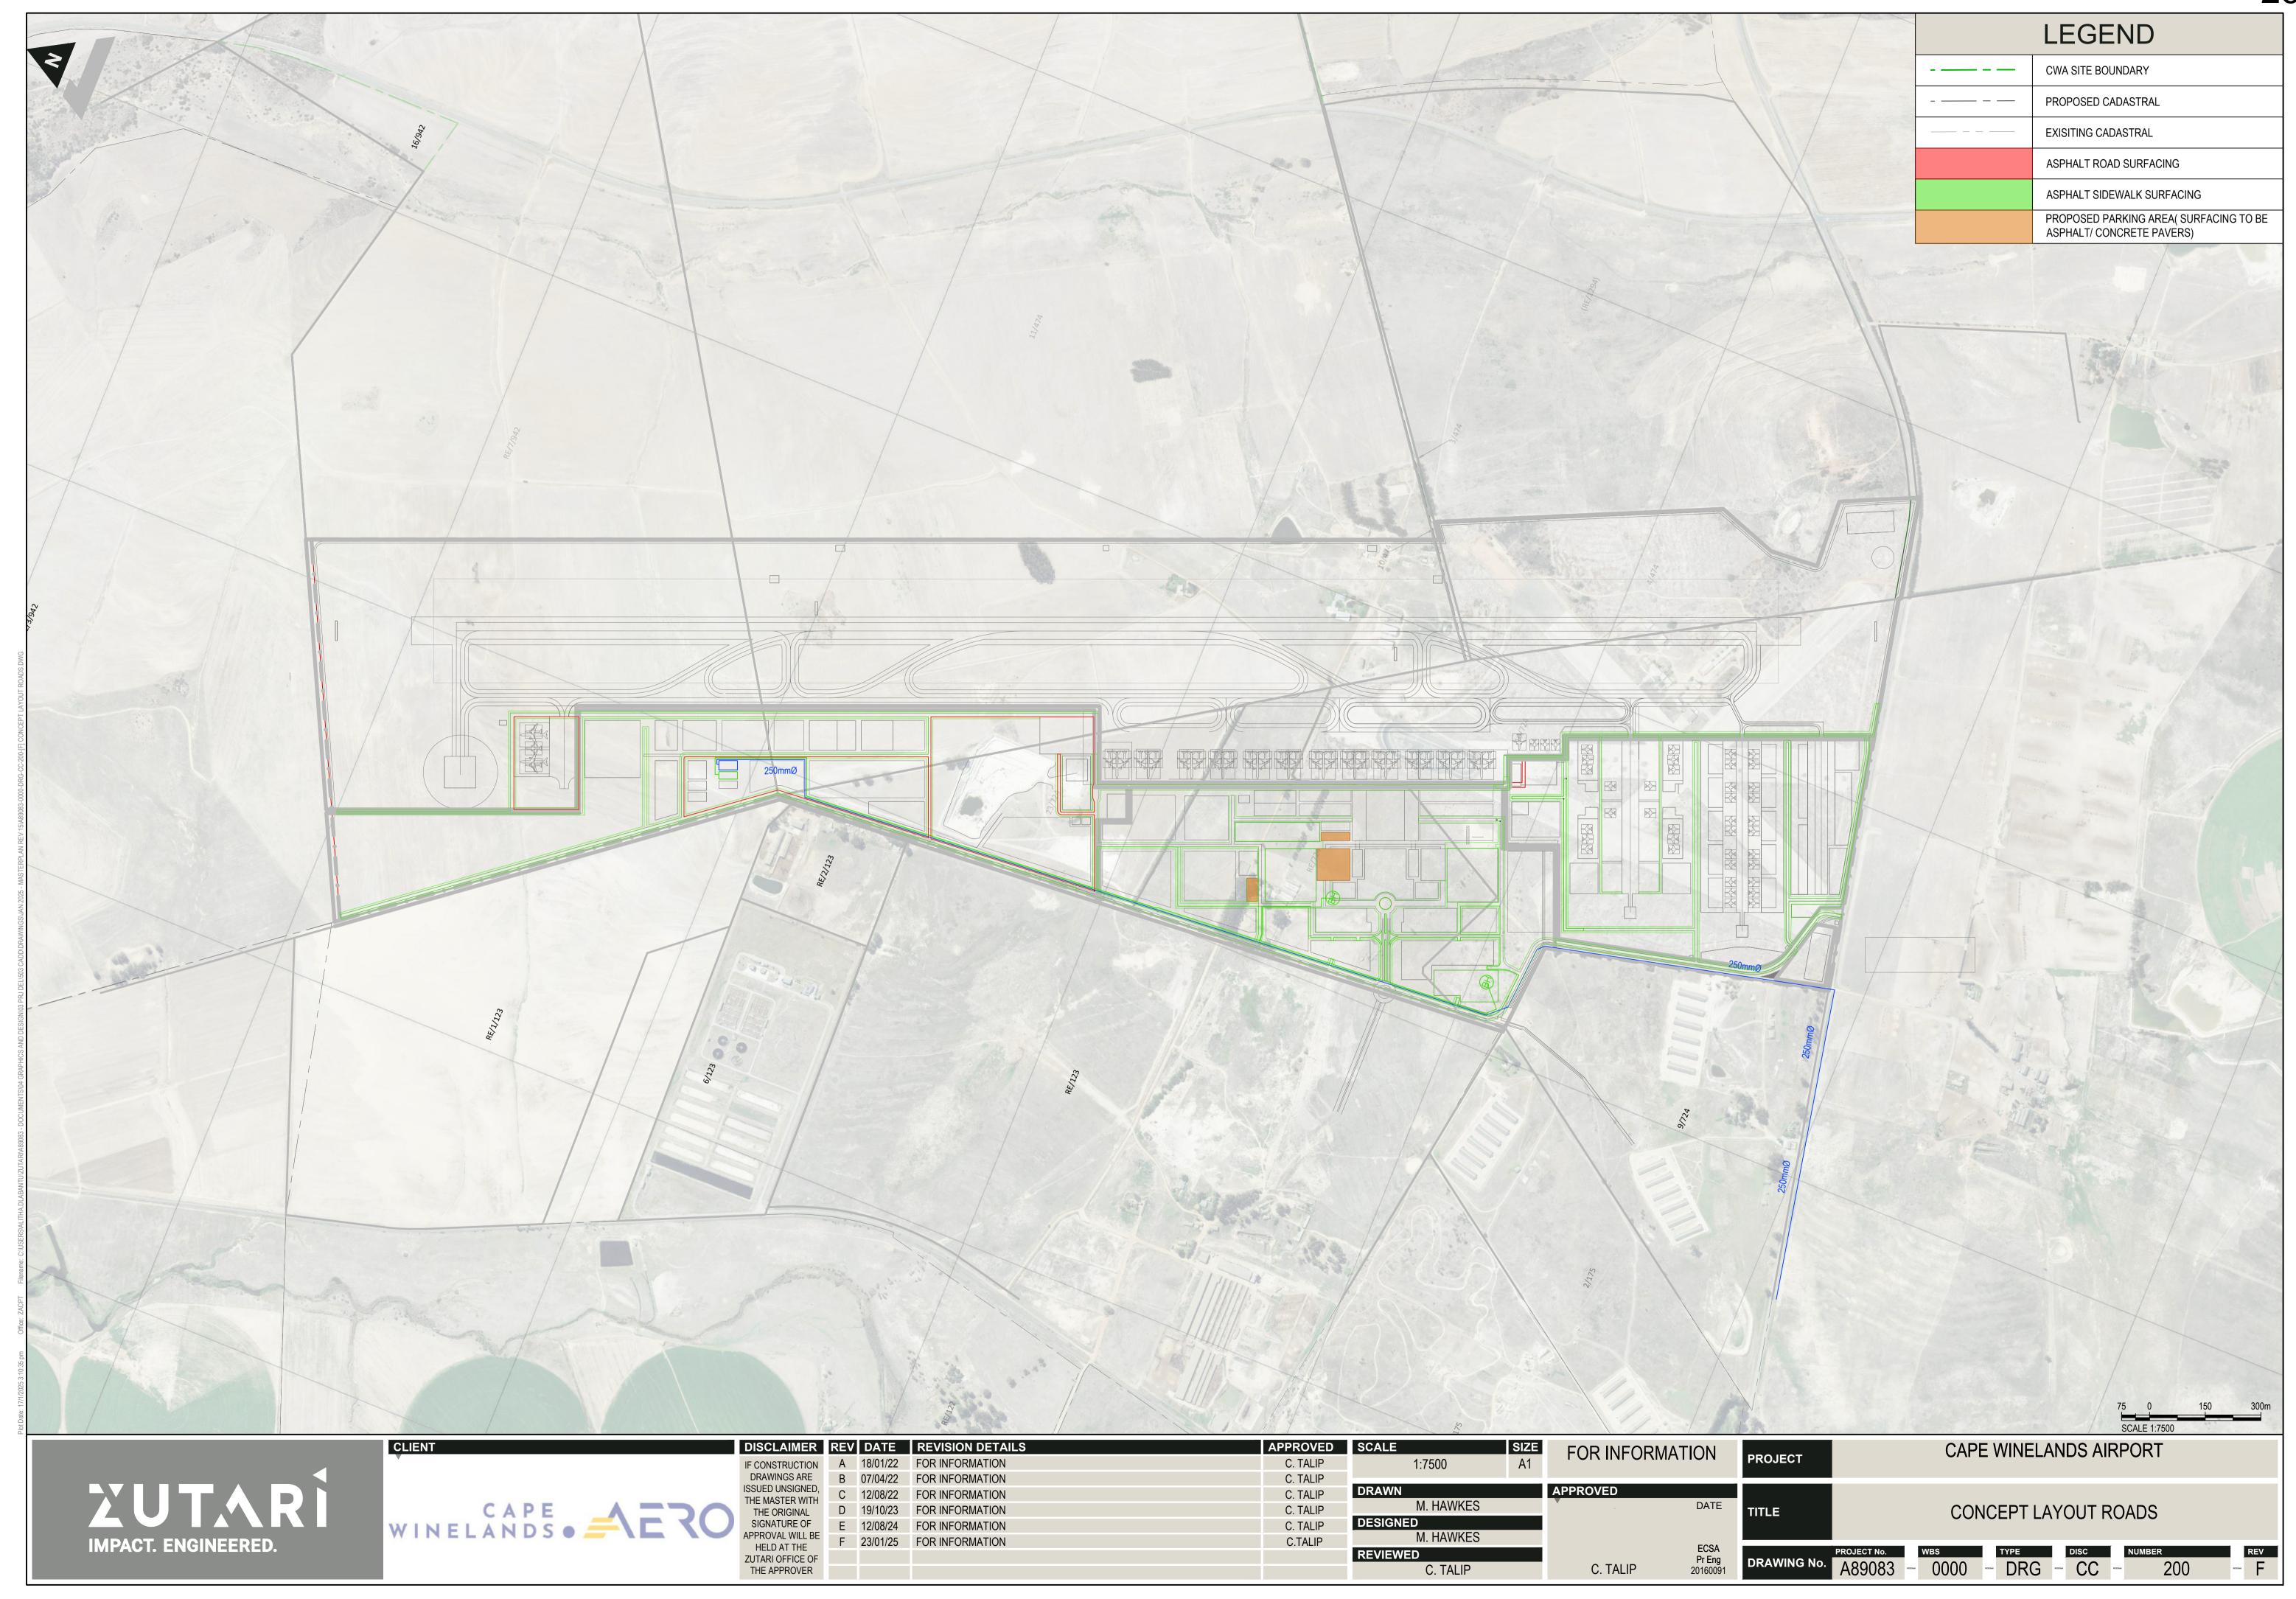

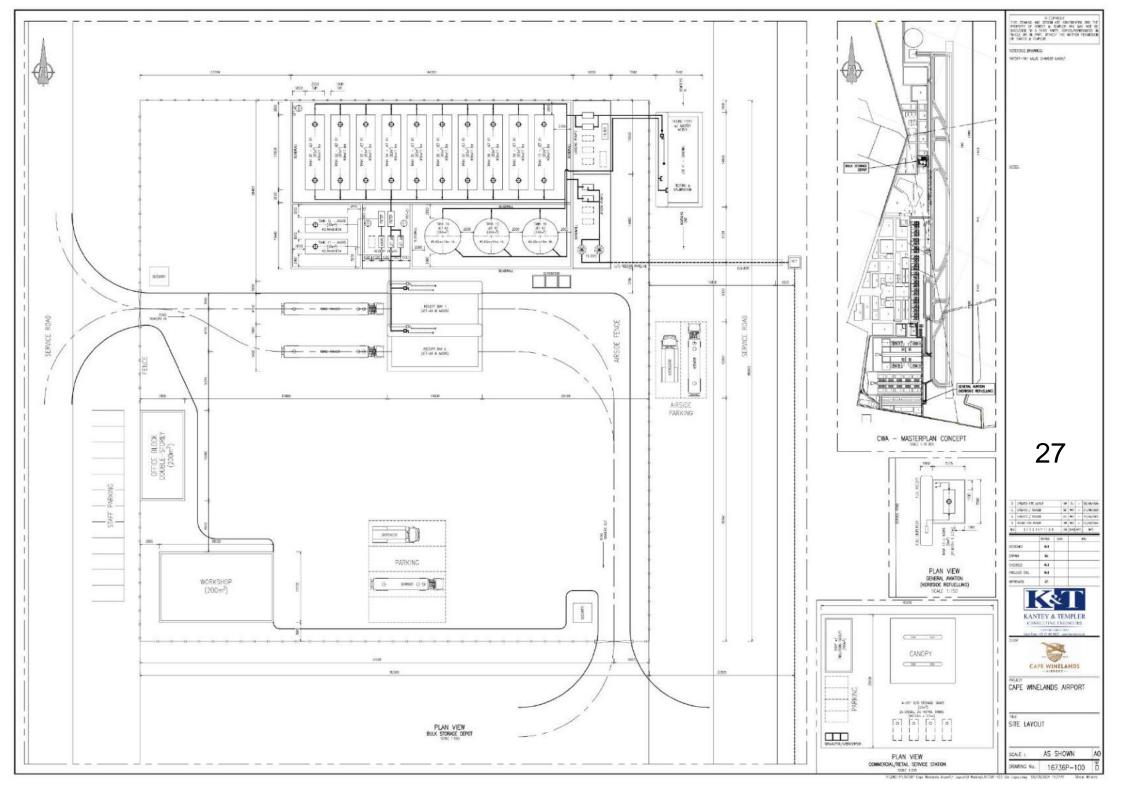

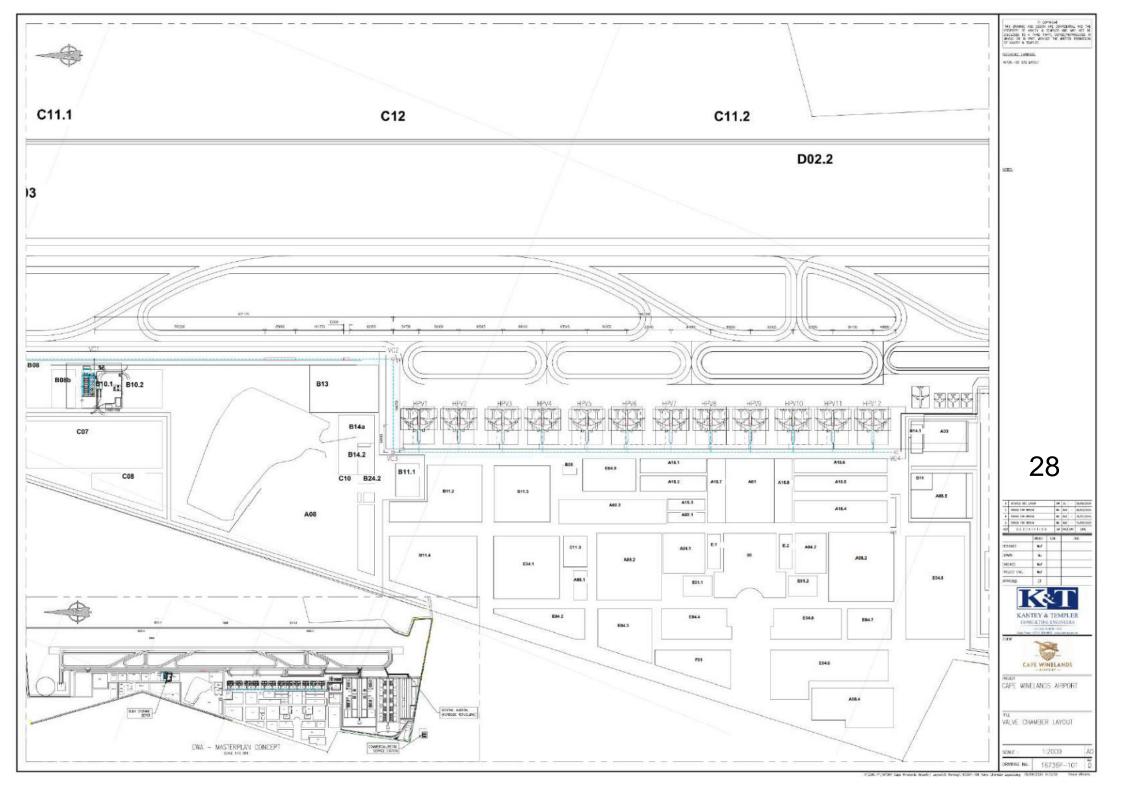


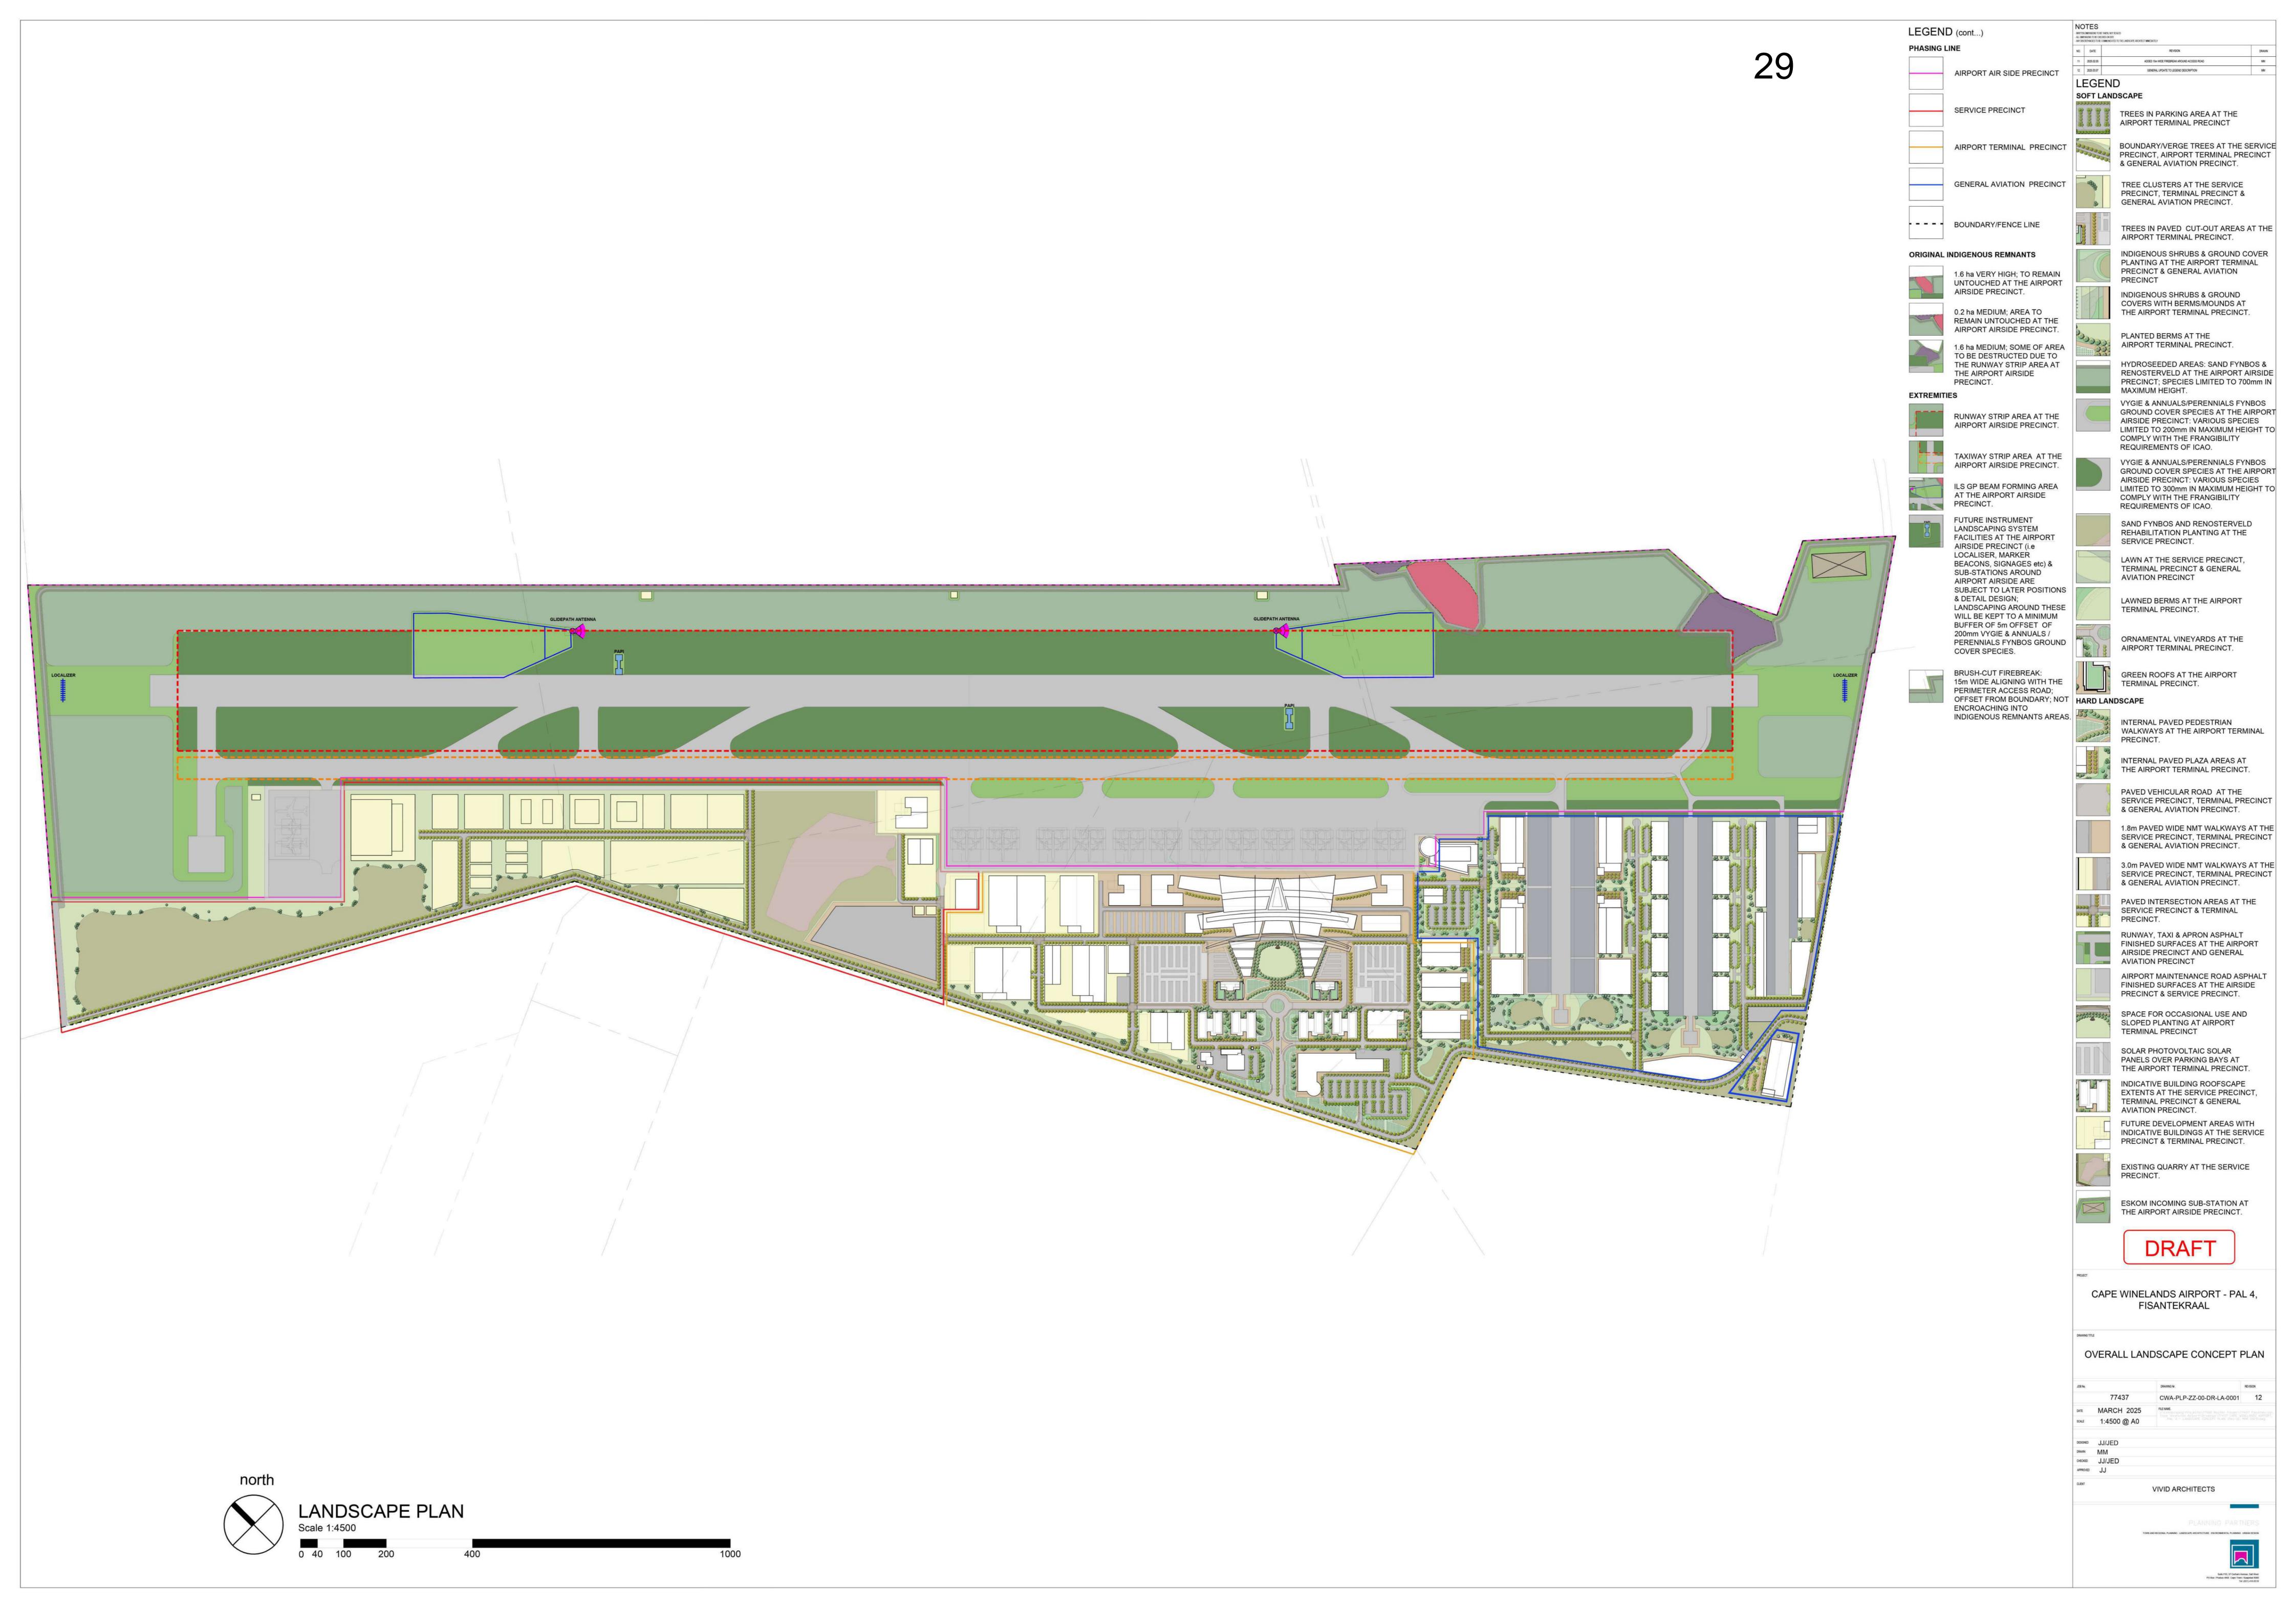

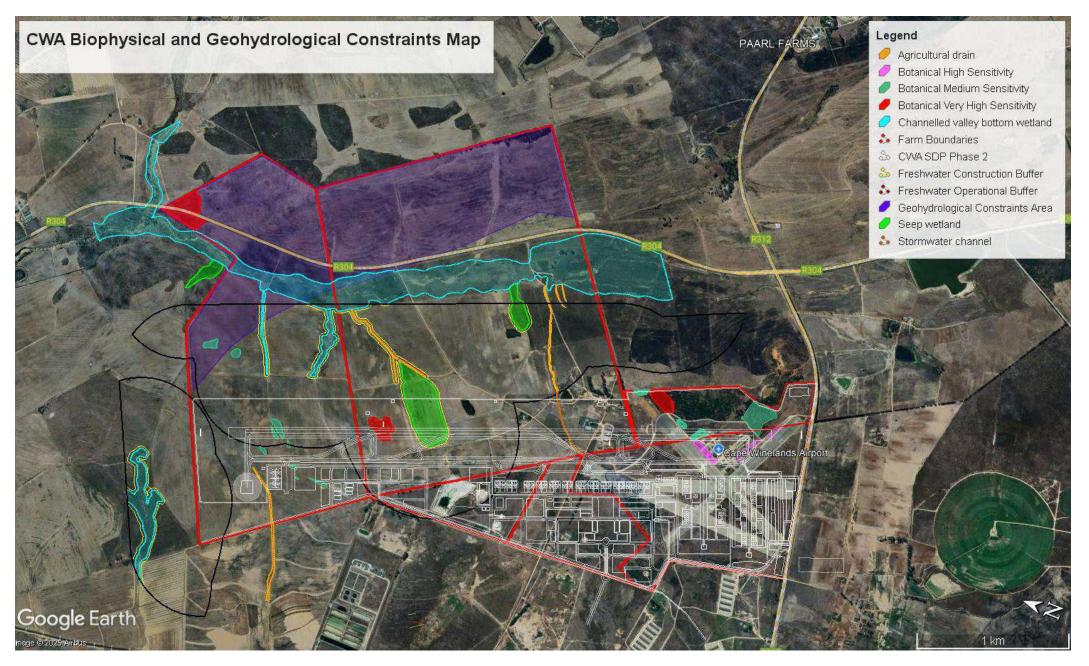

30b



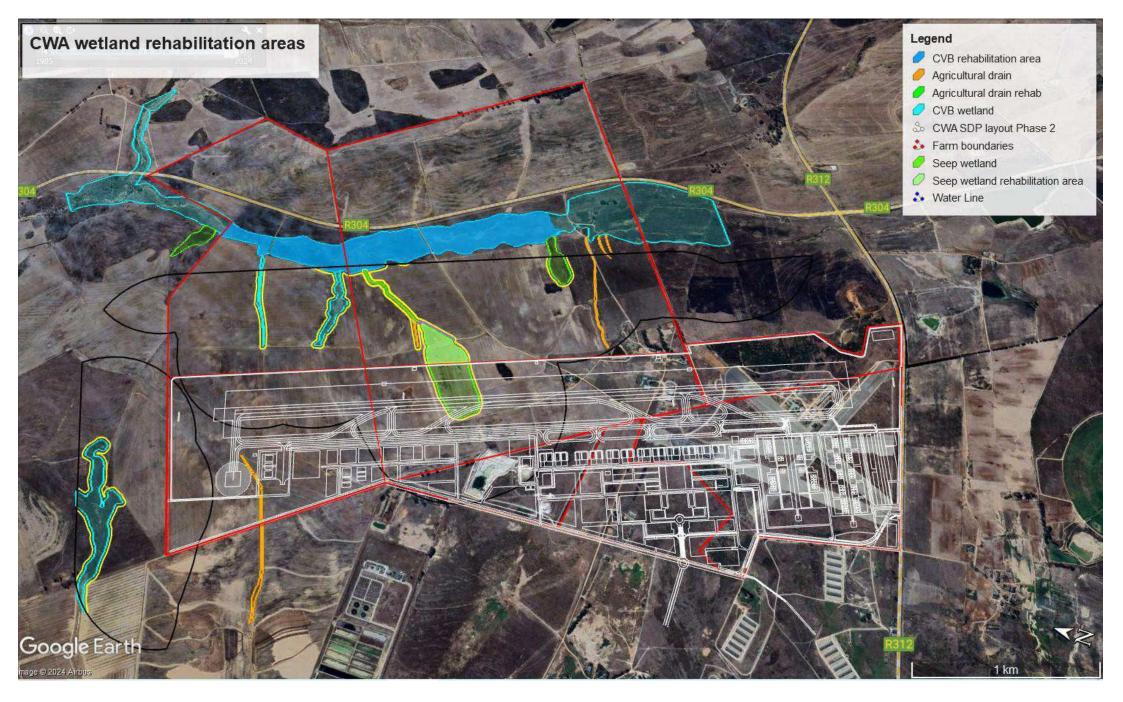

Coordinates along route of linear development (1 to 41 along Primary Runway 01-19; 42 to 50 along Secondary Runway 14-32)

Primary Runway 01-19	Coordinate nr	Lattitude	Longitude		
1 33'44'25.92"S 18'43'48.02"E 3 33'44'25.92"S 18'43'49.06"E 3 33'44'25.92"S 18'43'59.00"E 4 33'44'35.33"S 18'43'55.28"E 5 33'44'35.33"S 18'43'55.24"E 6 33'44'35.33"S 18'43'55.24"E 7 33'44'16.2"S 18'43'55.44"E 8 33'44'16.2"S 18'43'55.64"E 9 33'44'41.62"S 18'43'55.64"E 10 33'44'45.96"S 18'44'55.62"E 11 33'44'59.96"S 18'44'5.18"E 12 33'44'57.35"S 18'44'5.11"E 13 33'45'57.35"S 18'44'5.11"E 13 33'45'57.35"S 18'44'5.11"E 13 33'45'57.35"S 18'44'5.11"E 14 33'45'19.06"S 18'44'8.12"E 15 33'45'19.06"S 18'44'8.12"E 16 33'45'19.05"S 18'44'8.12"E 17 33'45'19.05"S 18'44'8.12"E 18 33'45'19.05"S 18'44'1.29"E 18 33'45'19.05"S 18'44'1.59"E 19 33'45'19.05"S 18'44'1.59"E 20 33'45'22.20"S 18'44'1.59"E 21 33'45'22.20"S 18'44'1.59"E 22 33'45'23.60"S 18'44'20.3"E 23 33'45'23.60"S 18'44'20.3"E 24 33'45'23.65"S 18'44'20.3"E 25 33'45'34.85"S 18'44'20.3"E 26 33'45'34.85"S 18'44'20.3"E 27 33'45'34.85"S 18'44'20.3"E 28 33'45'34.85"S 18'44'23.58"E 39 33'45'34.85"S 18'44'23.58"E 30 33'45'34.85"S 18'44'23.58"E 31 33'45'34.85"S 18'44'23.58"E 33 34'54'34.85"S 18'44'23.58"E 34 33'45'34.85"S 18'44'23.58"E 35 33'45'34.85"S 18'44'23.58"E 36 33'45'34.85"S 18'44'23.58"E 37 33'45'34.85"S 18'44'23.58"E 38 33'45'10.05"S 18'44'33.83"E 39 33'45'10.05"S 18'44'33.83"E 31 33'45'10.05"S 18'44'33.83"E 33 34'55'3.25"S 18'44'23.58"E 34 33'45'34.85"S 18'44'23.58"E 35 33'45'40.05"S 18'44'30.8""E 36 33'45'40.05"S 18'44'30.8""E 37 33'45'40.05"S 18'44'30.8""E 38 33'46'10.5"S 18'44'30.8""E 39 33'46'10.5"S 18'44'30.8""E 34 33'46'10.5"S 18'44'30.8""E 34 33'46'10.5"S 18'44'30.8""E 35 33'46'24.00"S 18'44'30.8""E 36 33'46'10.5"S 18'44'30.8""E 37 33'46'14.66"S 18'44'30.8"E 38 33'46'11.5"S 18'44'30.8"E 44 33'46'11.5"S 18'44'30.8"E 45 33'46'11.5"S 18'44'30.8"E 46 33'46'11.5"S 18'44'30.8"E 47 33'46'11.5"S 18'44'13.8"E					
2 33'44'28.96"S 18'43'49.36"E 3 3 34'428.96"S 18'43'50.28"E 4 33'44'32.12"S 18'43'52.28"E 5 33'44'38.37"S 18'43'53.34"E 6 33'44'38.47"S 18'43'53.74"E 7 33'44'16.2"S 18'43'55.44"E 7 33'44'16.2"S 18'43'55.44"E 8 33'44'44.63"S 18'43'55.44"E 10 33'44'78.81"S 18'43'55.64"E 10 33'44'78.81"S 18'44'55.6"E 11 33'44'54.09"S 18'44'1.93"E 12 33'44'54.09"S 18'44'1.93"E 12 33'44'50.95"S 18'44'5.11"E 13 33'45'50.55"S 18'44'6.65"E 14 33'45'9.95"S 18'44'6.65"E 15 33'45'9.91"S 18'44'6.65"E 16 33'45'9.91"S 18'44'1.93"E 17 33'45'1.60"S 18'44'1.44"E 17 33'45'1.60"S 18'44'1.45"E 18 33'45'1.60"S 18'44'1.45"E 19 33'45'1.00"S 18'44'1.45"E 20 33'45'2.20"S 18'44'1.79"E 21 33'45'2.50"S 18'44'1.79"E 22 33'45'3.85"S 18'44'2.09"E 23 33'45'3.85"S 18'44'2.09"E 24 33'45'3.85"S 18'44'2.09"E 25 33'45'3.85"S 18'44'2.09"E 26 33'45'3.85"S 18'44'2.09"E 27 33'45'3.49"S 18'44'2.58"E 28 33'45'3.65"S 18'44'2.58"E 29 33'45'3.49"S 18'44'2.58"E 20 33'45'3.49"S 18'44'2.58"E 21 33'45'3.49"S 18'44'2.58"E 22 33'45'3.49"S 18'44'2.58"E 23 33'45'3.49"S 18'44'2.58"E 24 33'45'3.49"S 18'44'2.58"E 25 33'45'3.49"S 18'44'2.58"E 26 33'45'3.49"S 18'44'2.58"E 27 33'45'3.49"S 18'44'2.58"E 28 33'45'40.0"S 18'44'3.58"E 29 33'45'50.16"S 18'44'2.58"E 30 33'45'1.60"S 18'44'2.58"E 31 33'45'1.60"S 18'44'2.58"E 32 33'45'3.49"S 18'44'2.58"E 33 33'45'1.60"S 18'44'2.58"E 34 33'45'1.60"S 18'44'2.58"E 35 33'45'1.60"S 18'44'2.58"E 36 33'45'1.60"S 18'44'2.58"E 37 33'45'4.60"S 18'44'2.58"E 38 33'45'1.60"S 18'44'2.58"E 39 33'45'4.00"S 18'44'2.58"E 30 33'45'4.00"S 18'44'2.58"E 31 33'45'4.00"S 18'44'3.59"E 32 33'45'4.00"S 18'44'3.59"E 34 33'45'4.00"S 18'44'3.59"E 35 33'45'4.00"S 18'44'3.59"E 36 33'45'4.00"S 18'44'3.59"E 37 33'46'4.60"S 18'44'3.59"E 38 33'46'1.60"S 18'44'3.59"E 39 33'46'1.60"S 18'44'3.59"E 30 33'46'1.40"S 18'44'3.59"E 31 33'46'1.50"S 18'44'3.59"E 32 33'46'1.40"S 18'44'3.59"E 33 34'6'1.40"S 18'44'3.59"E 34 33'46'1.40"S 18'44'3.59"E 34 33'46'1.40"S 18'44'3.59"E	•	33°44'22.90"S	18°43'48.02"E		
33*4478.86°S 4 33*4478.21°S 5 33*4478.21°S 5 33*4478.21°S 6 33*4478.47°S 18*4353.74°E 6 33*4478.47°S 18*4353.74°E 8 33*4478.61°S 18*4355.44°E 8 33*4478.61°S 18*4355.44°E 10 33*4478.61°S 18*435.62°E 9 33*4478.18°S 18*445.62°E 10 33*4450.86°S 18*445.62°E 11 33*4450.86°S 18*445.62°E 12 33*4457.35°S 18*445.61°E 13 33*450.51°S 18*445.84°E 14 33*455.86°S 18*445.87°E 18*441.24°E 15 33*455.80°S 18*441.24°E 16 33*459.91°S 18*441.24°E 17 33*4512.99°S 18*4411.24°E 18 33*451.80°S 18*4415.38°E 20 33*4572.20°S 18*4417.57°E 21 33*4528.88°S 18*4417.57°E 22 33*4528.88°S 18*4417.57°E 23 33*4538.88°S 18*4417.57°E 24 33*4538.88°S 18*4423.09°E 25 33*4538.88°S 18*4423.09°E 26 33*4538.88°S 18*4423.09°E 27 33*4538.88°S 18*4423.09°E 28 33*4538.88°S 18*4423.09°E 29 33*4553.68°S 18*4423.09°E 30 33*4553.68°S 18*4423.09°E 31 33*4558.88°S 18*4423.09°E 33 33*4558.88°S 18*4423.09°E 34 33*4558.88°S 18*4423.09°E 38 33*4558.88°S 18*4423.09°E 39 33*4558.88°S 18*4423.09°E 39 33*4558.88°S 18*4435.37°E 30 33*4558.88°S 18*4435.37°E 31 33*4558.88°S 18*4435.37°E 32 33*4558.88°S 18*4435.37°E 34 33*4558.88°S 18*4435.37°E 35 33*4658.88°S 18*4435.37°E 36 33*4658.88°S 18*4443.89°E 37 33*4658.88°S 18*4443.89°E 39 33*4658.88°S 39 33*4658.88°S 39					
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33 33°46′2.41″S 18°44′36.83″E 34 33°46′5.42″S 18°44′38.36″E 35 33°46′8.50″S 18°44′39.79″E 36 33°46′11.56″S 18°44′41.20″E 37 33°46′14.64″S 18°44′40.0″E 38 33°46′17.64″S 18°44′44.58″E 40 33°46′21.03″S 18°44′45.98″E 41 33°46′24.09″S 18°44′46.98″E Secondary Runway 14-32 42 33°46′23.87″S 18°44′35.35″E 44 33°46′22.66″S 18°44′35.35″E 44 33°46′21.15″S 18°44′31.93″E 45 33°46′19.79″S 18°44′28.40″E 46 33°46′18.59″S 18°44′21.29″E 48 33°46′15.82″S 18°44′17.74″E 49 33°46′14.33″S 18°44′14.35″E	32		18°44'35.37"E		
35 33°46'8.50"S 18°44'39.79"E 36 33°46'11.56"S 18°44'41.20"E 37 33°46'14.64"S 18°44'42.57"E 38 33°46'17.64"S 18°44'44.00"E 39 33°46'21.03"S 18°44'45.98"E 40 33°46'24.09"S 18°44'45.98"E 41 33°46'26.05"S 18°44'46.98"E Secondary Runway 14-32 42 33°46'23.87"S 18°44'39.00"E 43 33°46'22.66"S 18°44'35.35"E 44 33°46'21.15"S 18°44'31.93"E 45 33°46'19.79"S 18°44'28.40"E 46 33°46'18.59"S 18°44'24.86"E 47 33°46'17.21"S 18°44'21.29"E 48 33°46'15.82"S 18°44'17.74"E 49 33°46'14.33"S 18°44'14.35"E			18°44'36.83"E		
36 33°46'11.56"S 18°44'41.20"E 37 33°46'14.64"S 18°44'42.57"E 38 33°46'17.64"S 18°44'44.00"E 39 33°46'21.03"S 18°44'45.98"E 40 33°46'24.09"S 18°44'45.98"E 41 33°46'26.05"S 18°44'46.98"E Secondary Runway 14-32 42 33°46'23.87"S 18°44'39.00"E 43 33°46'22.66"S 18°44'31.93"E 44 33°46'21.15"S 18°44'31.93"E 45 33°46'19.79"S 18°44'28.40"E 46 33°46'18.59"S 18°44'24.86"E 47 33°46'17.21"S 18°44'21.29"E 48 33°46'15.82"S 18°44'17.74"E 49 33°46'14.33"S 18°44'14.35"E	34	33°46'5.42"S	18°44'38.36"E		
37 33°46'14.64"S 18°44'42.57"E 38 33°46'17.64"S 18°44'44.00"E 39 33°46'21.03"S 18°44'44.58"E 40 33°46'24.09"S 18°44'45.98"E 41 33°46'26.05"S 18°44'46.98"E Secondary Runway 14-32 42 33°46'23.87"S 18°44'39.00"E 43 33°46'22.66"S 18°44'35.35"E 44 33°46'21.15"S 18°44'31.93"E 45 33°46'19.79"S 18°44'28.40"E 46 33°46'18.59"S 18°44'24.86"E 47 33°46'17.21"S 18°44'21.29"E 48 33°46'15.82"S 18°44'17.74"E 49 33°46'14.33"S 18°44'14.35"E	35	33°46'8.50"S	18°44'39.79"E		
37 33°46'14.64"S 18°44'42.57"E 38 33°46'17.64"S 18°44'44.00"E 39 33°46'21.03"S 18°44'44.58"E 40 33°46'24.09"S 18°44'45.98"E 41 33°46'26.05"S 18°44'46.98"E Secondary Runway 14-32 42 33°46'23.87"S 18°44'39.00"E 43 33°46'22.66"S 18°44'35.35"E 44 33°46'21.15"S 18°44'31.93"E 45 33°46'19.79"S 18°44'28.40"E 46 33°46'18.59"S 18°44'24.86"E 47 33°46'17.21"S 18°44'21.29"E 48 33°46'15.82"S 18°44'17.74"E 49 33°46'14.33"S 18°44'14.35"E	36	33°46'11.56"S	18°44'41.20"E		
39 33°46'21.03"S 18°44'44.58"E 40 33°46'24.09"S 18°44'45.98"E 41 33°46'26.05"S 18°44'46.98"E Secondary Runway 14-32 42 33°46'23.87"S 18°44'39.00"E 43 33°46'22.66"S 18°44'35.35"E 44 33°46'21.15"S 18°44'31.93"E 45 33°46'19.79"S 18°44'28.40"E 46 33°46'18.59"S 18°44'24.86"E 47 33°46'17.21"S 18°44'21.29"E 48 33°46'15.82"S 18°44'17.74"E 49 33°46'14.33"S 18°44'14.35"E		33°46'14.64"S	18°44'42.57"E		
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41 33°46'26.05"S 18°44'46.98"E Secondary Runway 14-32 42 33°46'23.87"S 18°44'39.00"E 43 33°46'22.66"S 18°44'35.35"E 44 33°46'21.15"S 18°44'31.93"E 45 33°46'19.79"S 18°44'28.40"E 46 33°46'18.59"S 18°44'24.86"E 47 33°46'17.21"S 18°44'21.29"E 48 33°46'15.82"S 18°44'17.74"E 49 33°46'14.33"S 18°44'14.35"E	39	33°46'21.03"S	18°44'44.58"E		
Secondary Runway 14-32 42 33°46'23.87"S 18°44'39.00"E 43 33°46'22.66"S 18°44'35.35"E 44 33°46'21.15"S 18°44'31.93"E 45 33°46'19.79"S 18°44'28.40"E 46 33°46'18.59"S 18°44'24.86"E 47 33°46'17.21"S 18°44'21.29"E 48 33°46'15.82"S 18°44'17.74"E 49 33°46'14.33"S 18°44'14.35"E	40	33°46'24.09"S	18°44'45.98"E		
42 33°46'23.87"S 18°44'39.00"E 43 33°46'22.66"S 18°44'35.35"E 44 33°46'21.15"S 18°44'31.93"E 45 33°46'19.79"S 18°44'28.40"E 46 33°46'18.59"S 18°44'24.86"E 47 33°46'17.21"S 18°44'21.29"E 48 33°46'15.82"S 18°44'17.74"E 49 33°46'14.33"S 18°44'14.35"E	41	33°46'26.05"S	18°44'46.98"E		
43 33°46'22.66"S 18°44'35.35"E 44 33°46'21.15"S 18°44'31.93"E 45 33°46'19.79"S 18°44'28.40"E 46 33°46'18.59"S 18°44'24.86"E 47 33°46'17.21"S 18°44'21.29"E 48 33°46'15.82"S 18°44'17.74"E 49 33°46'14.33"S 18°44'14.35"E	Secondary Runway 14-32				
43 33°46'22.66"S 18°44'35.35"E 44 33°46'21.15"S 18°44'31.93"E 45 33°46'19.79"S 18°44'28.40"E 46 33°46'18.59"S 18°44'24.86"E 47 33°46'17.21"S 18°44'21.29"E 48 33°46'15.82"S 18°44'17.74"E 49 33°46'14.33"S 18°44'14.35"E	42	33°46'23.87"S	18°44'39.00"E		
44 33°46'21.15"S 18°44'31.93"E 45 33°46'19.79"S 18°44'28.40"E 46 33°46'18.59"S 18°44'24.86"E 47 33°46'17.21"S 18°44'21.29"E 48 33°46'15.82"S 18°44'17.74"E 49 33°46'14.33"S 18°44'14.35"E	43	33°46'22.66"S			
46 33°46'18.59"S 18°44'24.86"E 47 33°46'17.21"S 18°44'21.29"E 48 33°46'15.82"S 18°44'17.74"E 49 33°46'14.33"S 18°44'14.35"E	44		18°44'31.93"E		
47 33°46'17.21"S 18°44'21.29"E 48 33°46'15.82"S 18°44'17.74"E 49 33°46'14.33"S 18°44'14.35"E	45				
47 33°46'17.21"S 18°44'21.29"E 48 33°46'15.82"S 18°44'17.74"E 49 33°46'14.33"S 18°44'14.35"E	46		18°44'24.86"E		
48 33°46'15.82"S 18°44'17.74"E 49 33°46'14.33"S 18°44'14.35"E	47				
49 33°46'14.33"S 18°44'14.35"E					
	49		18°44'14.35"E		
JU JO 40 12.73 J 10 44 10.11 E	50	33°46'12.79"S	18°44'10.11"E		



Figure 1: Coordinates 1 to 15 along Primary Runway 01-19



Figure 2: Coordinates 16 to 31 along Primary Runway 01-19

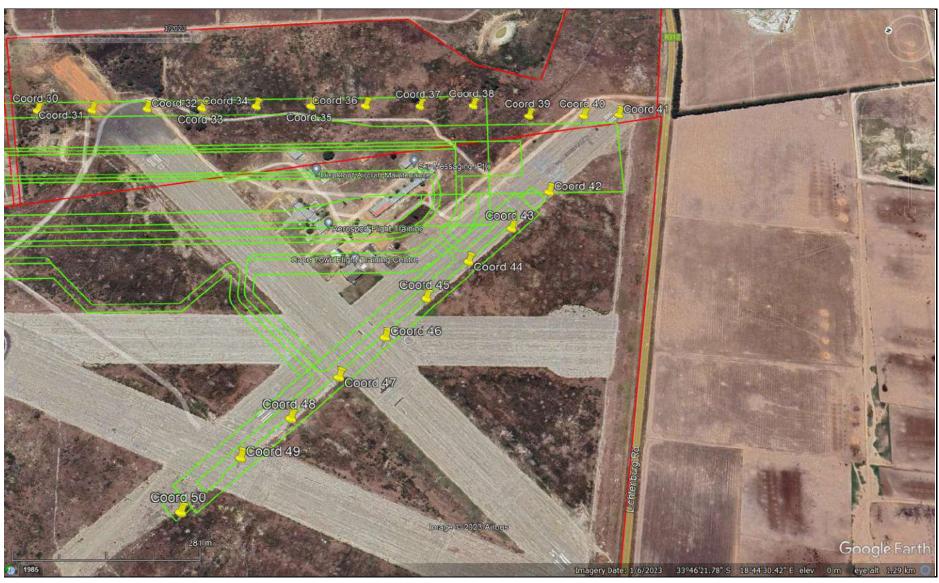


Figure 3: Coordinates 30 to 41 along Primary Runway 01-19 and Coordinates 42 to 50 along Secondary Runway 14-32