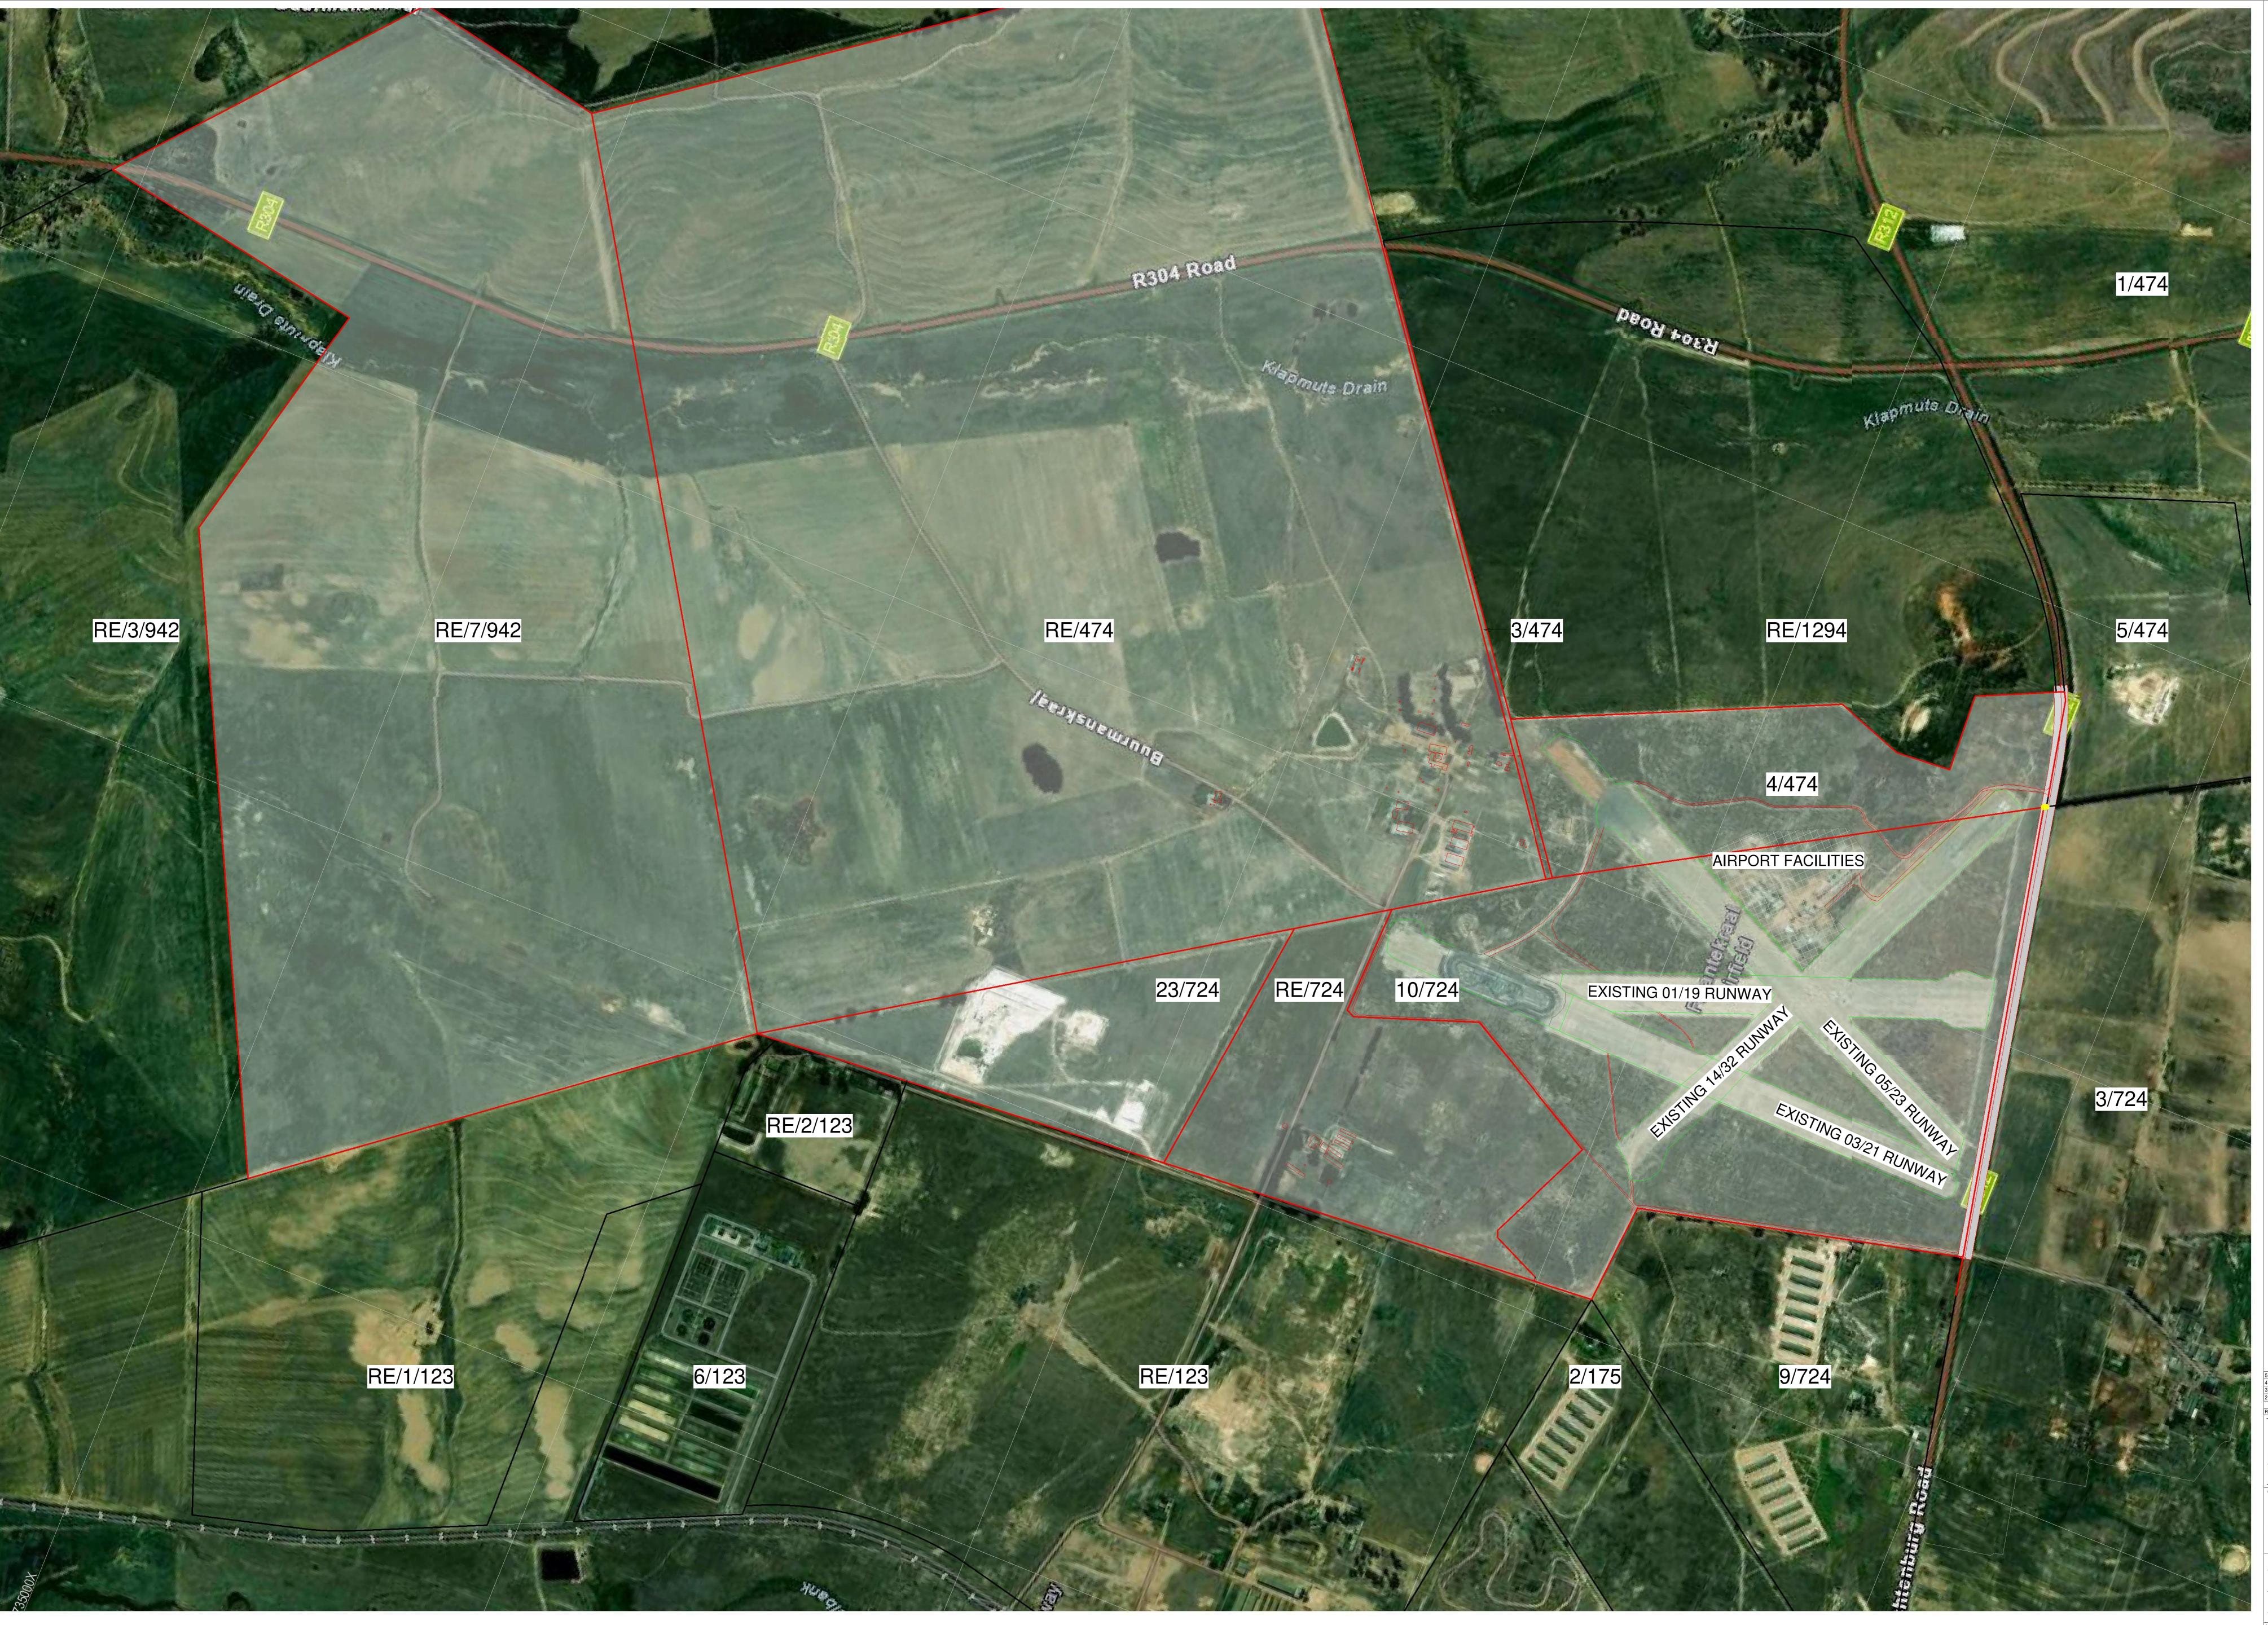
APPENDIX 25

SDP AND LINEAR LAYOUT WITH COORDINATES

DESCRIPTION ITEM N	NR.
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COMPOSITE PRECINCT PLAN	3
PHASE 1 SERVICES PRECINCT	4
PHASE 1 AIRSIDE PRECINCT	5
PHASE 1 TERMINAL PRECINCT	6
PHASE 1 GENERAL AVIATION PRECINCT	7
PRECINCT PLANS PHASE 2 - OVERVIEW	8
PHASE 2 SERVICES PRECINCT	9
PHASE 2 AIRSIDE PRECINCT	10
PHASE 2 TERMINAL PRECINCT	.11
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EXISTING SITE PLAN

O 62.5 m 125.0 m 250.0 m

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GENERAL NOTES

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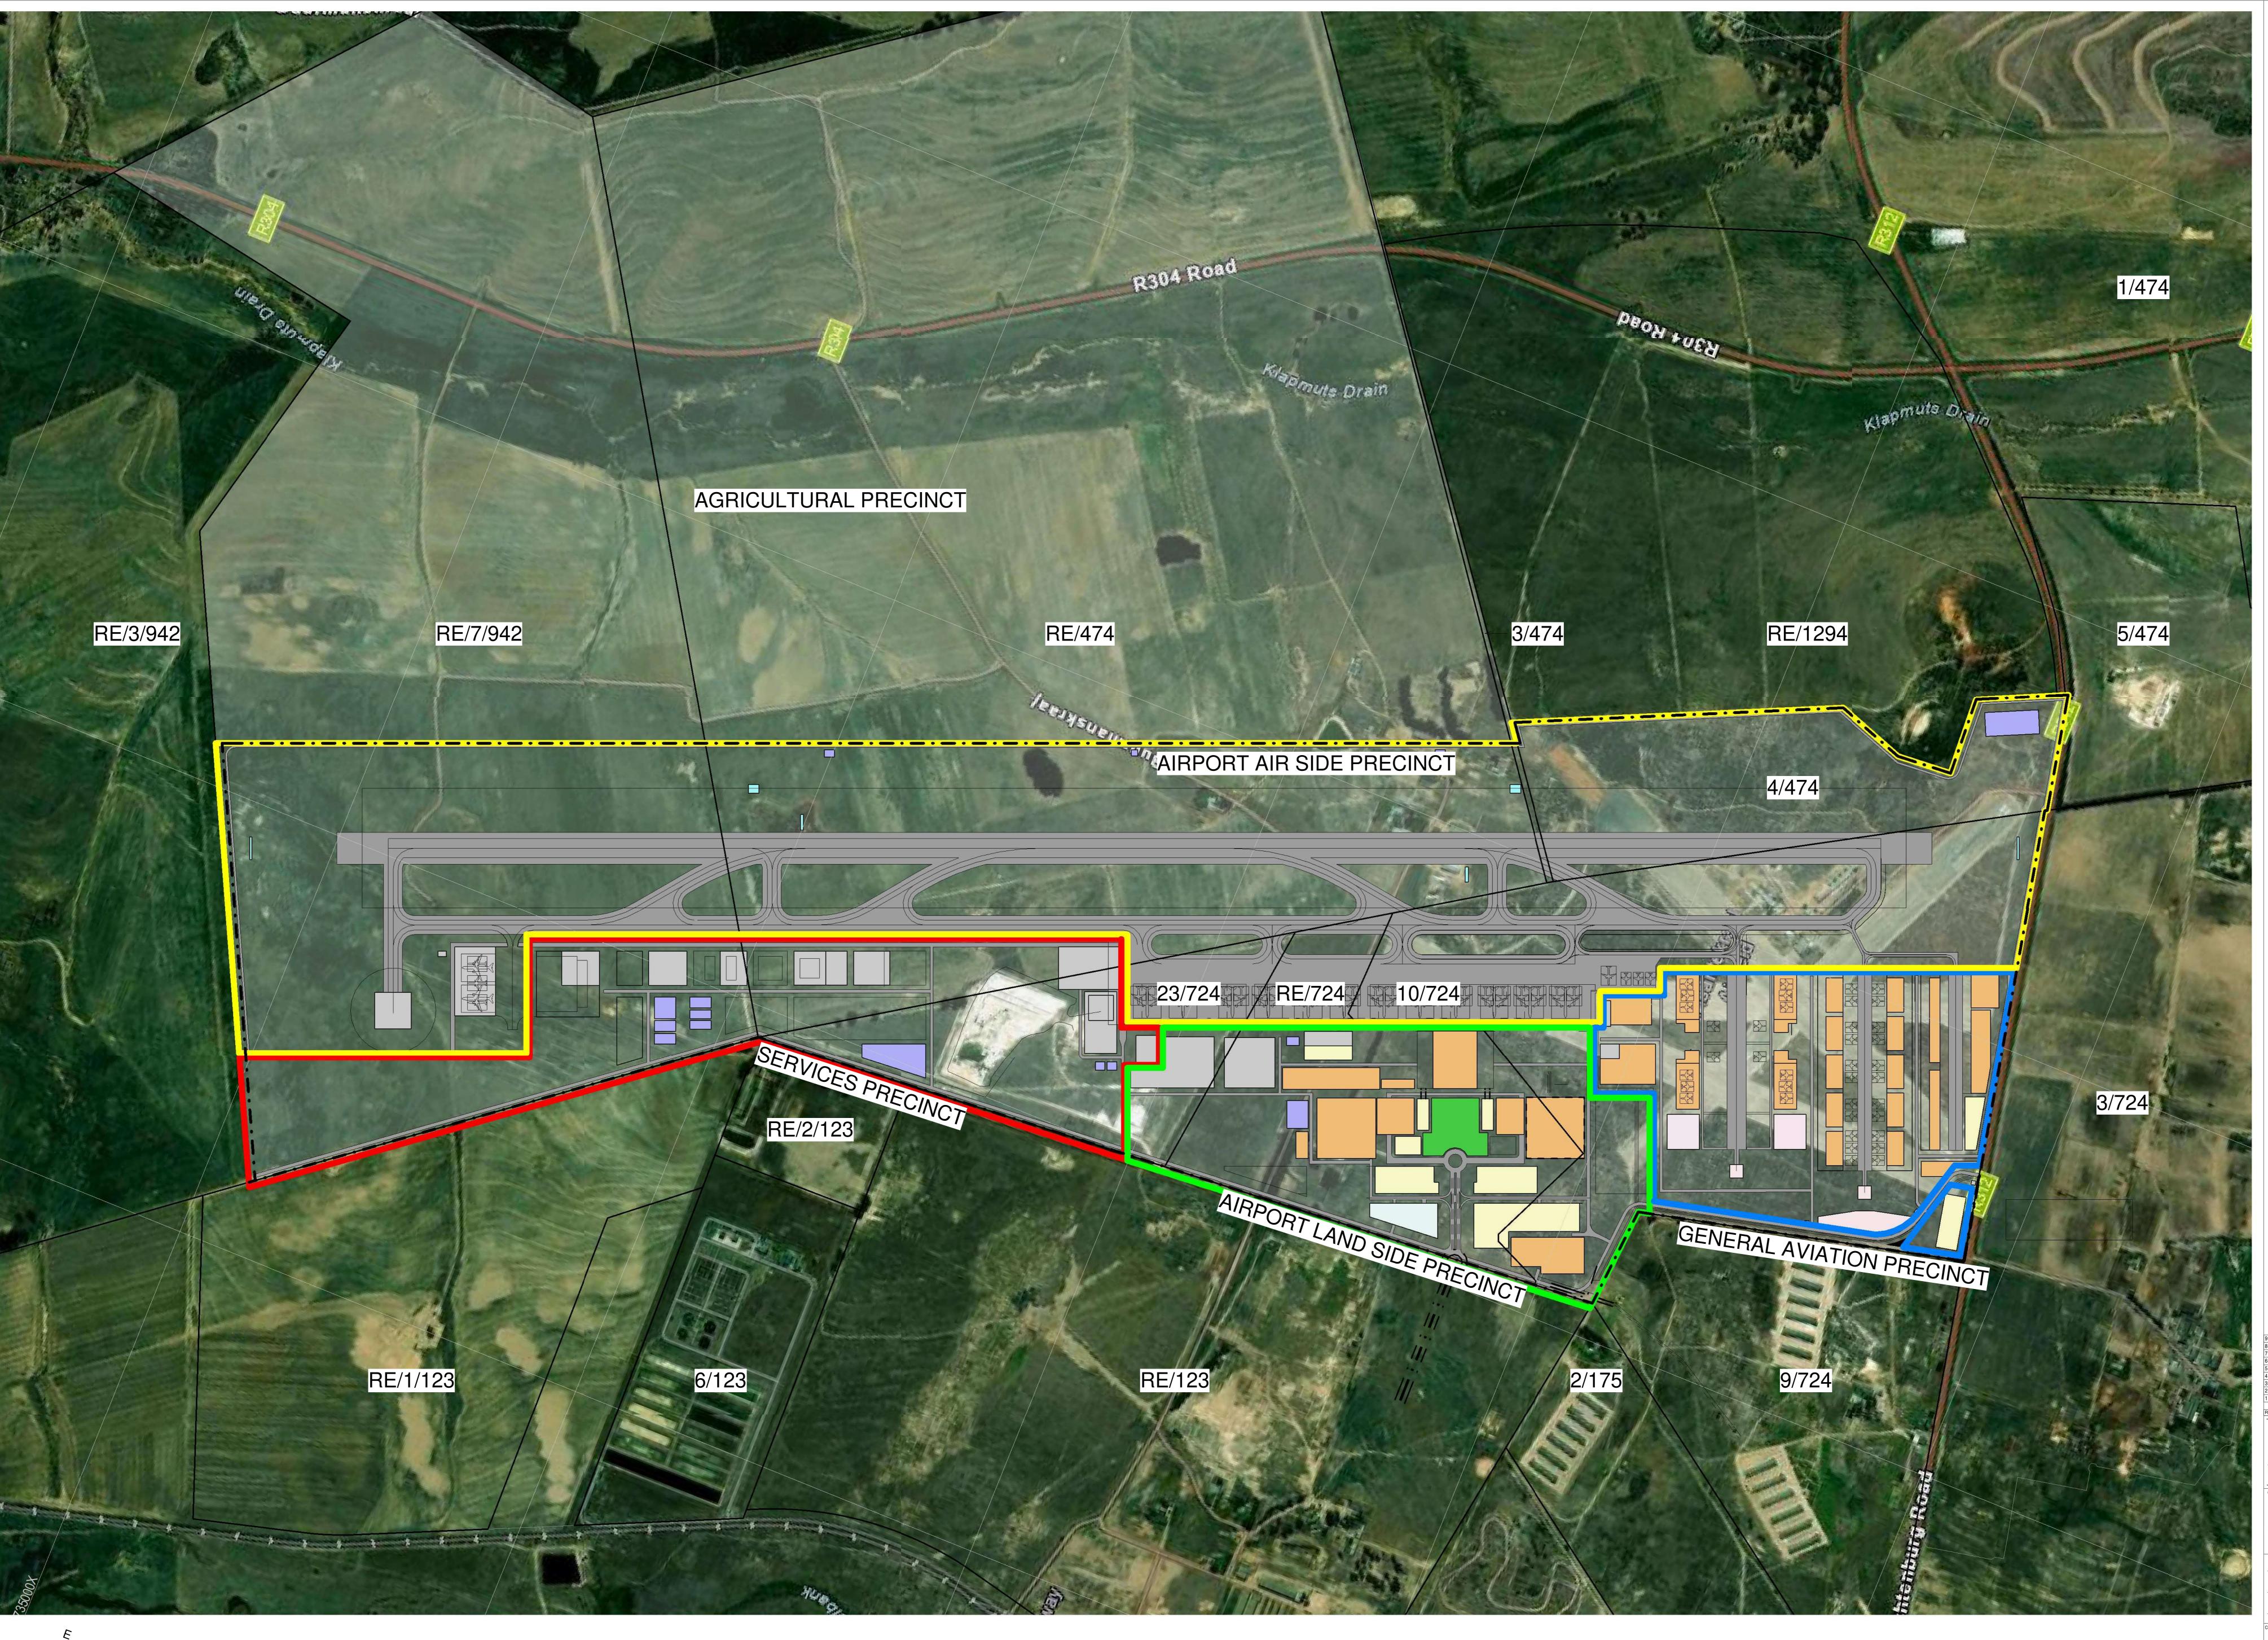
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2024-3297 100 5

DATE 2024-05-24 DRAWN BY: CW DENNIS



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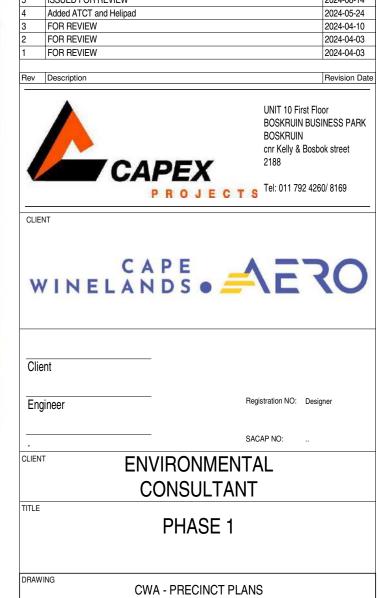
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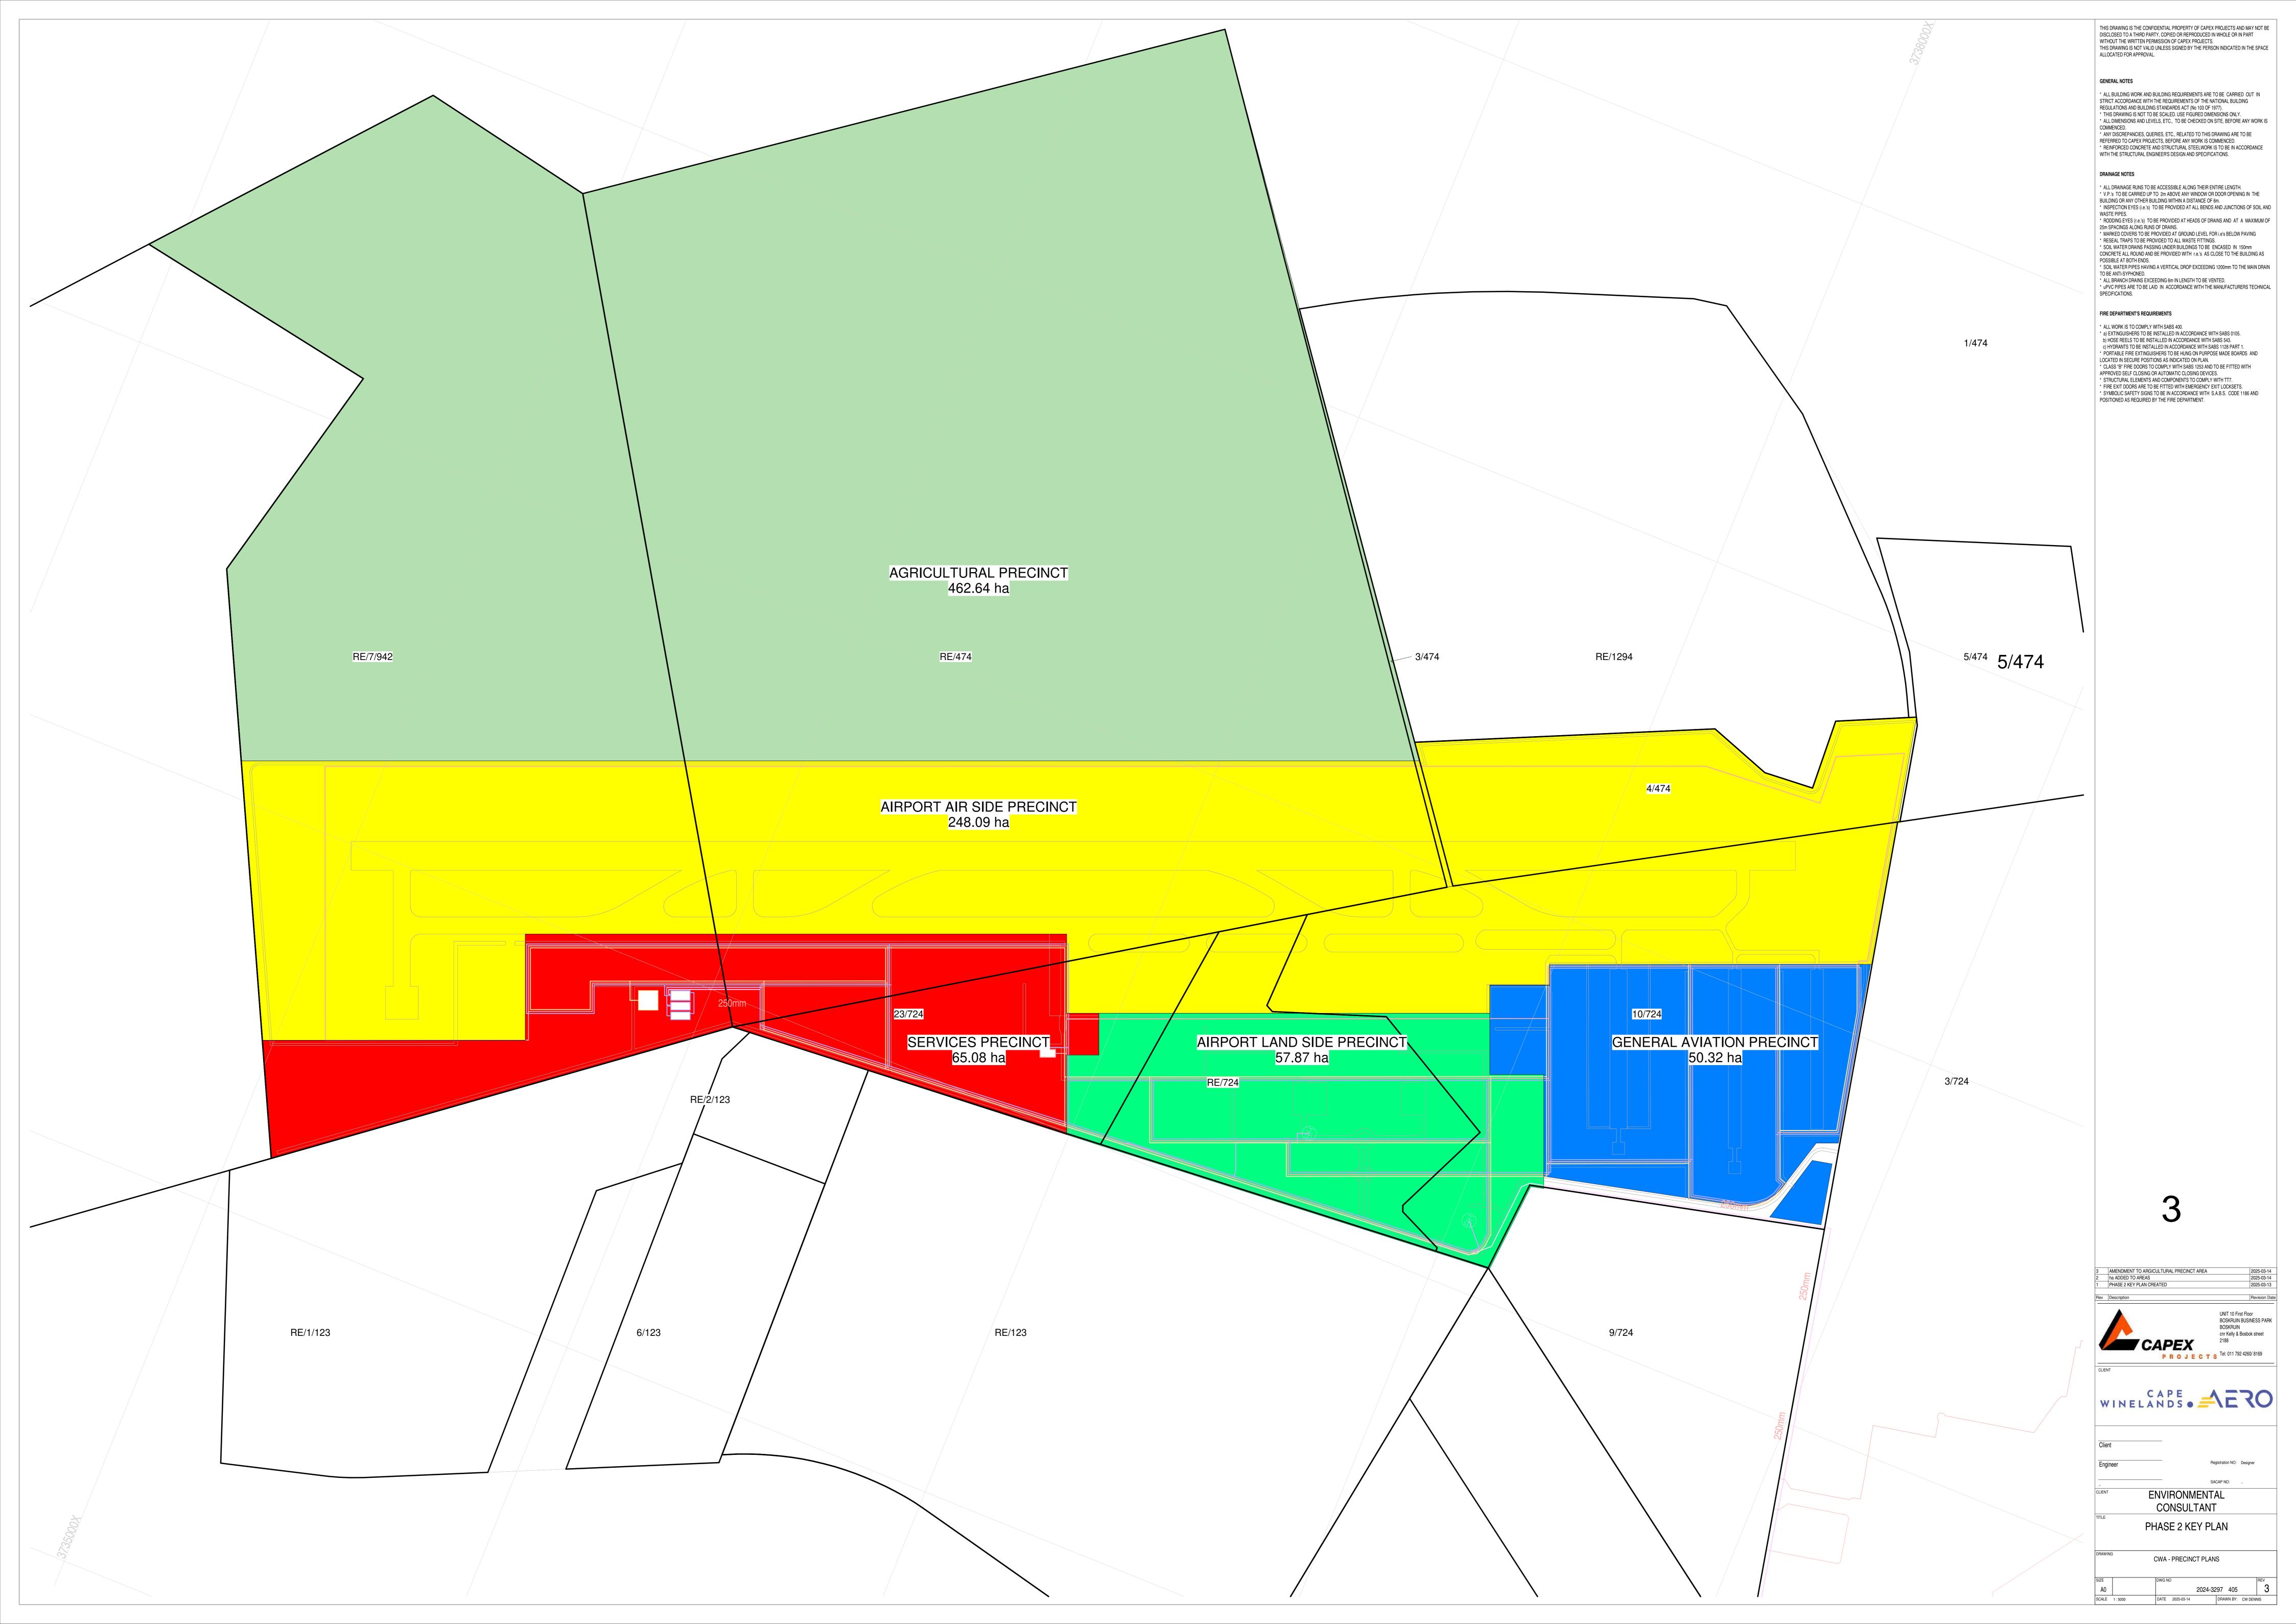
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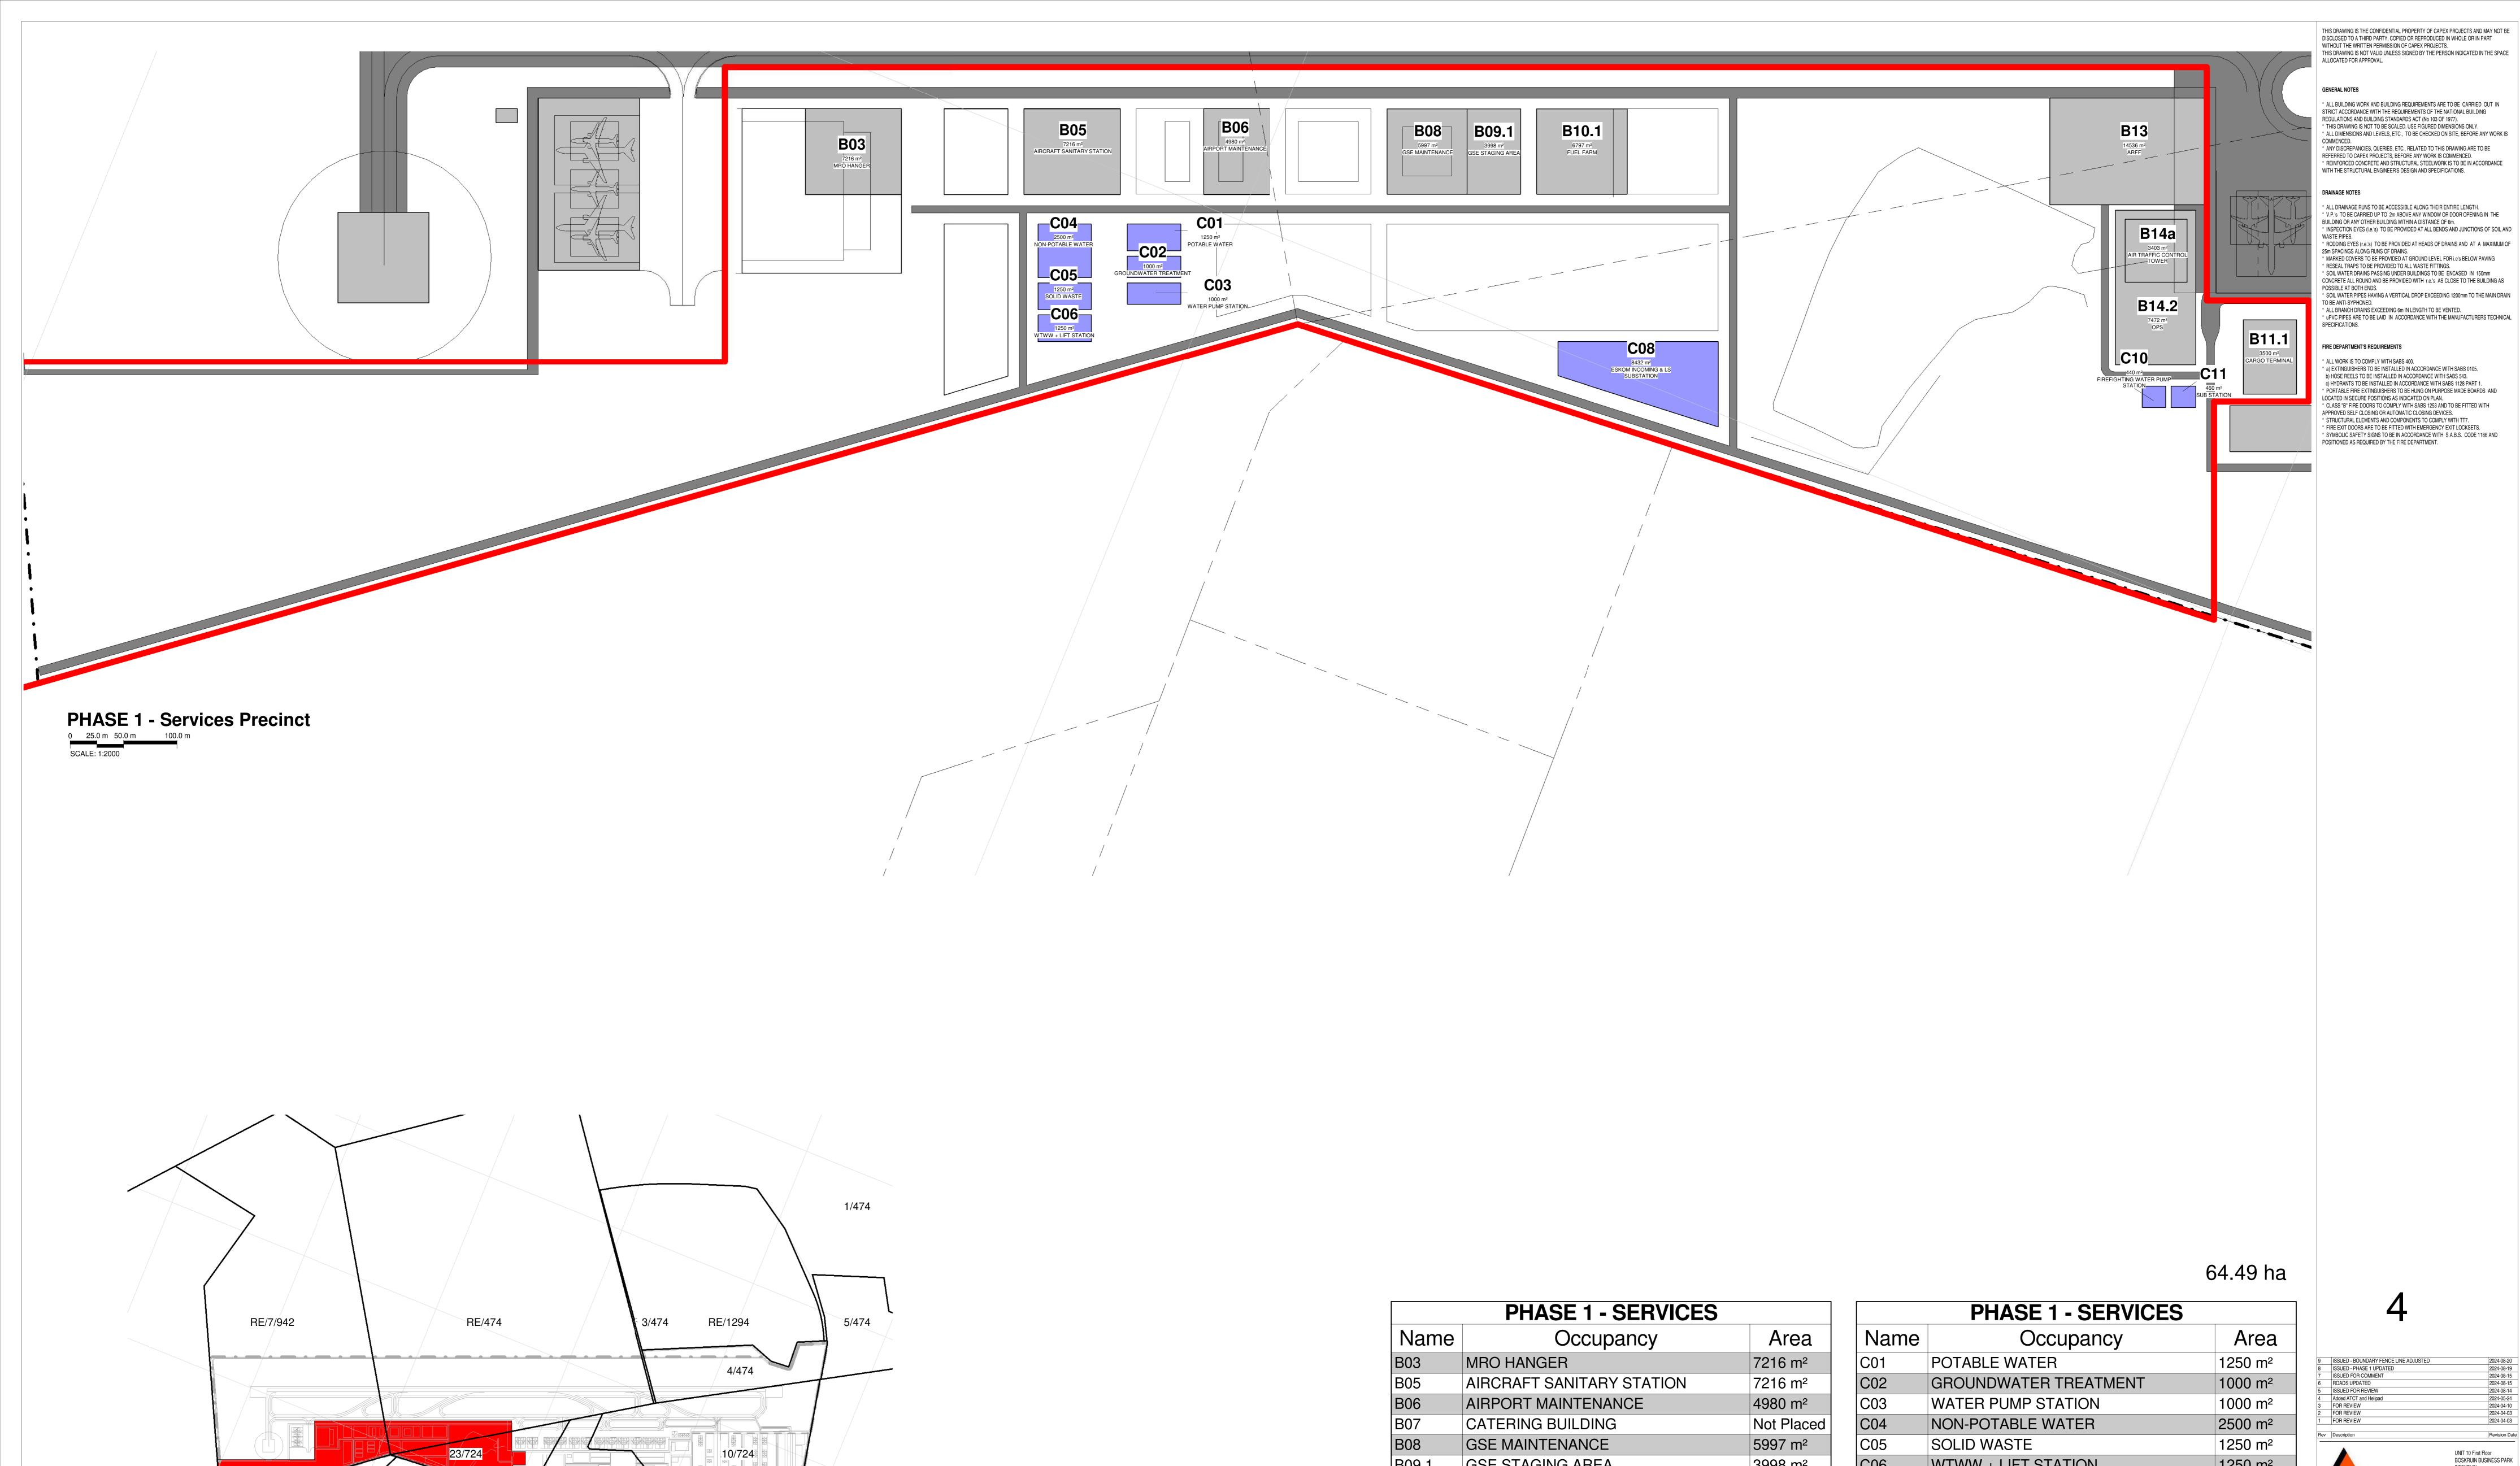
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2024-3297 408

DATE 2024-08-20 DRAWN BY: CW DENNIS





3/724

PHASE 1 - SERVICES			
Occupancy	Area		
MRO HANGER	7216 m ²		
AIRCRAFT SANITARY STATION	7216 m ²		
AIRPORT MAINTENANCE	4980 m ²		
CATERING BUILDING	Not Placed		
GSE MAINTENANCE	5997 m ²		
GSE STAGING AREA	3998 m ²		
FUEL FARM	6797 m ²		
FUEL FARM	Not Placed		
CARGO TERMINAL	3500 m ²		
ARFF	14536 m ²		
OPS	7472 m ²		
AIR TRAFFIC CONTROL TOWER	3403 m ²		
SUB STATION	260 m ²		
	Occupancy MRO HANGER AIRCRAFT SANITARY STATION AIRPORT MAINTENANCE CATERING BUILDING GSE MAINTENANCE GSE STAGING AREA FUEL FARM FUEL FARM CARGO TERMINAL ARFF OPS AIR TRAFFIC CONTROL TOWER		


PHASE 1 - SERVICES		
Name	Occupancy	Area
C01	POTABLE WATER	1250 m ²
C02	GROUNDWATER TREATMENT	1000 m ²
C03	WATER PUMP STATION	1000 m ²
C04	NON-POTABLE WATER	2500 m ²
C05	SOLID WASTE	1250 m ²
C06	WTWW + LIFT STATION	1250 m ²
C08	ESKOM INCOMING & LS SUBSTATION	8432 m ²
C10	FIREFIGHTING WATER PUMP STATION	440 m ²
C11	SUB STATION	460 m ²
E04.14	AIRPORT USE	Not Placed
E04.15	AIRPORT USE	Not Placed

/IRO	Mainter
BO	Fixed B
θA	Genera
SSE	Ground
ARFF	Aircraft
ATO	Final A
VTWP/WTWW	Wastev
RDTS	Remote
PAPI	Precision

tenance Repairs and Operations I Based Operators eral Aviation nd Support Equipment
aft Rescue and Firefighting
Approach and Take-off (Helipad)
tewater Treatment Plant / Works ote Digital Control Tower System sion Approach Path Indicator

9 8	ISSUED - BOUNDARY FENCE LINE ADJUSTED ISSUED - PHASE 1 UPDATED	2024-08-20 2024-08-19
7	ISSUED FOR COMMENT	2024-08-15
6	ROADS UPDATED	2024-08-15
5	ISSUED FOR REVIEW	2024-08-14
4	Added ATCT and Helipad	2024-05-24
3	FOR REVIEW	2024-04-10
2	FOR REVIEW	2024-04-03
1	FOR REVIEW	2024-04-03



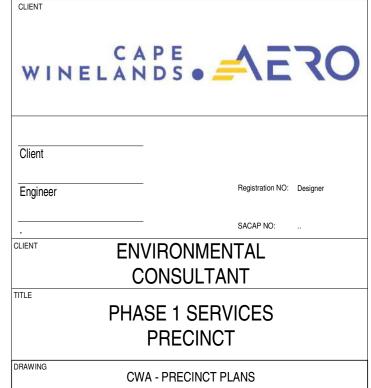

2024-3297 410 9

DATE 2024-08-20 DRAWN BY: CW DENNIS

A0 SCALE As indicated


Key Plan - PHASE 1 Services Precinct

RE/1/123

RE/2/123

6/123

RE/123

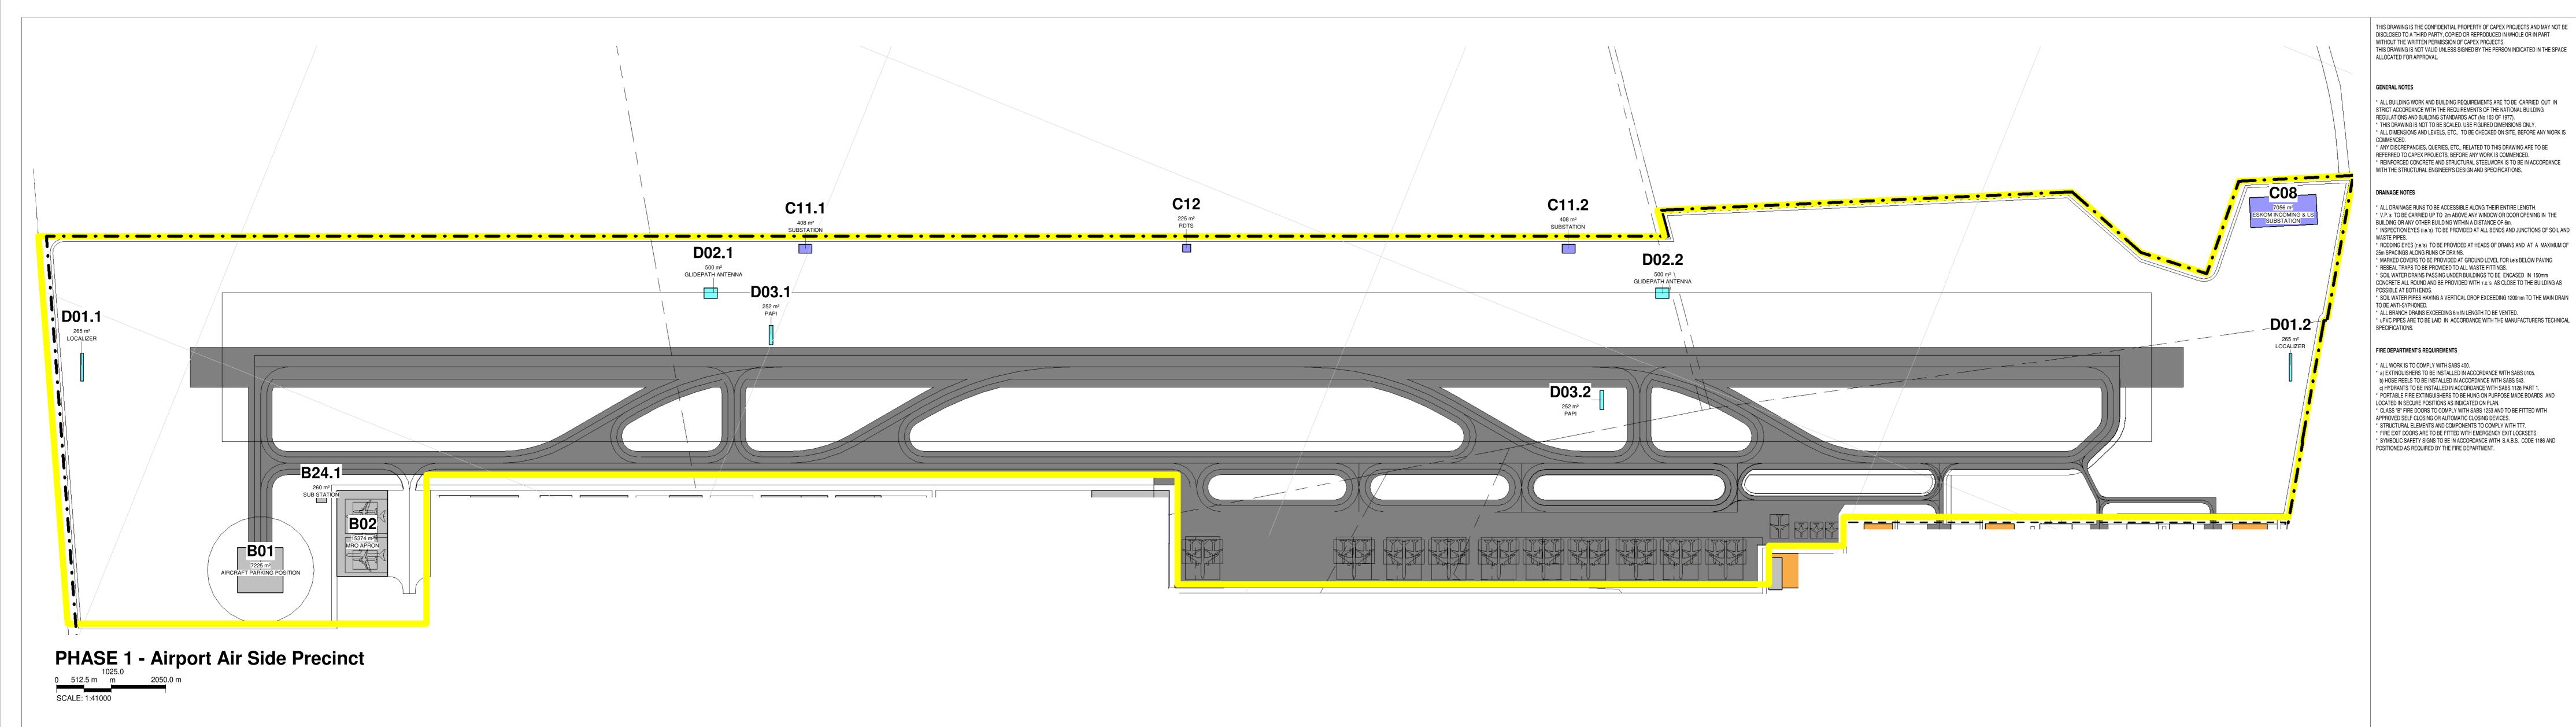

248.41 ha

	PHASE 1 - AIR SIDE			
Name	Occupancy	Area	Name	,
B01	AIRCRAFT PARKING POSITION	7225 m ²	C08	E
B02	MRO APRON	15374 m²	C11.1	5
B12	CARGO APRON	Not Placed	C11.2	ξ
			C12	Г

MRO	Maintenance Repairs and Operations
FBO	Fixed Based Operators
GA	General Aviation
GSE	Ground Support Equipment
ARFF	Aircraft Rescue and Firefighting
FATO	Final Approach and Take-off (Helipad)
WTWP/WTWW	Wastewater Treatment Plant / Works
RDTS	Remote Digital Control Tower System
PAPI	Precision Approach Path Indicator

C11.1	SUBSTATION	408 m ²	
C11.2	SUBSTATION	408 m ²	
C12	RDTS	225 m ²	
PHASE 1 - AIR SIDE			
Name	Occupancy	Area	
D01.1	LOCALIZER	265 m ²	
D01.2	LOCALIZER	265 m ²	
D02.1	GLIDEPATH ANTENNA	500 m ²	

GLIDEPATH ANTENNA

PAPI

PAPI

PHASE 1 - AIR SIDE

Occupancy

ESKOM INCOMING & LS SUBSTATION

Area

7056 m²

500 m²

252 m²

252 m²

9 ISSUED - BOUNDARY FENCE LINE ADJUSTED
8 ISSUED - PHASE 1 UPDATED
7 ISSUED FOR COMMENT
6 ROADS UPDATED
5 ISSUED FOR REVIEW
4 Added ATCT and Helipad
3 FOR REVIEW
2 FOR REVIEW
1 FOR REVIEW UNIT 10 First Floor BOSKRUIN BUSINESS PARK BOSKRUIN cnr Kelly & Bosbok street WINELANDS . AERO ENVIRONMENTAL

CONSULTANT

PHASE 1 AIRPORT AIR SIDE PRECINCT


CWA - PRECINCT PLANS

SCALE As indicated

2024-3297 412 9

DATE 2024-08-20 DRAWN BY: CW DENNIS

2024-08-20 2024-08-19 2024-08-15 2024-08-15 2024-08-14 2024-05-24 2024-04-10 2024-04-03 2024-04-03

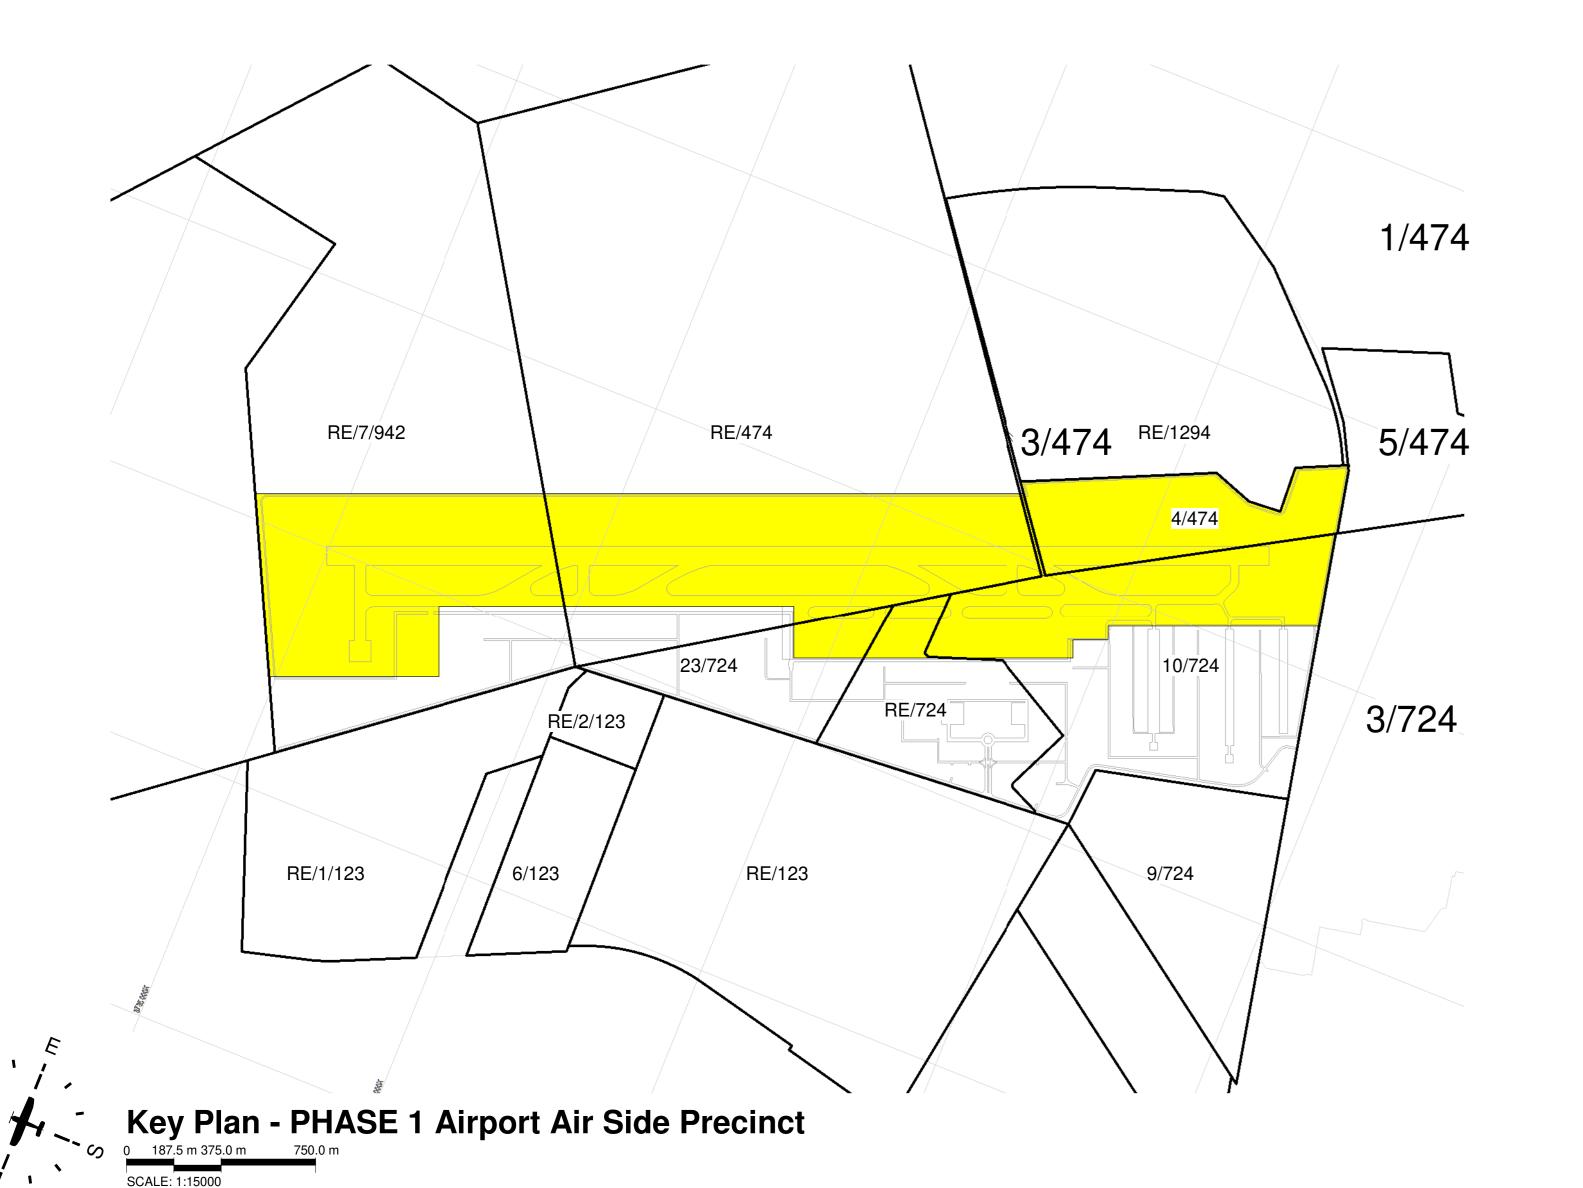



RE/123

RE/1/123

6/123

Key Plan - PHASE 1 Airport Terminal Precinct

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PHASE 1 - TERMINAL PRECINCT		
Name	Occupancy	Area
B09.2	GSE STAGING	3819 m ²
B11.2	CARGO	17436 m²
B11.3	CARGO	14043 m ²
C09	ENERGY CENTRE	3250 m ²
C11.1	AS SS	600 m ²

GSE ARFF FATO WTWP/WTWW PAPI

Ground Support Equipment
Aircraft Rescue and Firefighting Final Approach and Take-off (Helipad) Wastewater Treatment Plant / Works Remote Digital Control Tower System Precision Approach Path Indicator

	ISSUED - BOUNDARY FENCE LINE ADJUSTED	2024-08-20
	ISSUED - PHASE 1 UPDATED	2024-08-19
	ISSUED FOR COMMENT	2024-08-15
	ROADS UPDATED	2024-08-15
	ISSUED FOR REVIEW	2024-08-14
	Added ATCT and Helipad	2024-05-24
	FOR REVIEW	2024-04-10
	FOR REVIEW	2024-04-03
	FOR REVIEW	2024-04-03
v	Description	Revision Date





DATE 2024-08-20

SCALE As indicated

2024-3297 409 9



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UNIT 10 First Floor BOSKRUIN BUSINESS PARK BOSKRUIN cnr Kelly & Bosbok street

WINELANDS . AERO

ENVIRONMENTAL CONSULTANT PHASE 1 GENERAL **AVIATION PRECINCT** CWA - PRECINCT PLANS

DATE 2024-08-20

2024-3297 411 9



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15	BH, COCT Water Line, Fuel Line and Boundary Adjustments	2025-01-15
14	ISSUED - BOUNDARY FENCE LINE ADJUSTED	2024-08-20
13	ISSUED - PHASE 1 UPDATED	2024-08-19
12	ISSUED FOR REVIEW	2024-08-14
11	ISSUED TO PROFESSIONALS	2024-07-24
10	ISSUED	2024-07-24
9	ISSUED	2024-07-24
8	ISSUED	2024-07-23
7	Revised SDP/EIA For Comment	2024-07-23
6	Revised SDP/EIA For Comment	2024-07-23
5	Added ATCT and Helipad	2024-05-24
4	FOR REVIEW	2024-04-10
3	FOR REVIEW	2024-04-03
2	FOR REVIEW	2024-04-03
1	FOR REVIEW	2024-03-28
Rev	Description	Revision Date









ENVIRONMENTAL CONSULTANT PHASE 2

CWA - PRECINCT PLANS

2024-3297 400 **16**DATE 2025-01-23 DRAWN BY: CW DENNIS

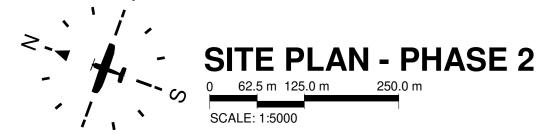

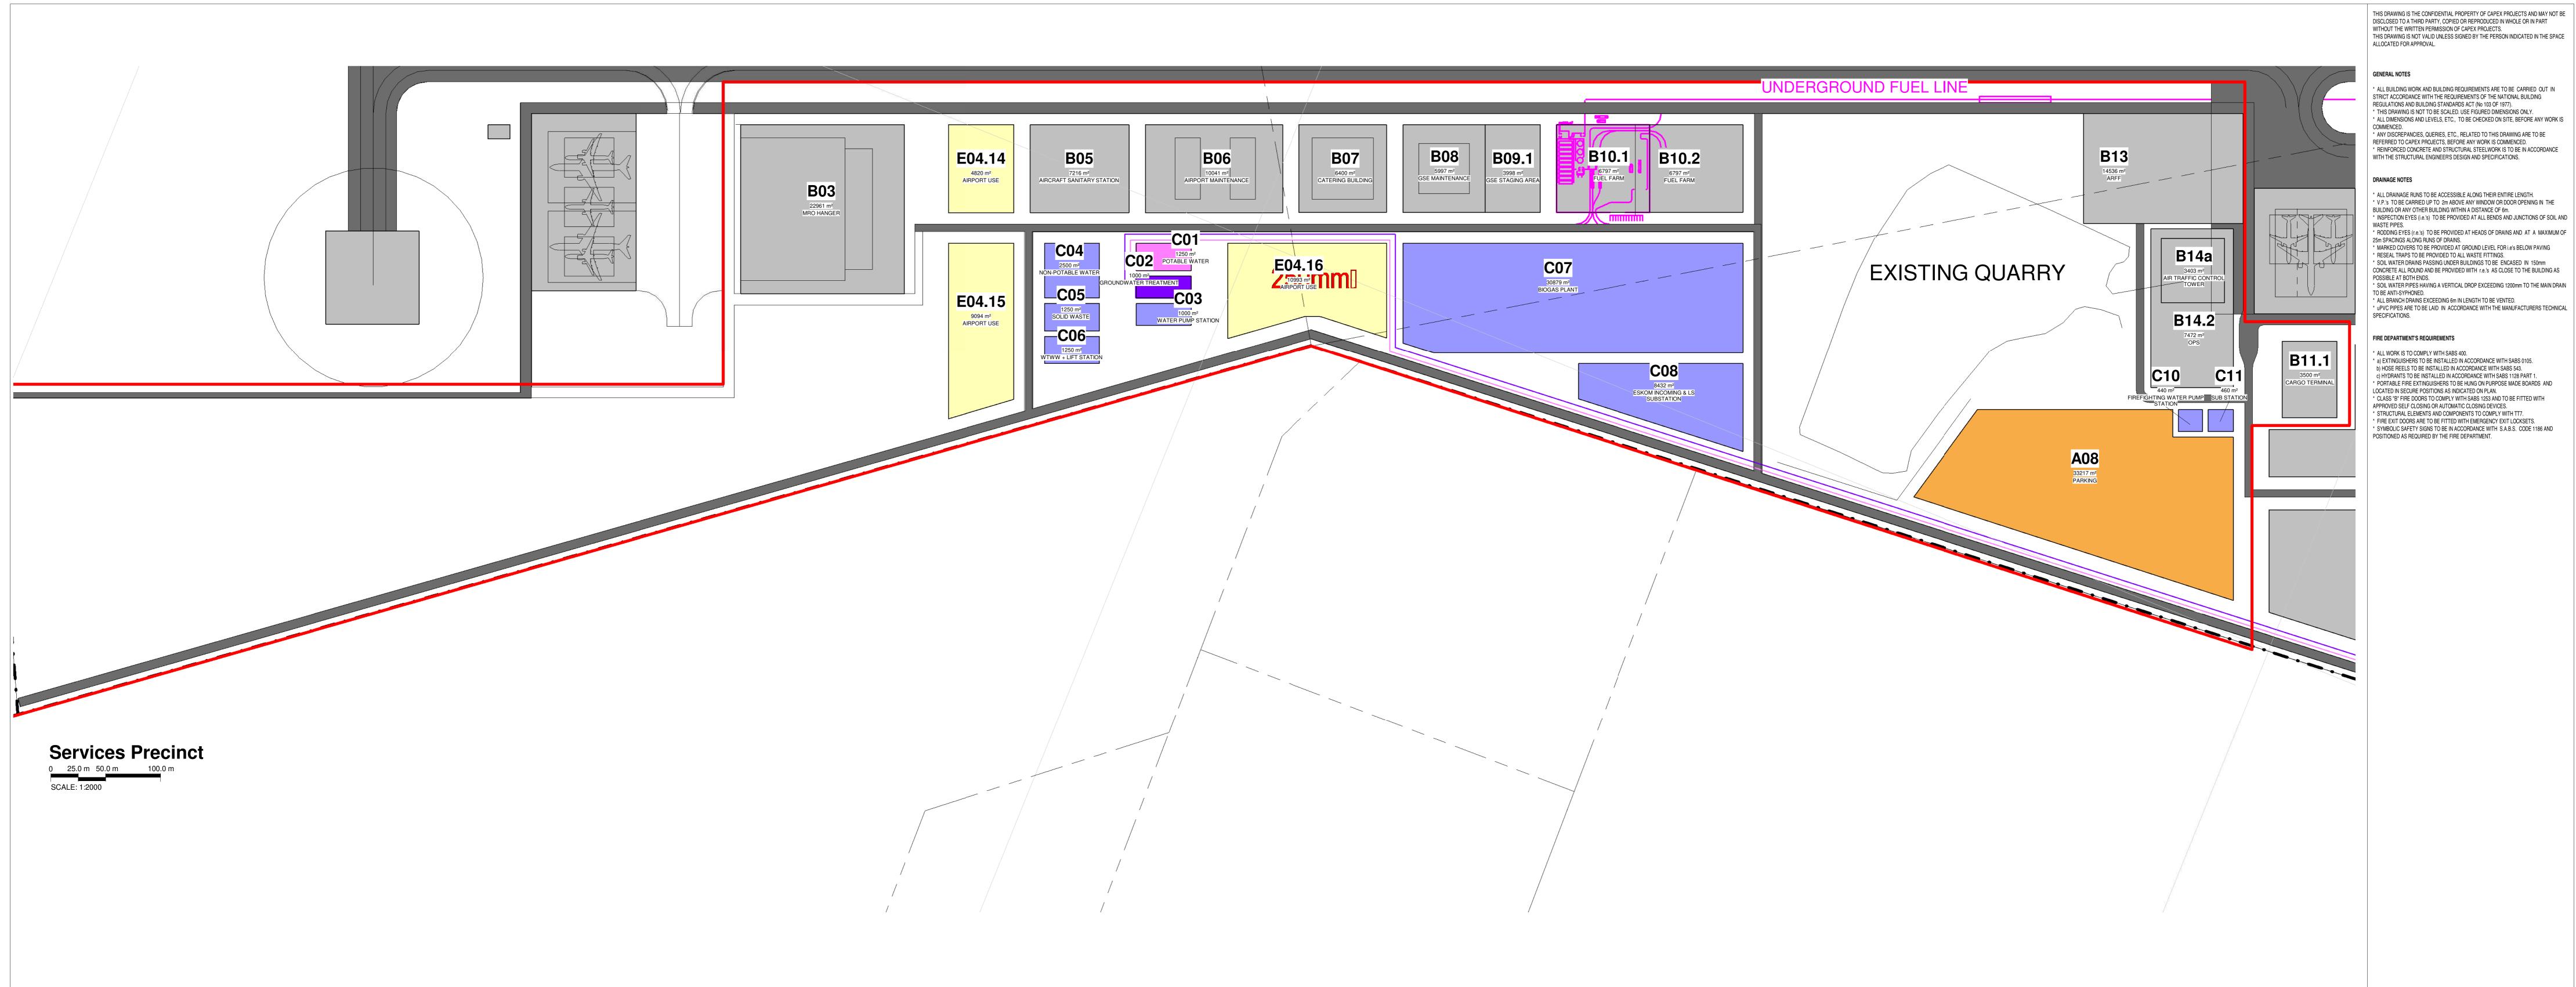

64.49 ha

Name	Occupancy	Plot Area
A08	PARKING	33217 m ²
B03	MRO HANGER	22961 m ²
B05	AIRCRAFT SANITARY STATION	7216 m ²
B06	AIRPORT MAINTENANCE	10041 m ²
B07	CATERING BUILDING	6400 m ²
B08	GSE MAINTENANCE	5997 m ²
B09.1	GSE STAGING AREA	3998 m ²
B10.1	FUEL FARM	6797 m ²
B10.2	FUEL FARM	6797 m ²
B11.1	CARGO TERMINAL	3500 m ²
B13	ARFF	14536 m ²
B14.2	OPS	7472 m ²
B14a	AIR TRAFFIC CONTROL TOWER	3403 m ²

Name	Occupancy	Plot Area
C01	POTABLE WATER	1250 m ²
C02	GROUNDWATER TREATMENT	1000 m ²
C03	WATER PUMP STATION	1000 m ²
C04	NON-POTABLE WATER	2500 m ²
C05	SOLID WASTE	1250 m ²
C06	WTWW + LIFT STATION	1250 m ²
C07	BIOGAS PLANT	30879 m ²
C08	ESKOM INCOMING & LS SUBSTATION	8432 m ²
C10	FIREFIGHTING WATER PUMP STATION	440 m ²
C11	SUB STATION	460 m ²


Name	Occupancy	Plot Area
E04.14	AIRPORT USE	4820 m ²
E04.15	AIRPORT USE	9094 m ²
E04.16	AIRPORT USE	10993 m ²

MRO FBO GSE ARFF WTWP/WTWW RDTS PAPI


Maintenance Repairs and Operations Fixed Based Operators General Aviation Ground Support Equipment
Aircraft Rescue and Firefighting
Final Approach and Take-off (Helipad)
Wastewater Treatment Plant / Works
Remote Digital Control Tower System
Precision Approach Path Indicator

16	Amendment to B09, Update to table names	2025-01-23
15	BH, COCT Water Line, Fuel Line and Boundary Adjustments	2025-01-15
14	ISSUED - BOUNDARY FENCE LINE ADJUSTED	2024-08-20
13	ISSUED - PHASE 1 UPDATED	2024-08-19
12	ISSUED FOR REVIEW	2024-08-14
11	ISSUED TO PROFESSIONALS	2024-07-24
10	ISSUED	2024-07-24
9	ISSUED	2024-07-24
8	ISSUED	2024-07-23
7	Revised SDP/EIA For Comment	2024-07-23
6	Revised SDP/EIA For Comment	2024-07-23
5	Added ATCT and Helipad	2024-05-24
4	FOR REVIEW	2024-04-10
3	FOR REVIEW	2024-04-03
2	FOR REVIEW	2024-04-03
1	FOR REVIEW	2024-03-28
	·	
Rev	Description	Revision Date




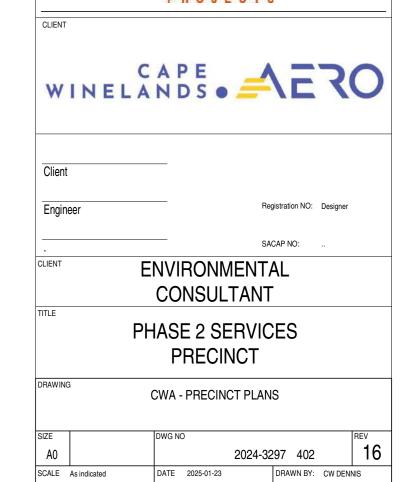

DATE 2025-01-23 DRAWN BY: CW DENNIS

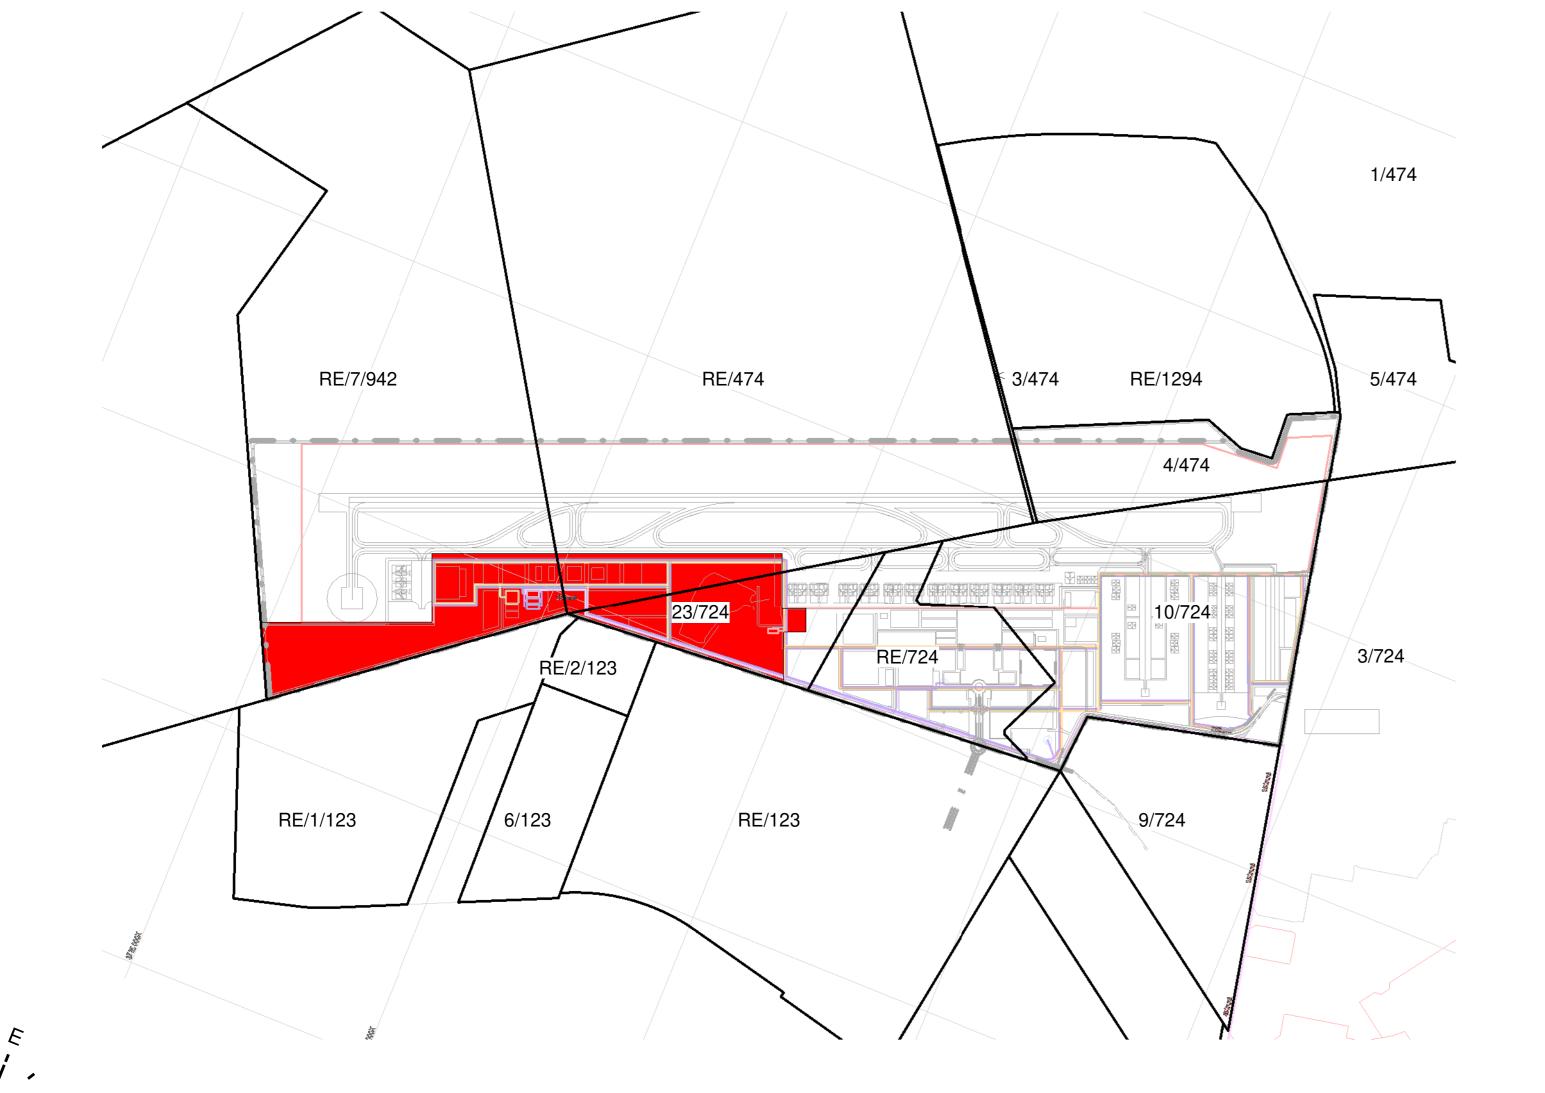

Key Plan - Services Precinct

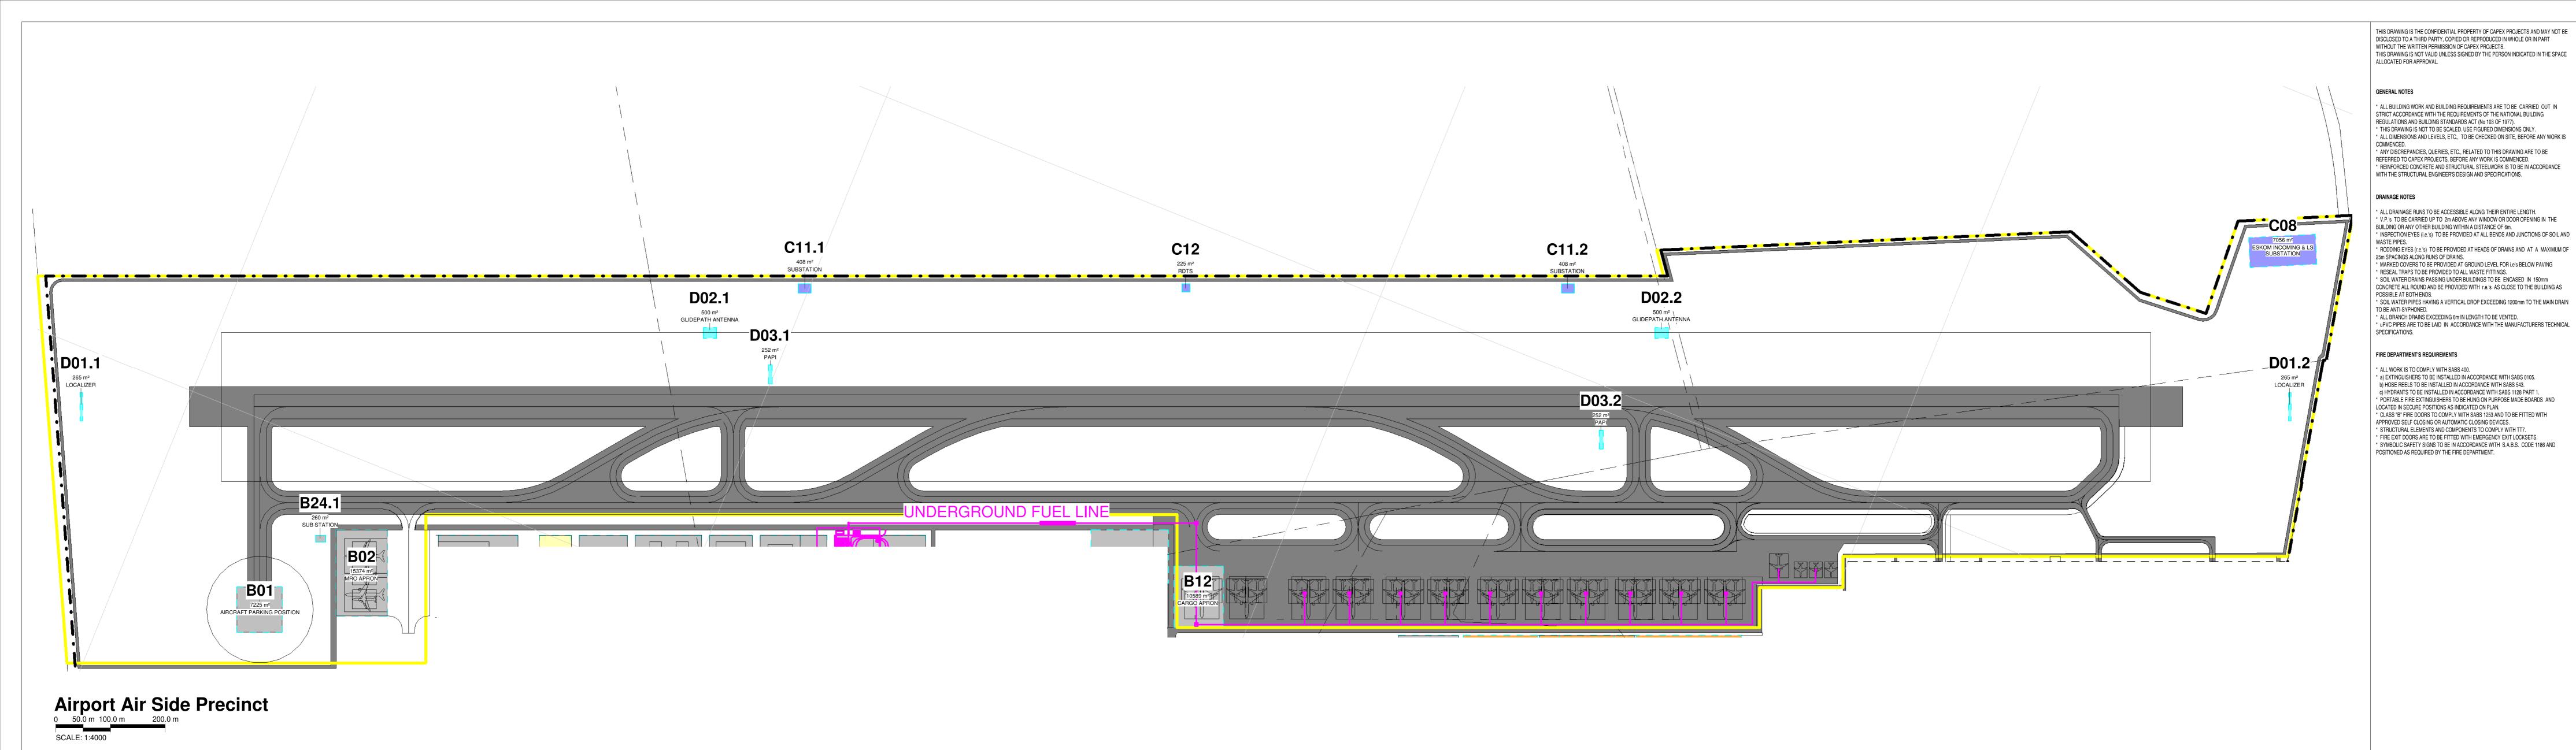


248.41 ha

Name	Occupancy	Plot Area
B01	AIRCRAFT PARKING POSITION	7225 m ²
B02	MRO APRON	15374 m²
B12	CARGO APRON	10589 m²
B24.1	SUB STATION	260 m ²


Maintenance Repairs and Operations Fixed Based Operators General Aviation FBO GSE ARFF FATO Ground Support Equipment
Aircraft Rescue and Firefighting Final Approach and Take-off (Helipad)
Wastewater Treatment Plant / Works
Remote Digital Control Tower System
Precision Approach Path Indicator WTWP/WTWW RDTS PAPI

Name	Occupancy	Plot Area
C08	ESKOM INCOMING & LS SUBSTATION	7056 m ²
C11.1	SUBSTATION	408 m ²
C11.2	SUBSTATION	408 m ²
C12	RDTS	225 m ²
D01.1	LOCALIZER	265 m ²
D01.2	LOCALIZER	265 m ²
D02.1	GLIDEPATH ANTENNA	500 m ²
D02.2	GLIDEPATH ANTENNA	500 m ²
D03.1	PAPI	252 m ²
D03.2	PAPI	252 m ²

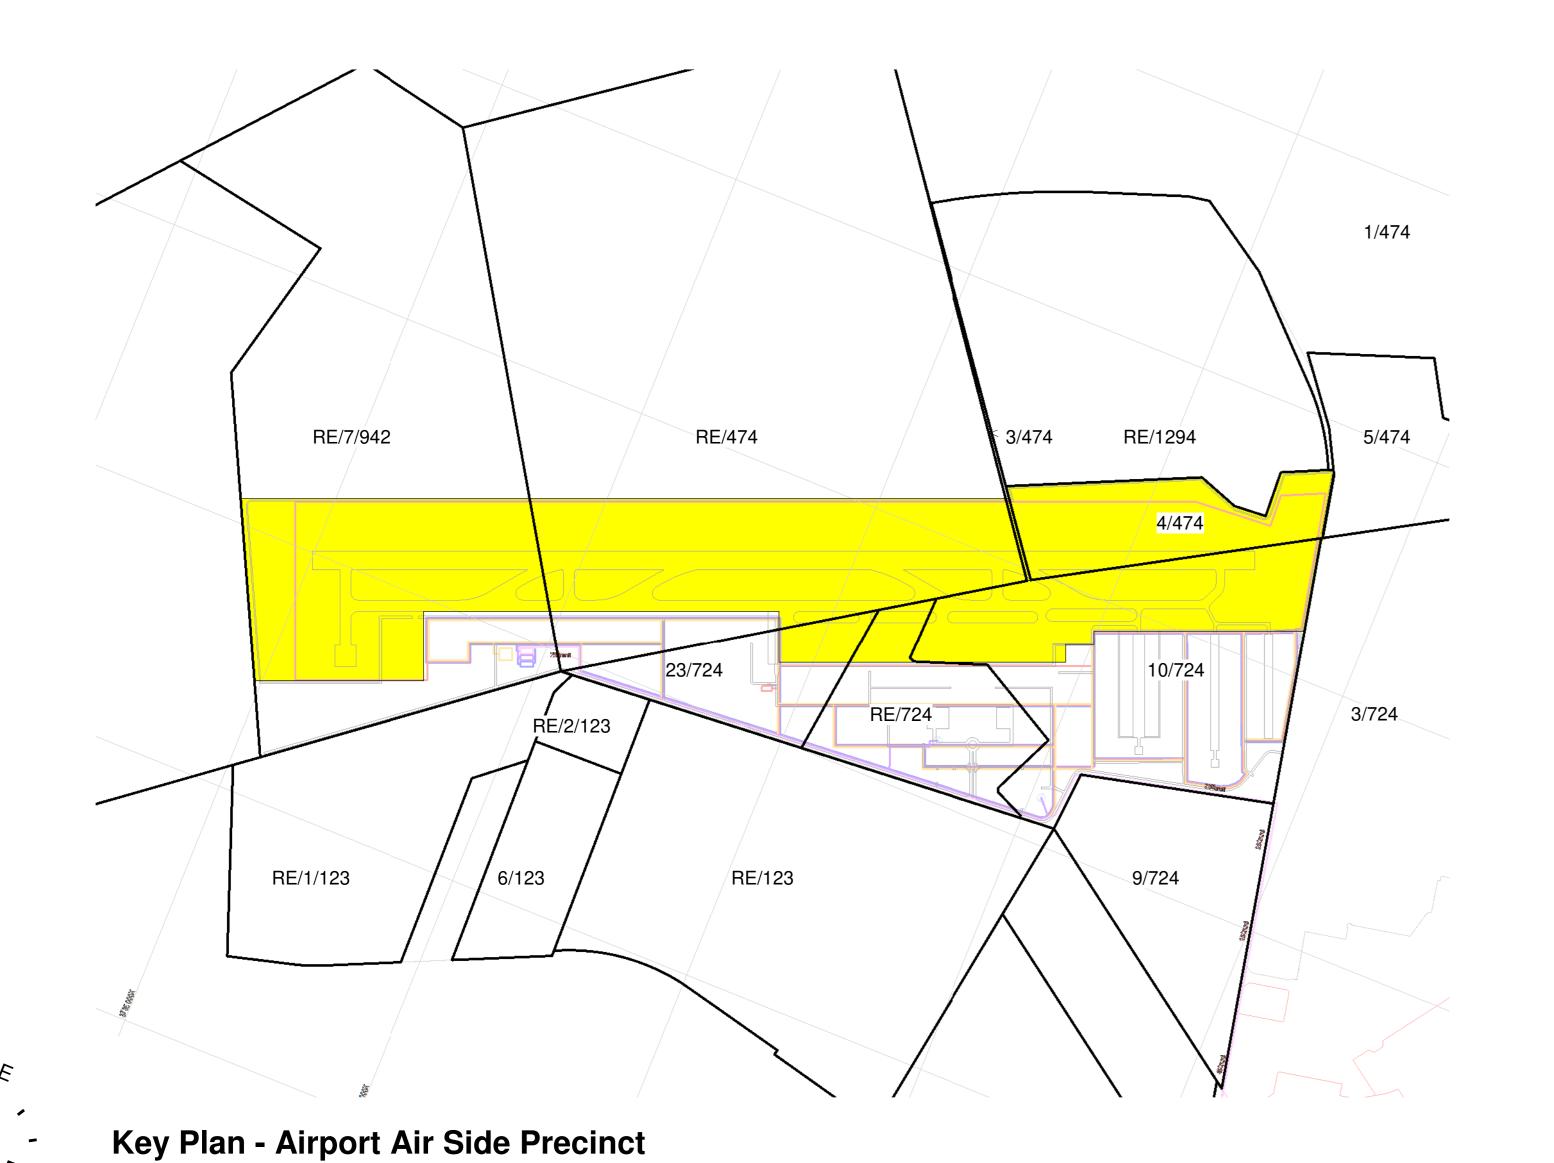

2025-01-23 2025-01-15 2024-08-20 2024-08-19 2024-07-24 2024-07-24 2024-07-24 2024-07-23 2024-07-23 2024-07-23 2024-04-03 2024-04-03 2024-04-03 2024-03-28 ISSUED
ISSUED
ISSUED
Revised SDP/EIA For Comment
Revised SDP/EIA For Comment
Added ATCT and Helipad
FOR REVIEW
FOR REVIEW
FOR REVIEW
FOR REVIEW
FOR REVIEW UNIT 10 First Floor BOSKRUIN BUSINESS PARK BOSKRUIN cnr Kelly & Bosbok street 2188 WINELANDS . AERO ENVIRONMENTAL CONSULTANT PHASE 2 AIRPORT AIR SIDE PRECINCT CWA - PRECINCT PLANS 2024-3297 404 16 DATE 2025-01-23 DRAWN BY: CW DENNIS

Amendment to B09, Update to table names
BH, COCT Water Line, Fuel Line and Boundary Adjustments
ISSUED - BOUNDARY FENCE LINE ADJUSTED
ISSUED - PHASE 1 UPDATED
ISSUED FOR REVIEW
ISSUED TO PROFESSIONALS

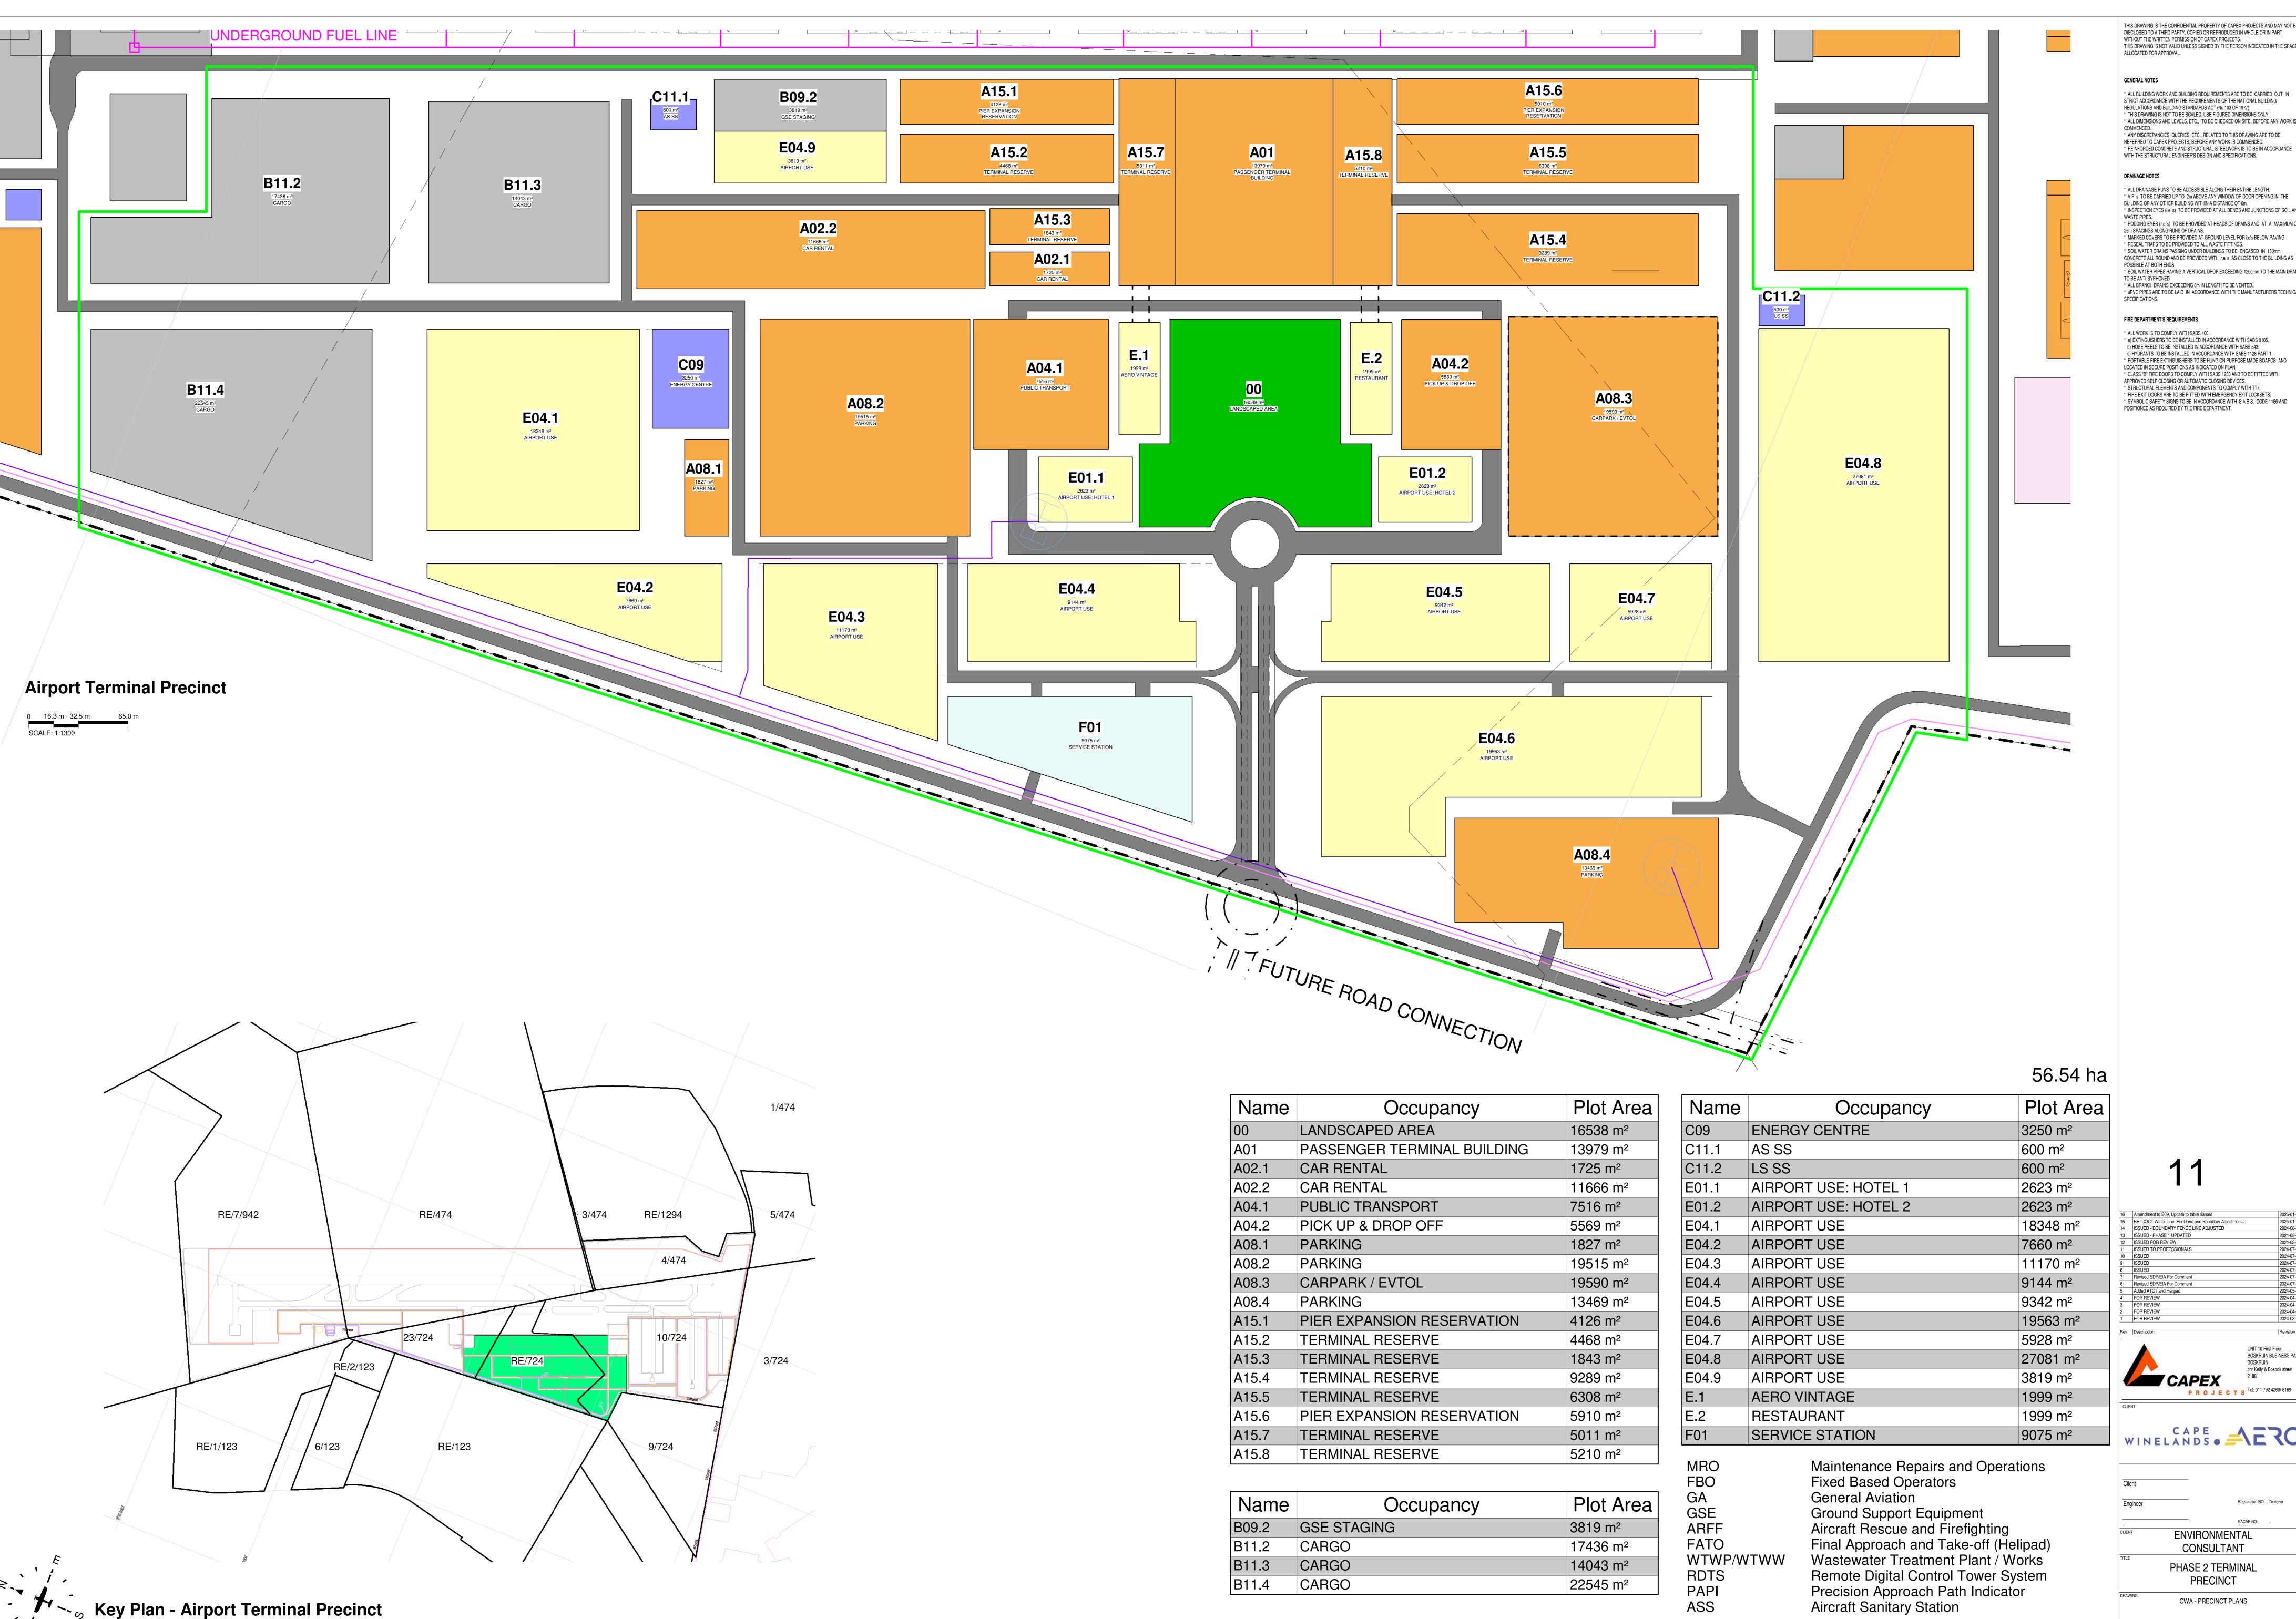

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* ALL DRAINAGE RUNS TO BE ACCESSIBLE ALONG THEIR ENTIRE LENGTH. * V.P.'s TO BE CARRIED UP TO 2m ABOVE ANY WINDOW OR DOOR OPENING IN THE BUILDING OR ANY OTHER BUILDING WITHIN A DISTANCE OF 6m. * INSPECTION EYES (i.e.'s) TO BE PROVIDED AT ALL BENDS AND JUNCTIONS OF SOIL AND * RODDING EYES (r.e.'s) TO BE PROVIDED AT HEADS OF DRAINS AND AT A MAXIMUM OF 25m SPACINGS ALONG RUNS OF DRAINS. MARKED COVERS TO BE PROVIDED AT GROUND LEVEL FOR i.e's BELOW PAVING * RESEAL TRAPS TO BE PROVIDED TO ALL WASTE FITTINGS. * SOIL WATER DRAINS PASSING UNDER BUILDINGS TO BE ENCASED IN 150mm CONCRETE ALL ROUND AND BE PROVIDED WITH r.e.'s AS CLOSE TO THE BUILDING AS * SOIL WATER PIPES HAVING A VERTICAL DROP EXCEEDING 1200mm TO THE MAIN DRAIN * ALL BRANCH DRAINS EXCEEDING 6m IN LENGTH TO BE VENTED. * uPVC PIPES ARE TO BE LAID IN ACCORDANCE WITH THE MANUFACTURERS TECHNICAL

ALL WORK IS TO COMPLY WITH SABS 400.

* a) EXTINGUISHERS TO BE INSTALLED IN ACCORDANCE WITH SABS 0105. b) HOSE REELS TO BE INSTALLED IN ACCORDANCE WITH SABS 543. c) HYDRANTS TO BE INSTALLED IN ACCORDANCE WITH SABS 1128 PART 1. PORTABLE FIRE EXTINGUISHERS TO BE HUNG ON PURPOSE MADE BOARDS AND LOCATED IN SECURE POSITIONS AS INDICATED ON PLAN. * CLASS "B" FIRE DOORS TO COMPLY WITH SABS 1253 AND TO BE FITTED WITH APPROVED SELF CLOSING OR AUTOMATIC CLOSING DEVICES. * STRUCTURAL ELEMENTS AND COMPONENTS TO COMPLY WITH TT7. FIRE EXIT DOORS ARE TO BE FITTED WITH EMERGENCY EXIT LOCKSETS. * SYMBOLIC SAFETY SIGNS TO BE IN ACCORDANCE WITH S.A.B.S. CODE 1186 AND POSITIONED AS REQUIRED BY THE FIRE DEPARTMENT.

11

BH, COCT Water Line, Fuel Line and Boundary Adjustments	
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FOR REVIEW	2024-04-03
FOR REVIEW	2024-04-03
FOR REVIEW	2024-03-28
Description	Revision Date



WINELANDS . AERO


SCALE As indicated

ENVIRONMENTAL CONSULTANT PHASE 2 TERMINAL PRECINCT

DATE 2025-01-23

CWA - PRECINCT PLANS

2024-3297 401 16

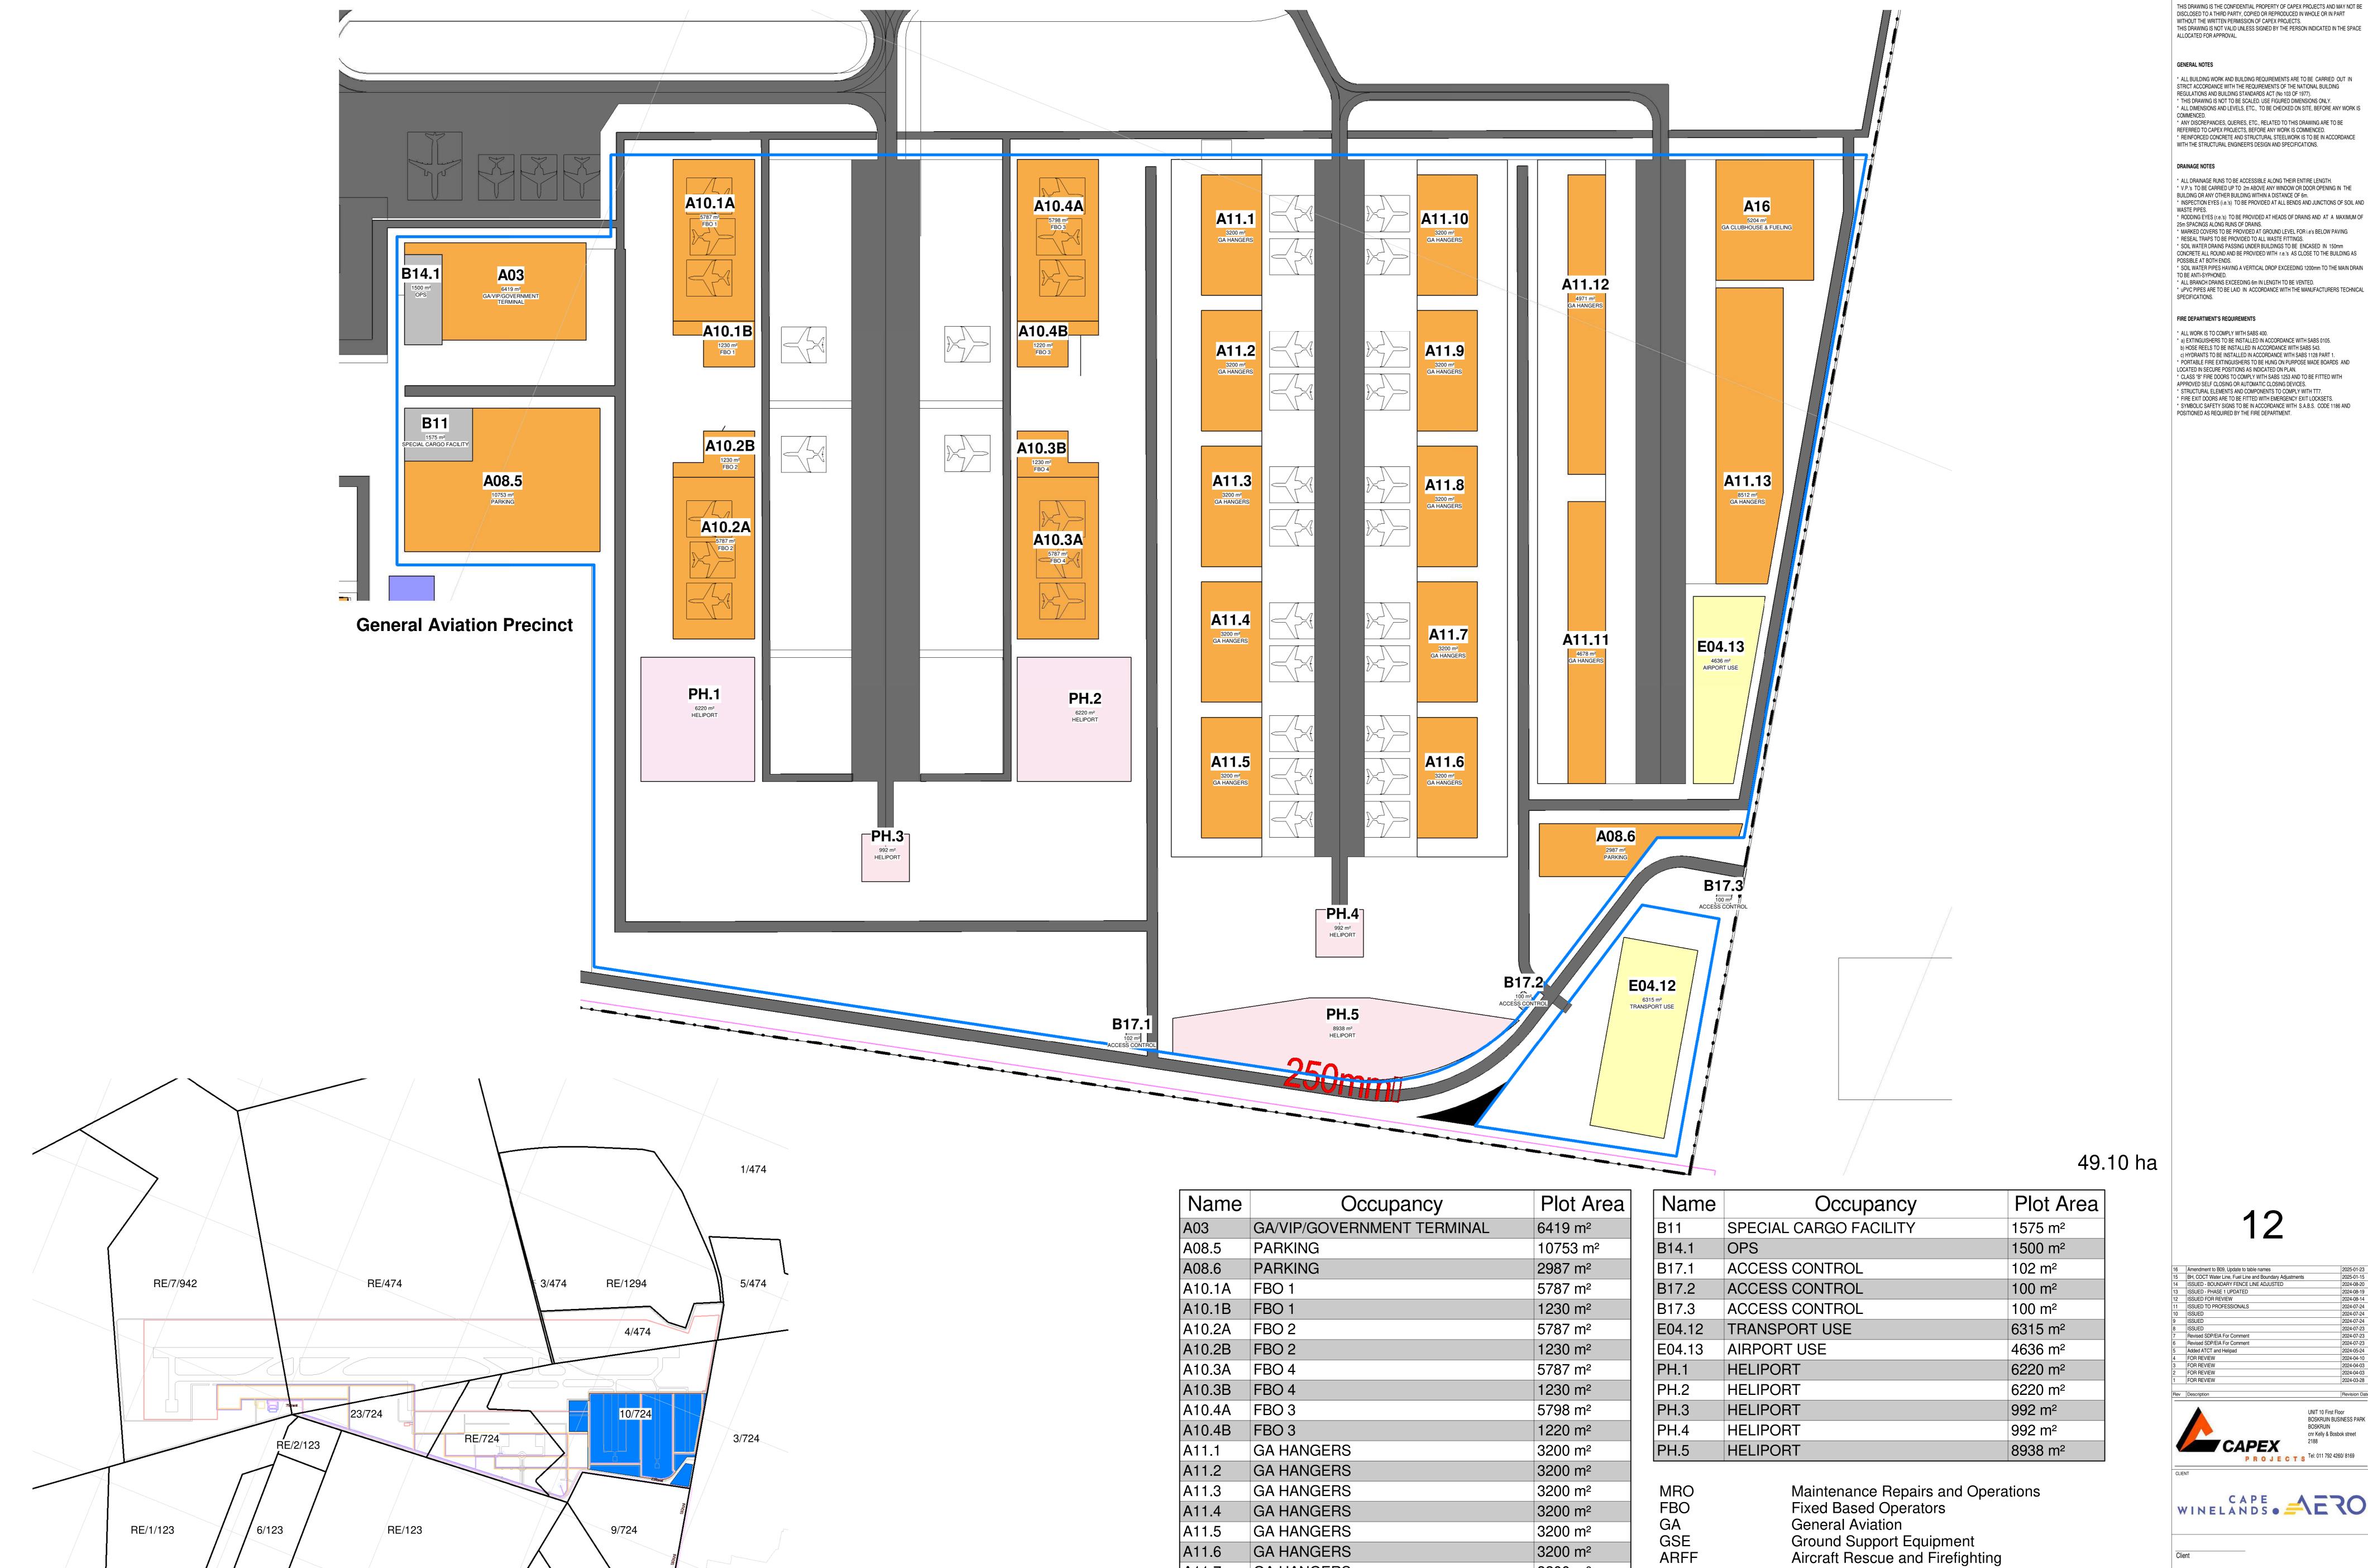

Key Plan - General Aviation Precinct

GA HANGERS

GA HANGERS

GA HANGERS

GA HANGERS

GA HANGERS

GA HANGERS

GA HANGERS

GA CLUBHOUSE & FUELING

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	FOR REVIEW	2024-03-28



ARFF

FATO

RDTS

PAPI

WTWP/WTWW

3200 m²

3200 m²

3200 m²

3200 m²

4678 m²

4971 m²

8512 m²

5204 m²

Final Approach and Take-off (Helipad)
Wastewater Treatment Plant / Works

Remote Digital Control Tower System

Precision Approach Path Indicator

UNIT 10 First Floor BOSKRUIN BUSINESS PARK BOSKRUIN cnr Kelly & Bosbok street

WINELANDS . AERO ENVIRONMENTAL CONSULTANT PHASE 2 GENERAL **AVIATION PRECINCT** CWA - PRECINCT PLANS


DATE 2025-01-23

SCALE As indicated


2024-3297 403 16





Pink line adjacent to Mellish Road leading from Lichtenburg Road towards the main entrance of the Airport Precinct indicating placement of 12 to 15 proposed billboards (Sept 2024)

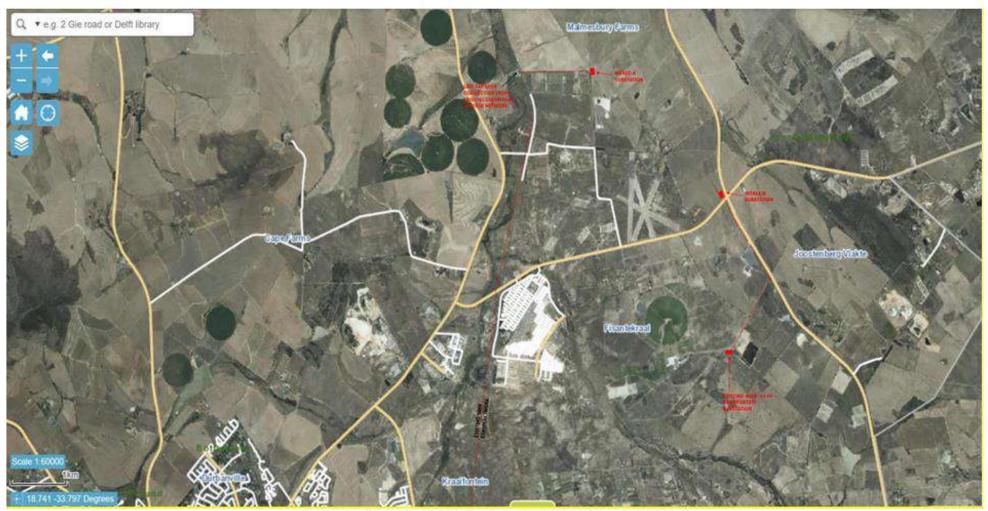

Eskom Bulk High Voltage Feeder Routing

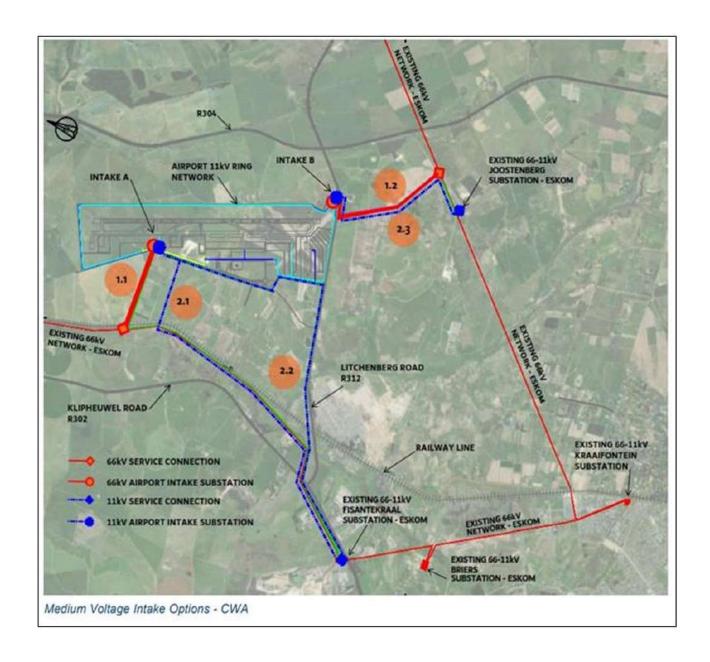

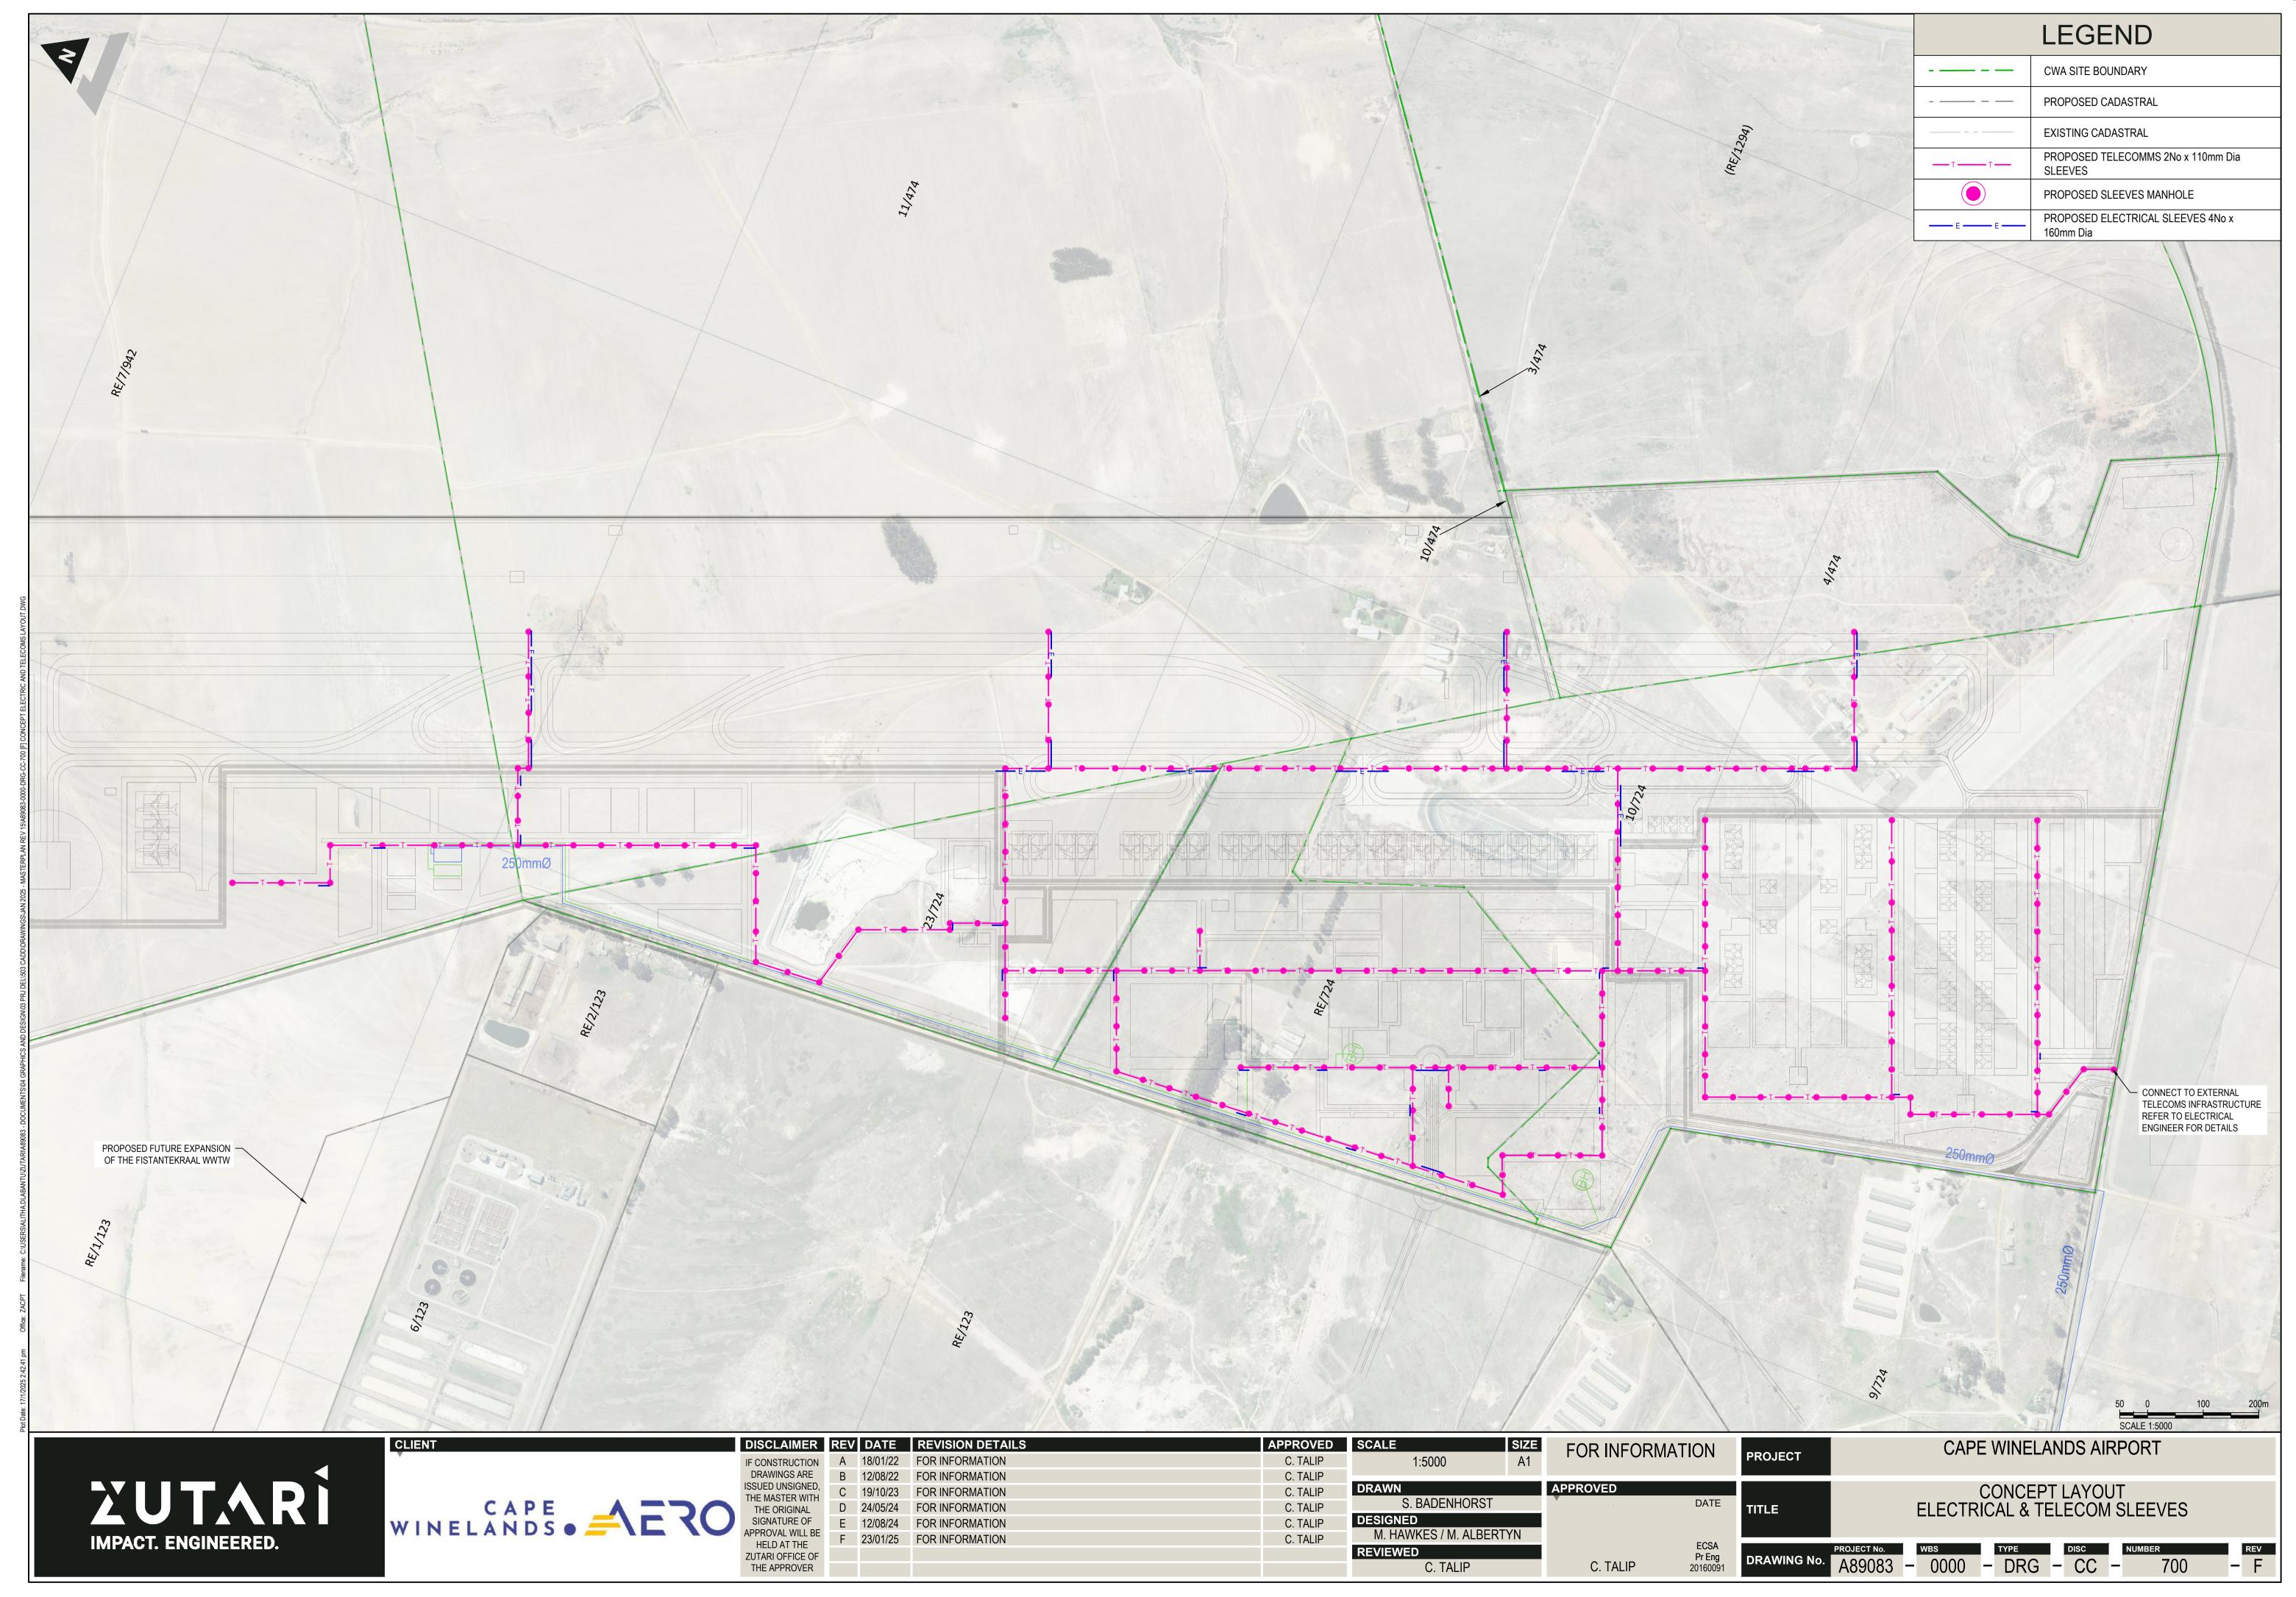

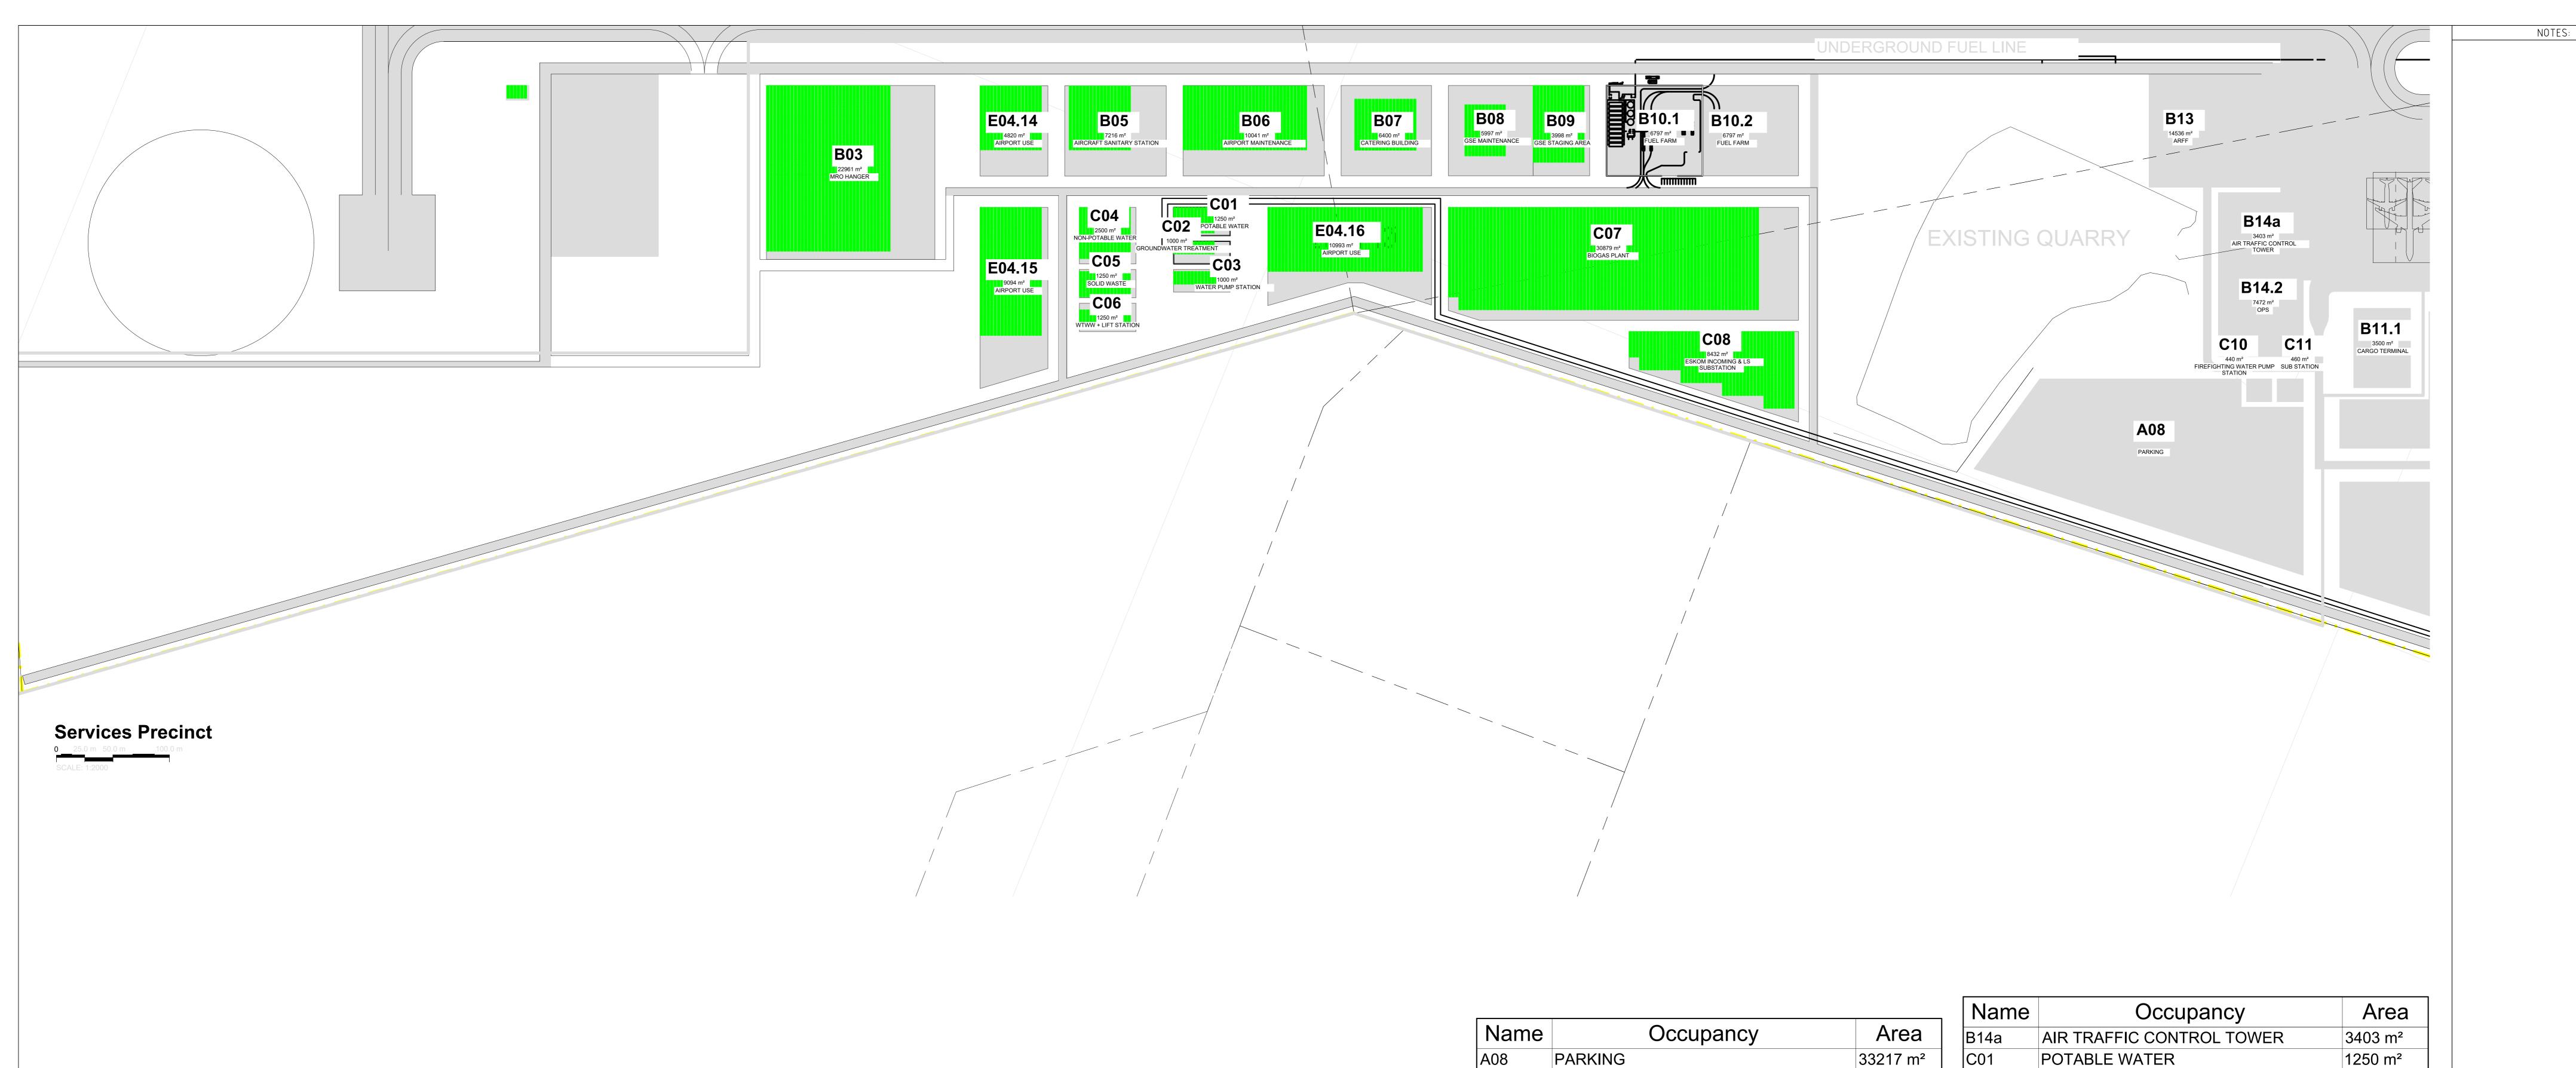

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B05	AIRCRAFT SANITARY STATION	7216 m²
B06	AIRPORT MAINTENANCE	10041 m ²
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B14.2	OPS	7472 m ²

Name	Occupancy	Area
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MRO FBO GA GSE ARFF FATO WTWP/WTWW RDTS PAPI

Maintenance Repairs and Operations Fixed Based Operators General Aviation Ground Support Equipment
Aircraft Rescue and Firefighting
Final Approach and Take-off (Helipad)
Wastewater Treatment Plant / Works Remote Digital Control Tower System Precision Approach Path Indicator

16A





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3 REMOVED PANELS FOR GLARE 02 FOR INFORMATION 01 FOR INFORMATION DESCRIPTION

14 Cyclonite Street, The Interchange, Somerset West, 7130 P.O. Box 226 REPUBLIC OF SOUTH AFRICA Tel: +27 21 852 5095 Fax: +27 21 852 5070 Email: info@selkirkandselkirk.co.za


CAPE WINELANDS AERO

PHASE 2 SERVICES PRECINCT


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 DATE
 DRG NUMBER
 REV
 SCALE
 SIZE


 CFS
 04/03/2025
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PV ARRANGMENT

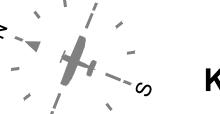

Key Plan - Services Precinct



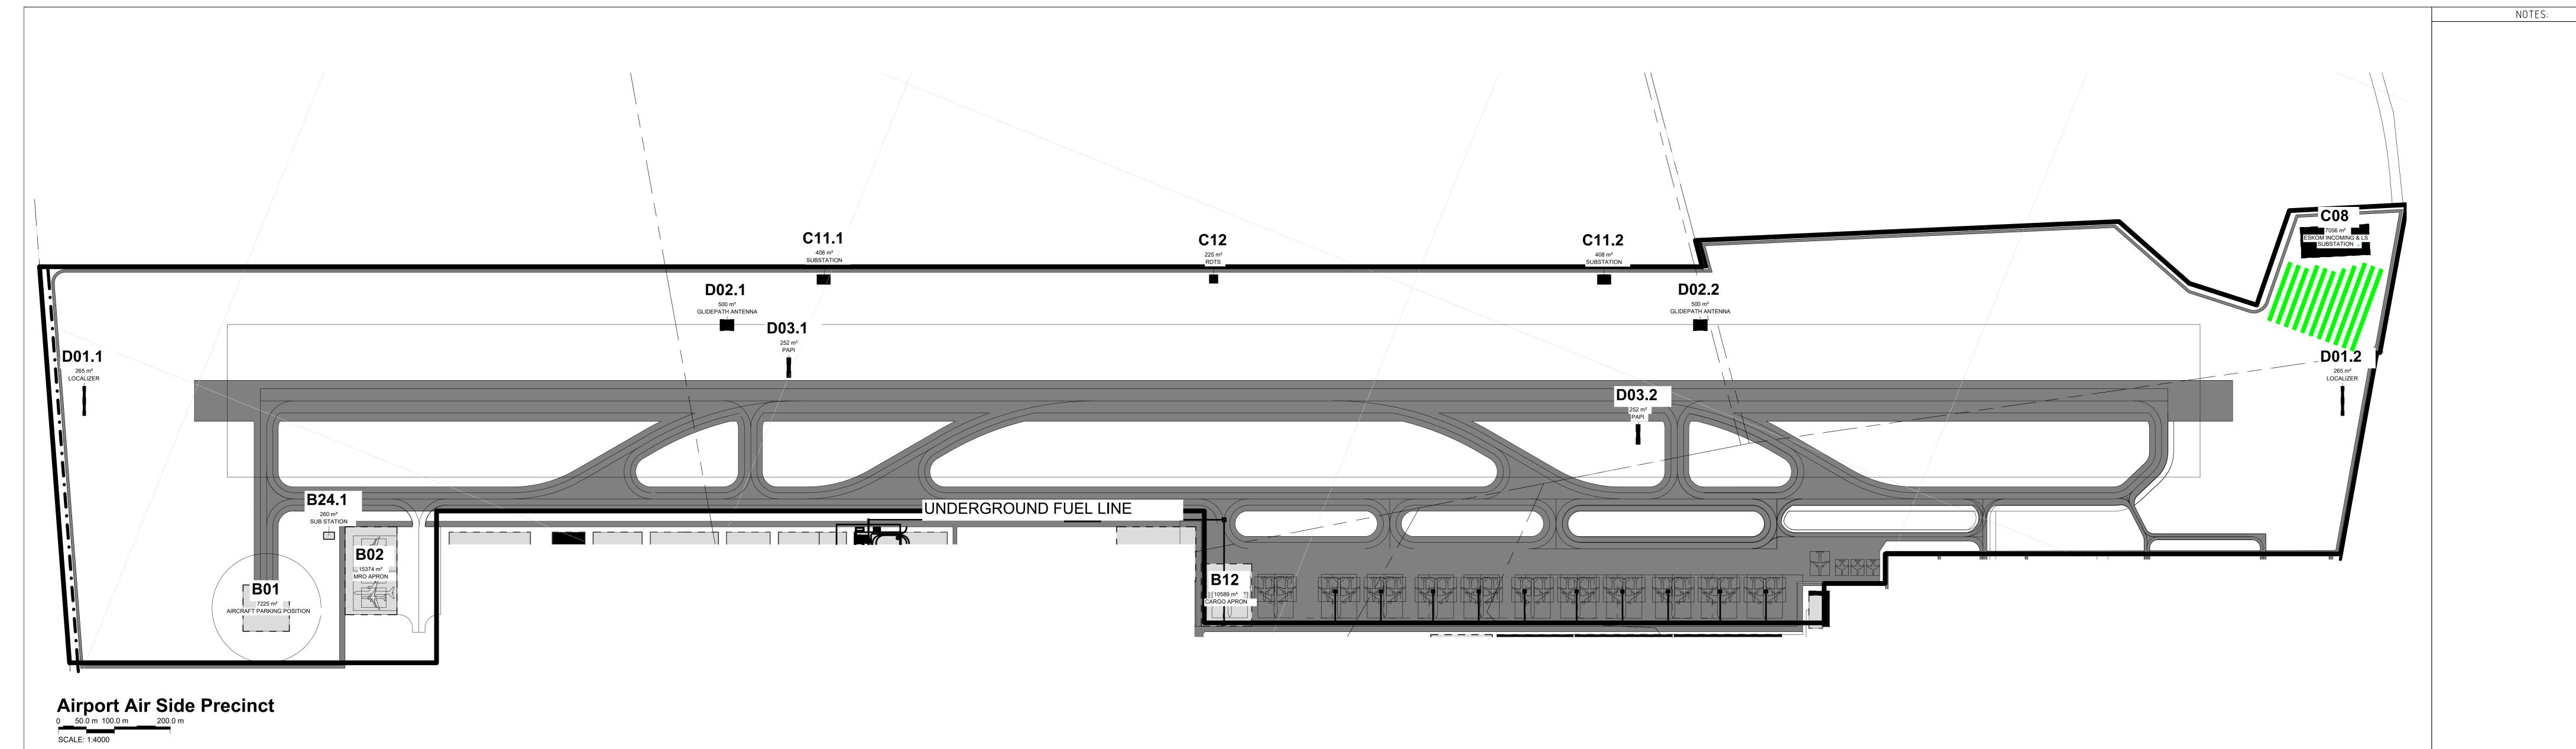


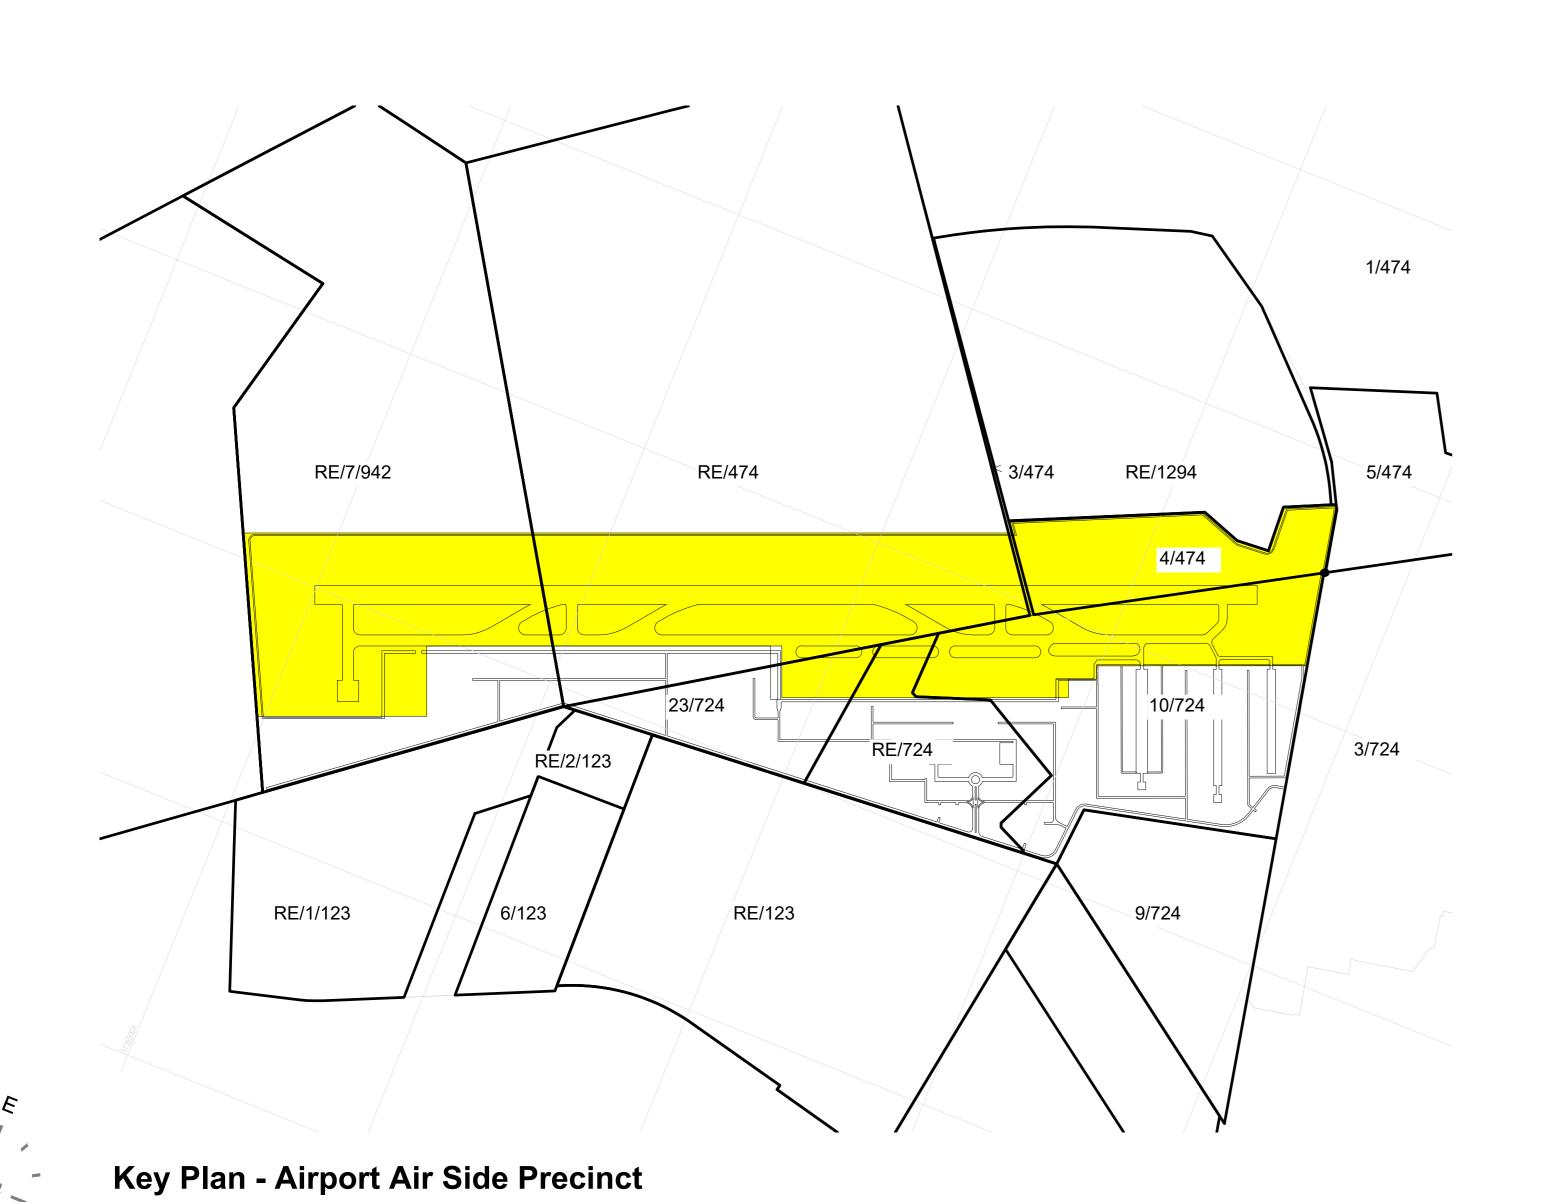Name	Occupancy	Area
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B12	CARGO APRON	10589 m²
B24.1	SUB STATION	260 m ²


MRO BO SA SSE ARFF ATO VTWP/WTWW	Maintenance Repairs and Operations Fixed Based Operators General Aviation Ground Support Equipment Aircraft Rescue and Firefighting Final Approach and Take-off (Helipad) Wastewater Treatment Plant / Works
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Name	Occupancy	Area
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C11.1	SUBSTATION	408 m ²
C11.2	SUBSTATION	408 m ²
C12	RDTS	225 m ²
D01.1	LOCALIZER	265 m ²
D01.2	LOCALIZER	265 m ²
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D02.2	GLIDEPATH ANTENNA	500 m ²
D03.1	PAPI	252 m ²
D03.2	PAPI	252 m²

248.41 ha

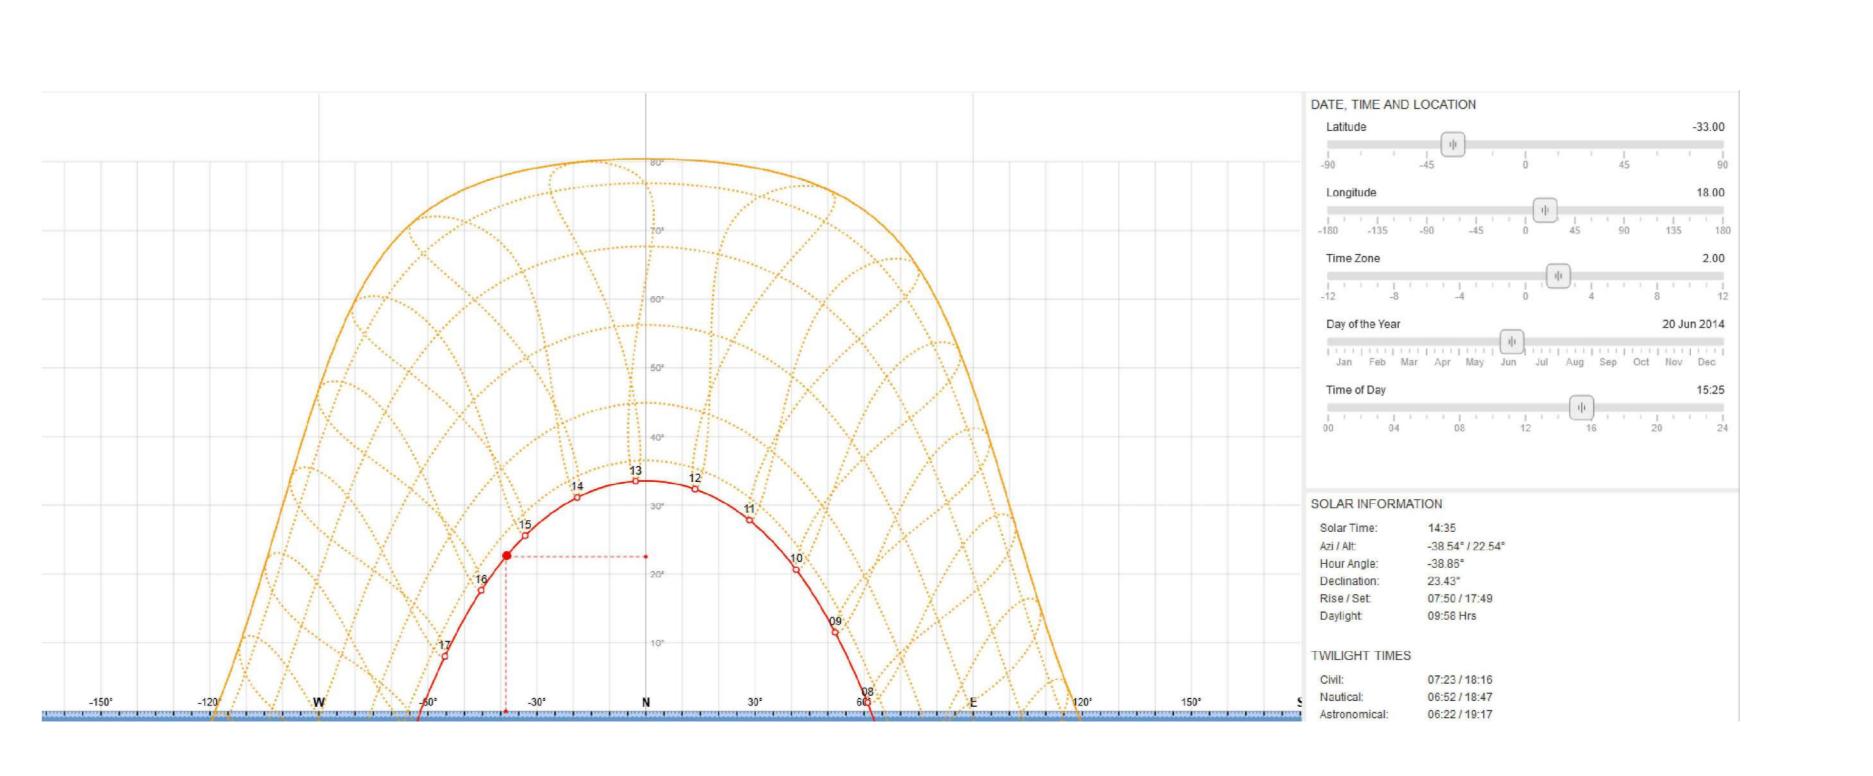



16b




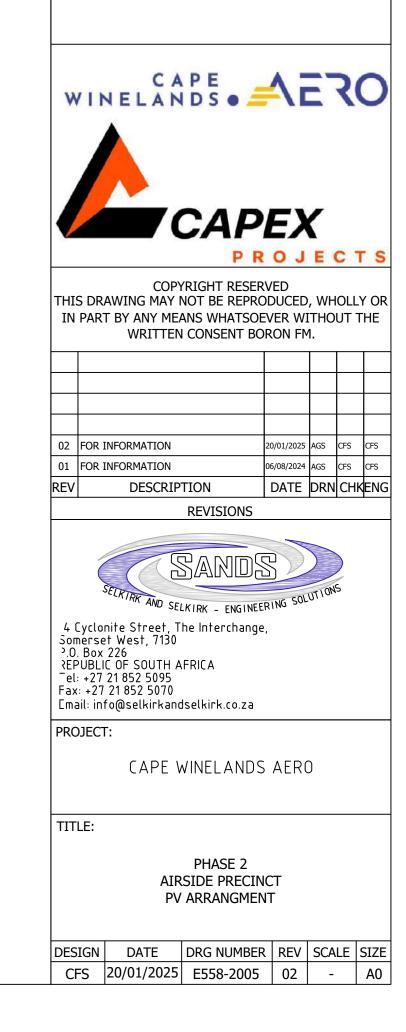





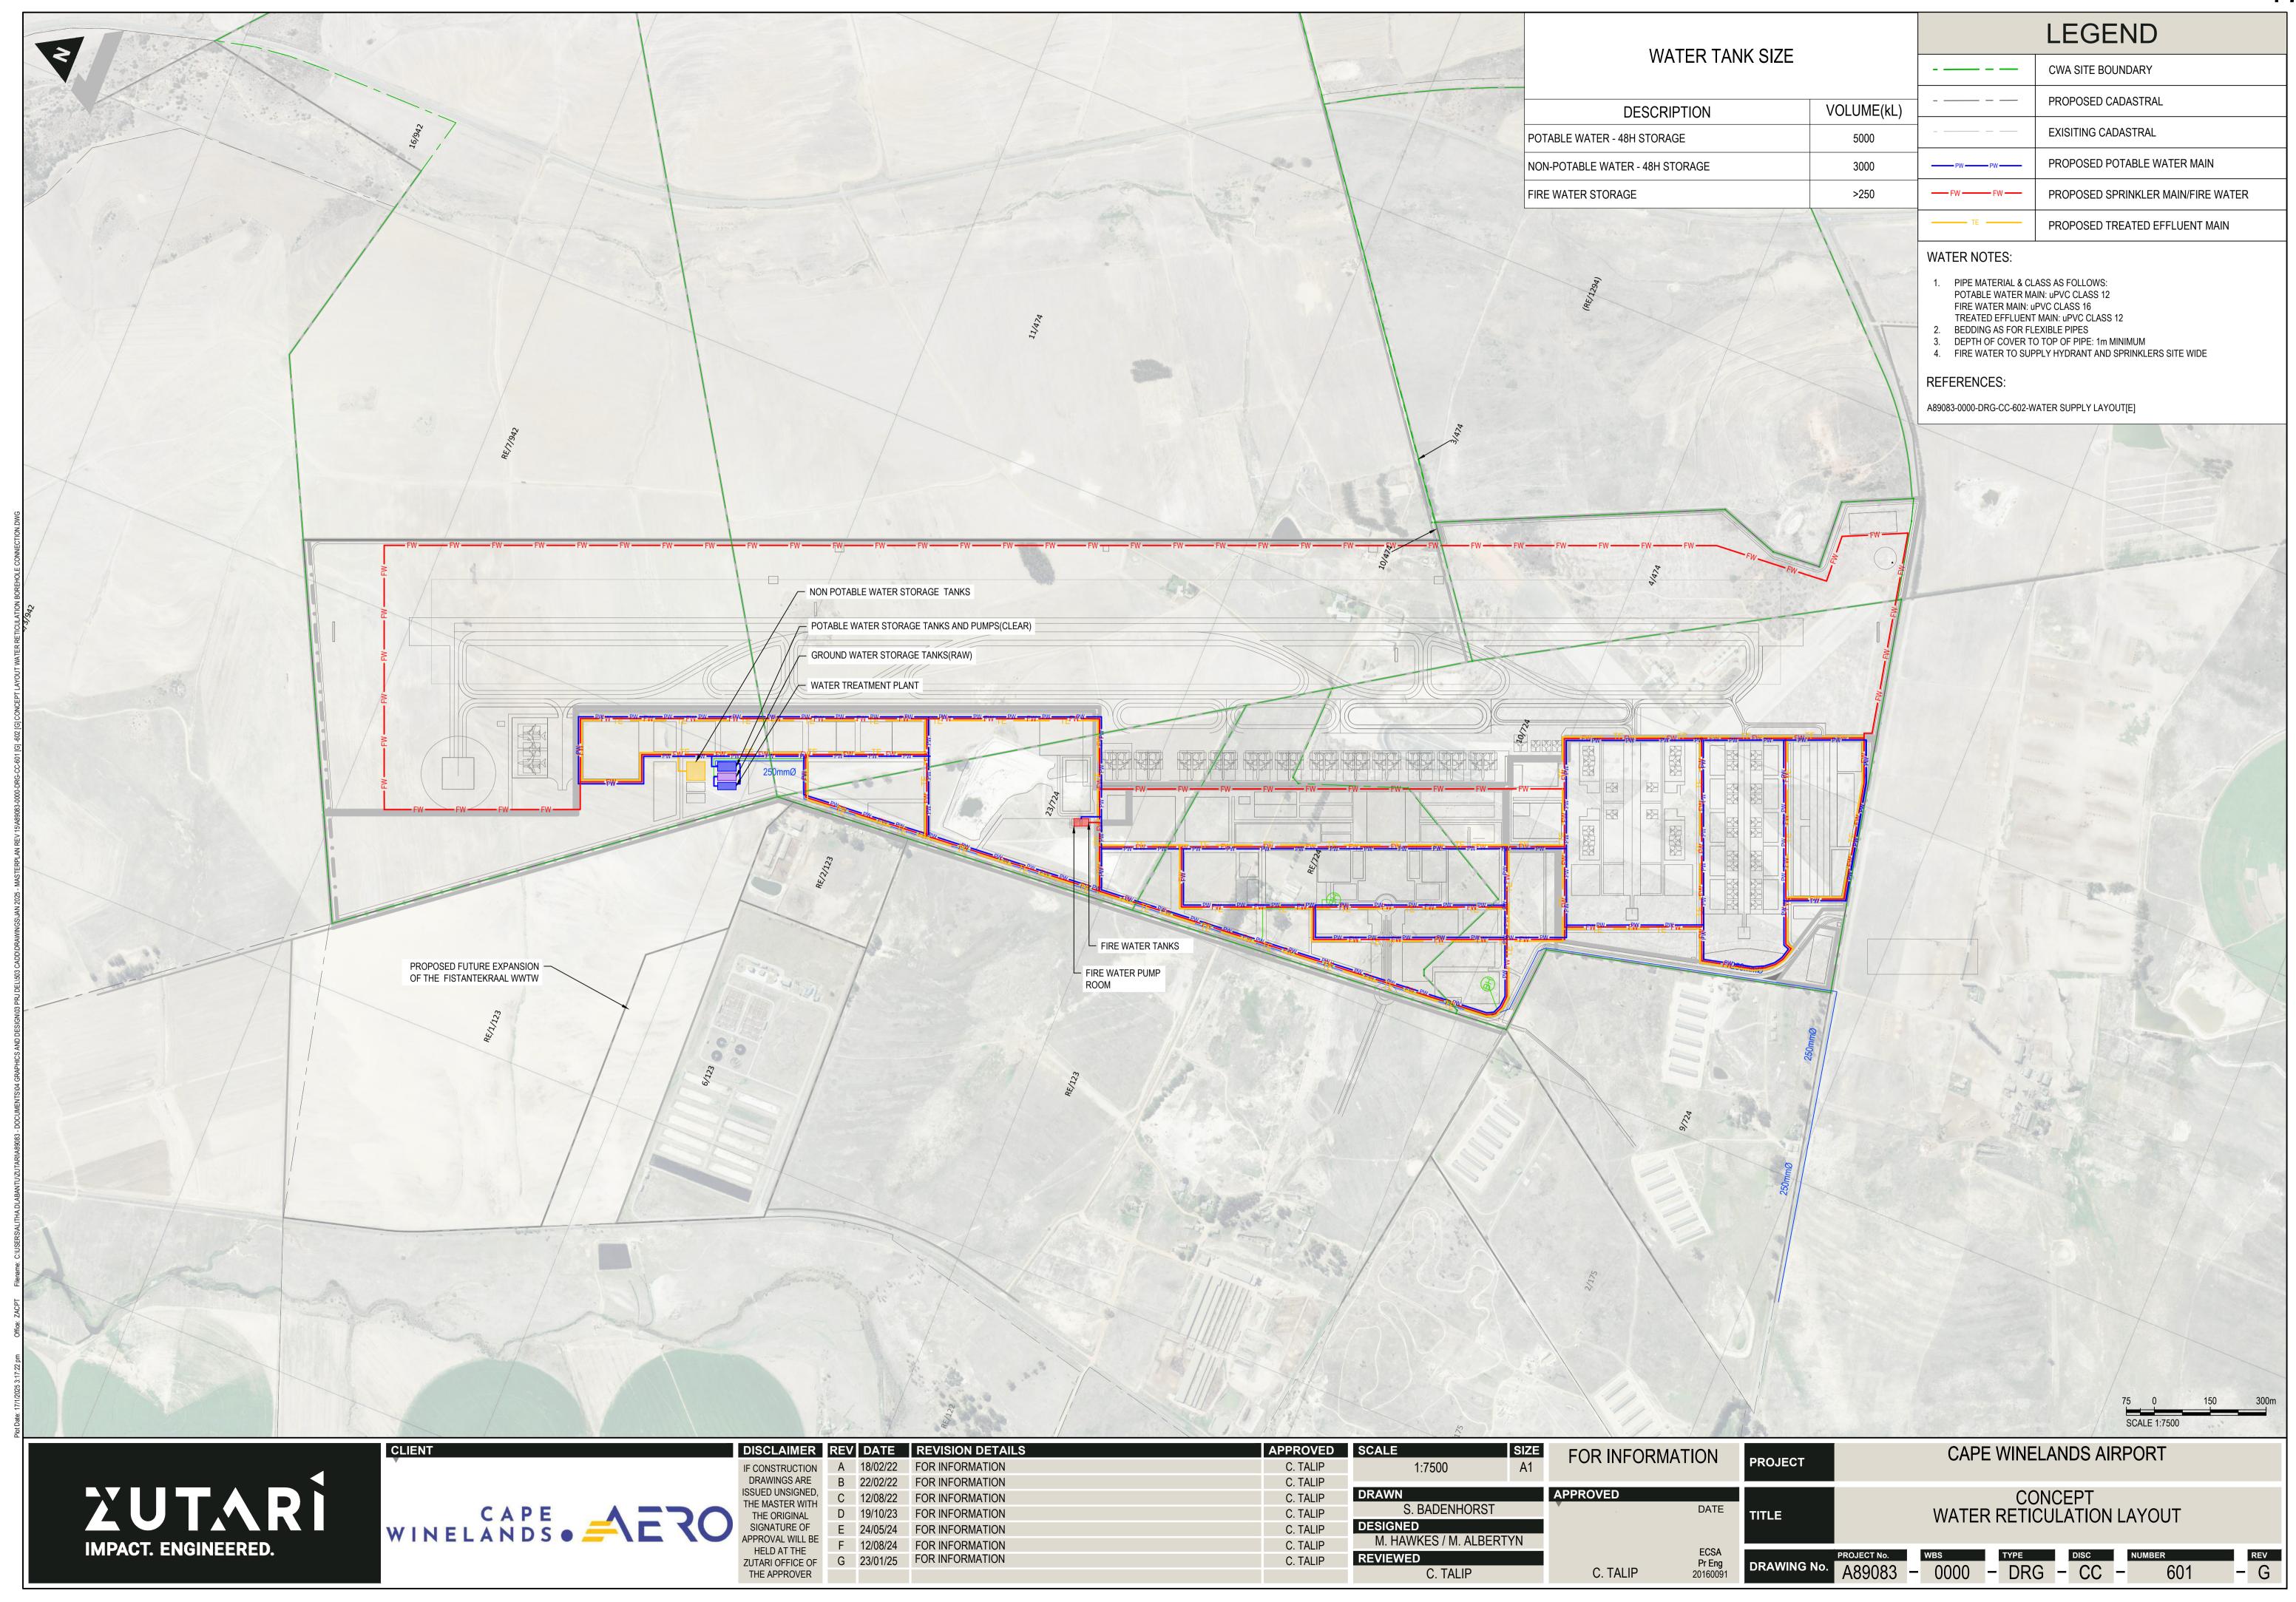


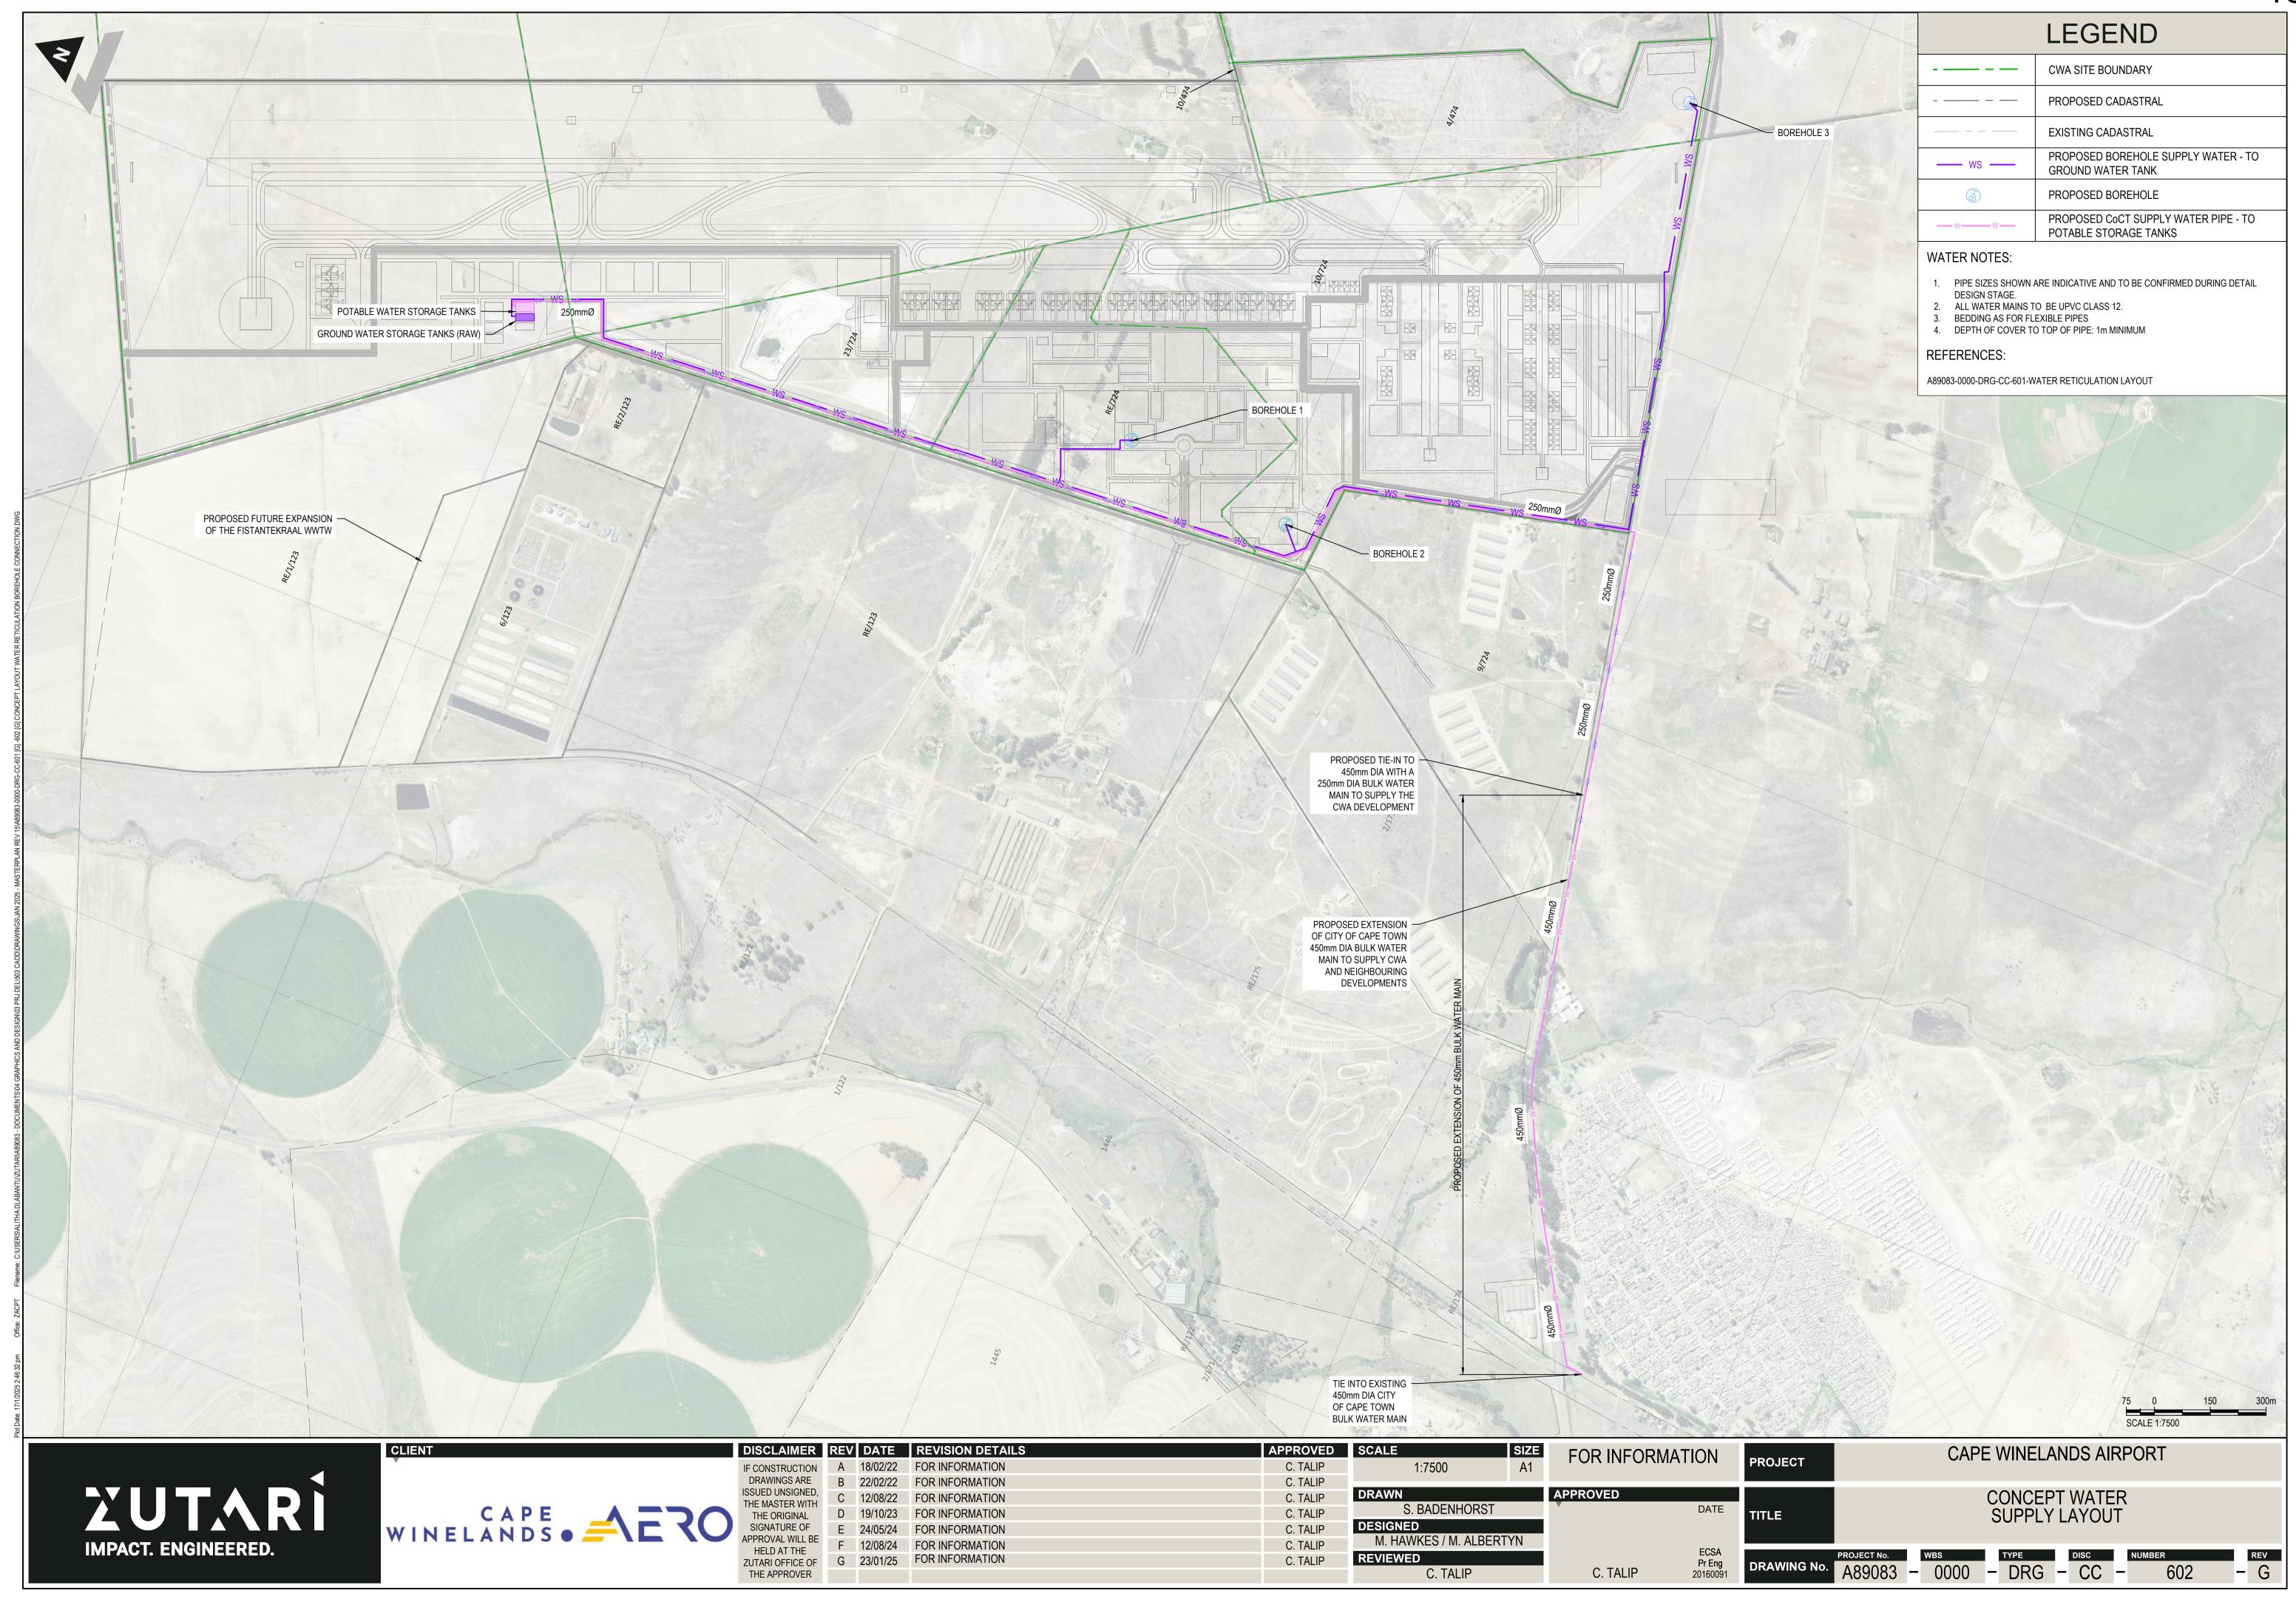


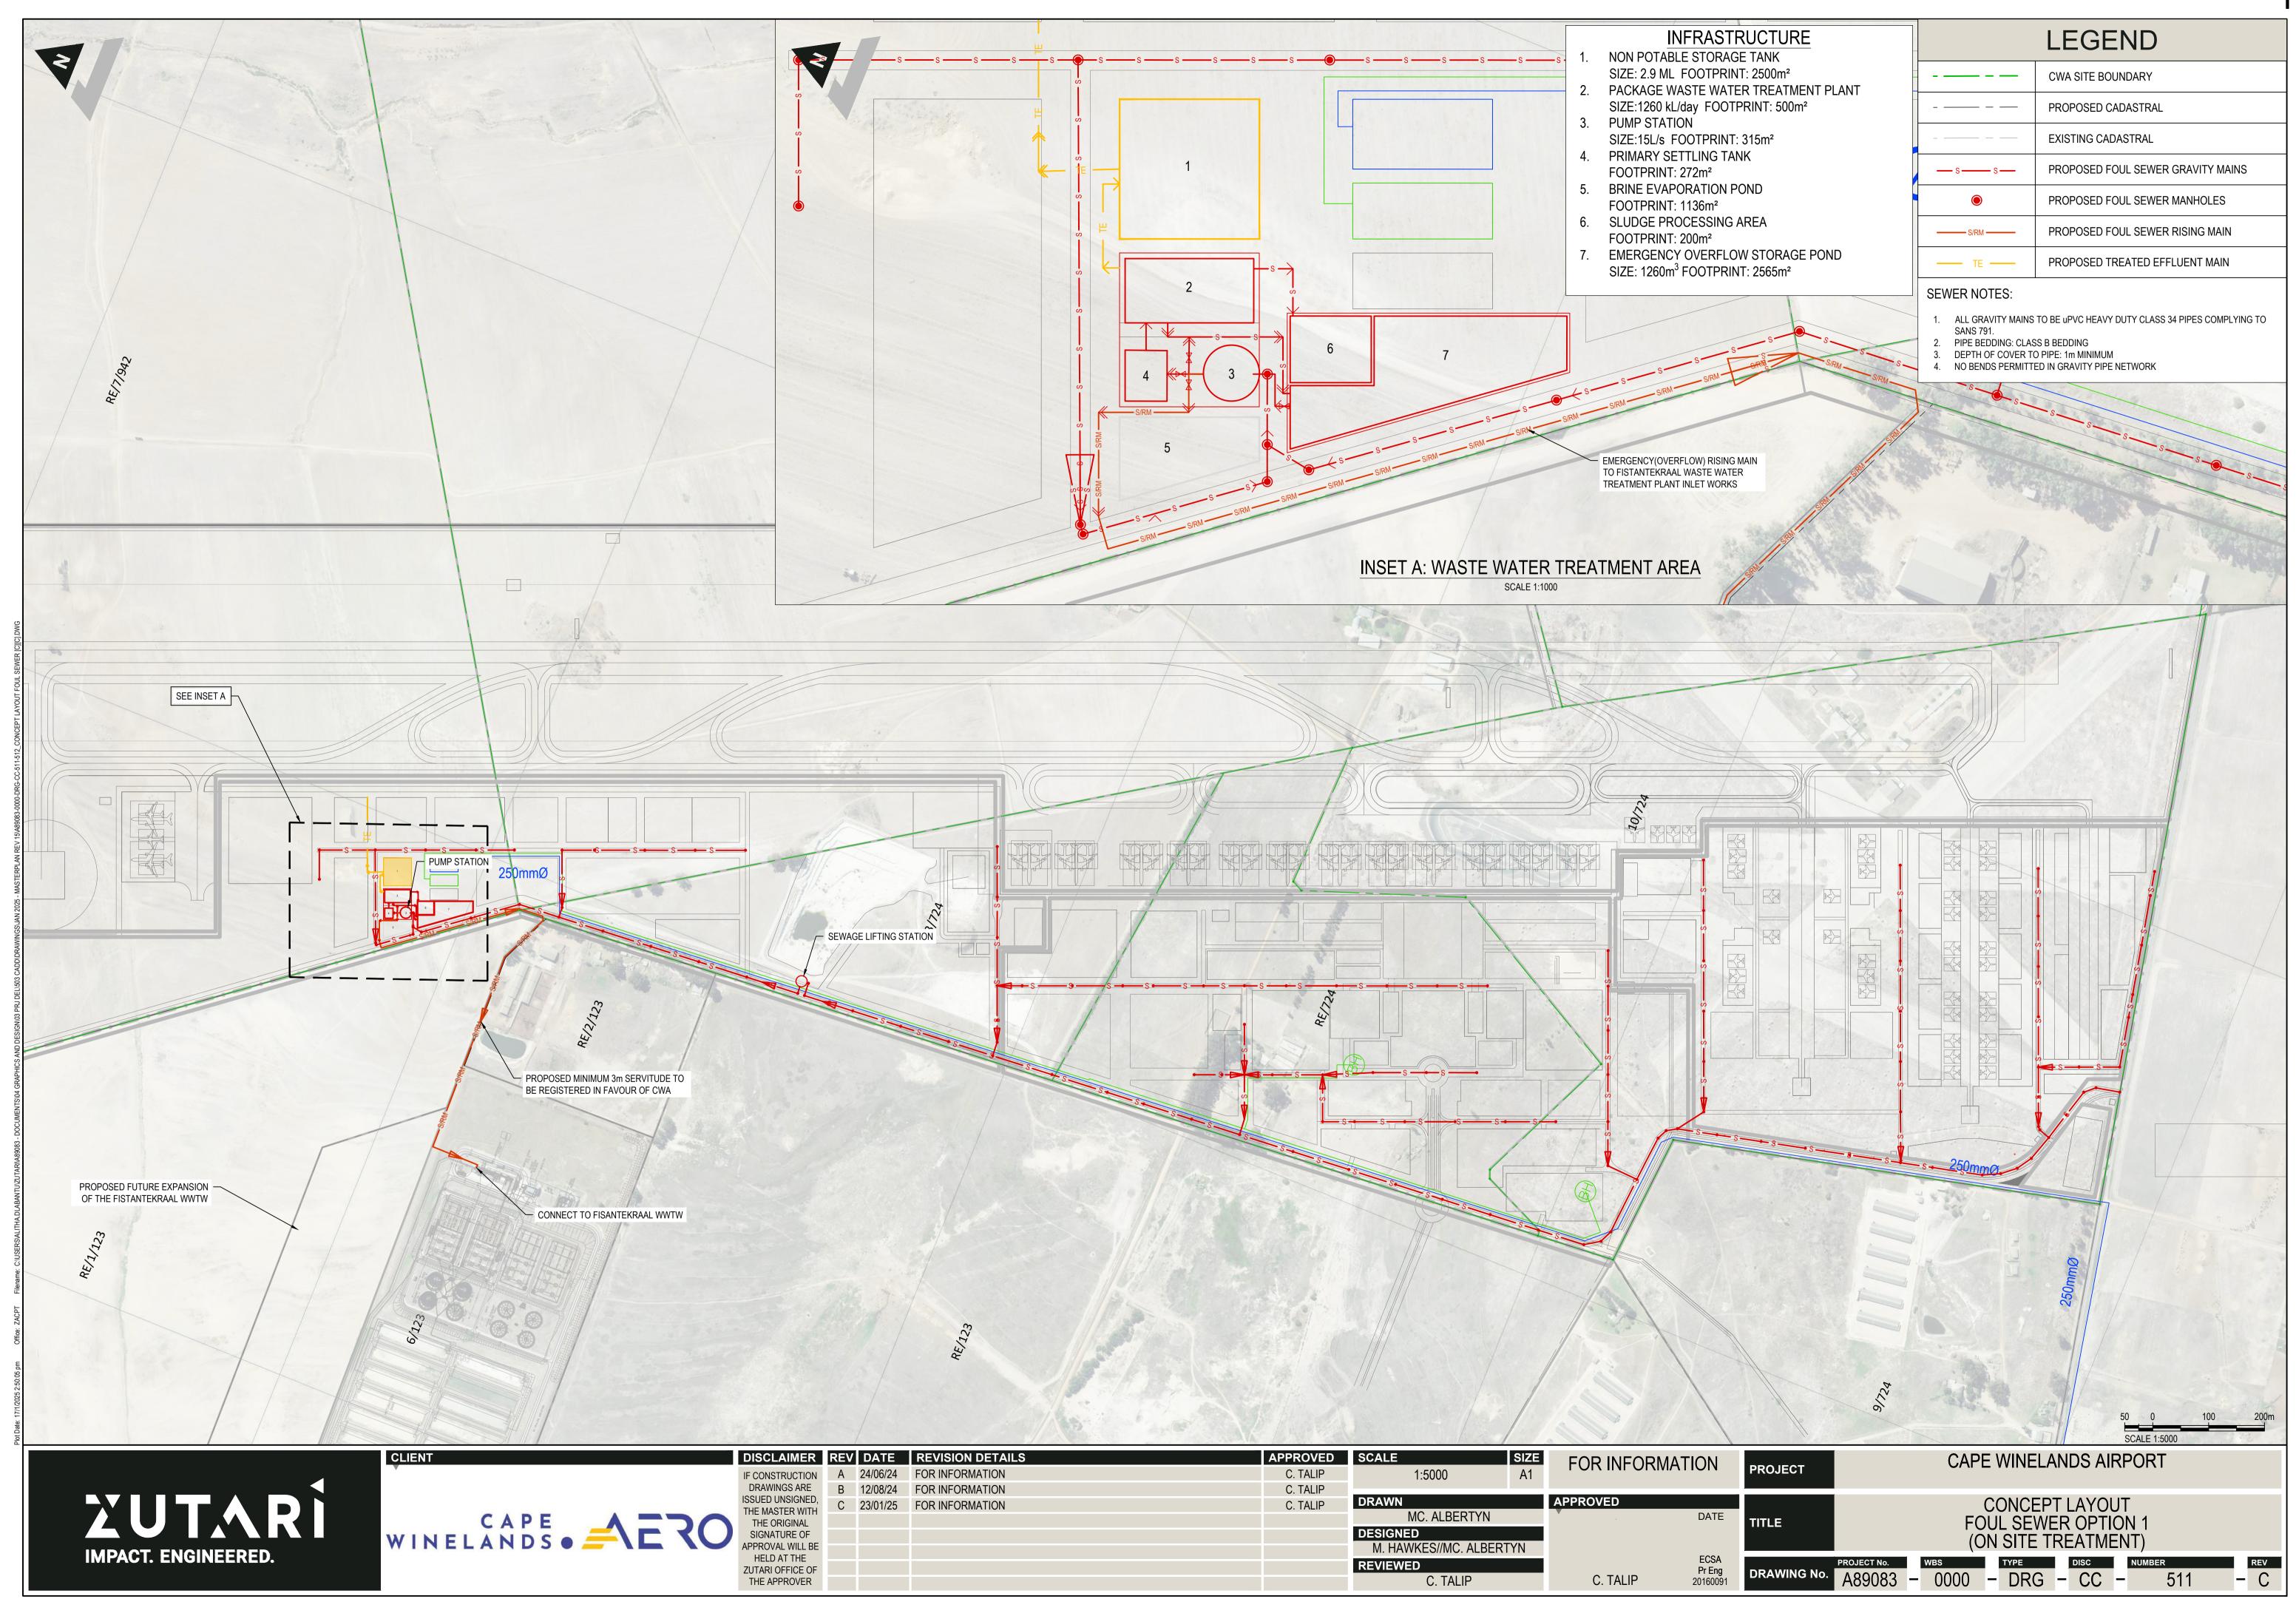


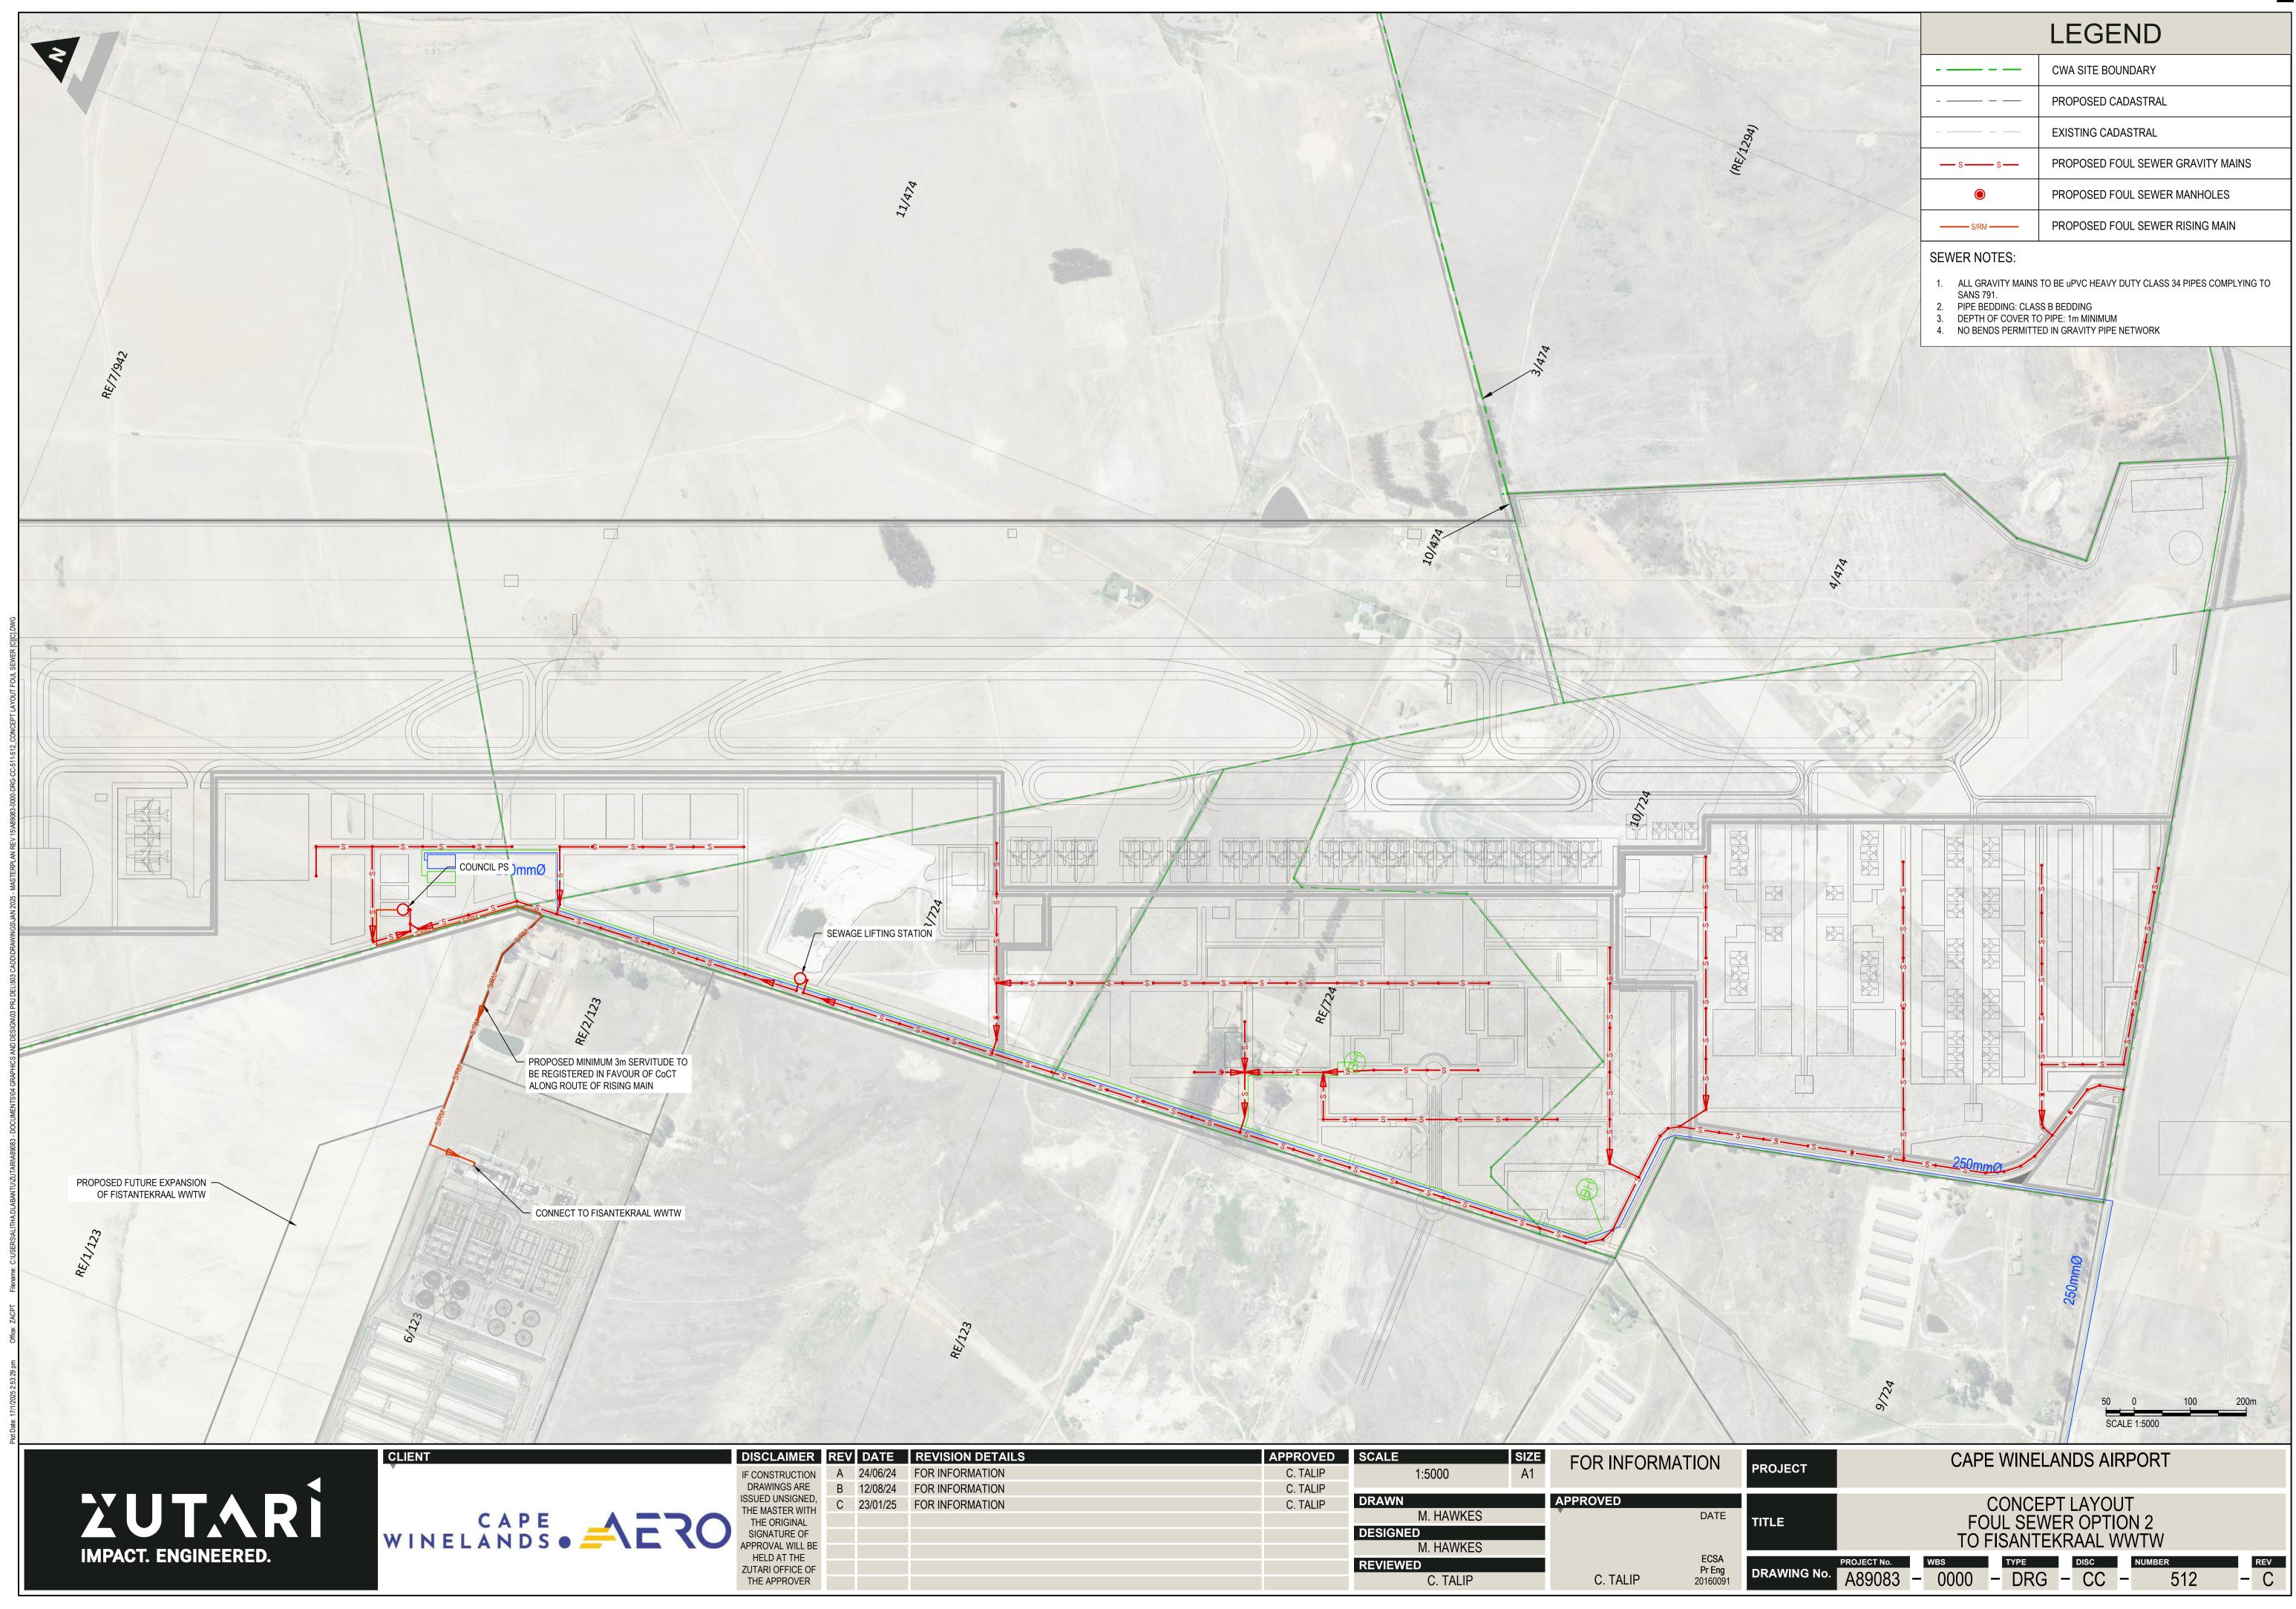


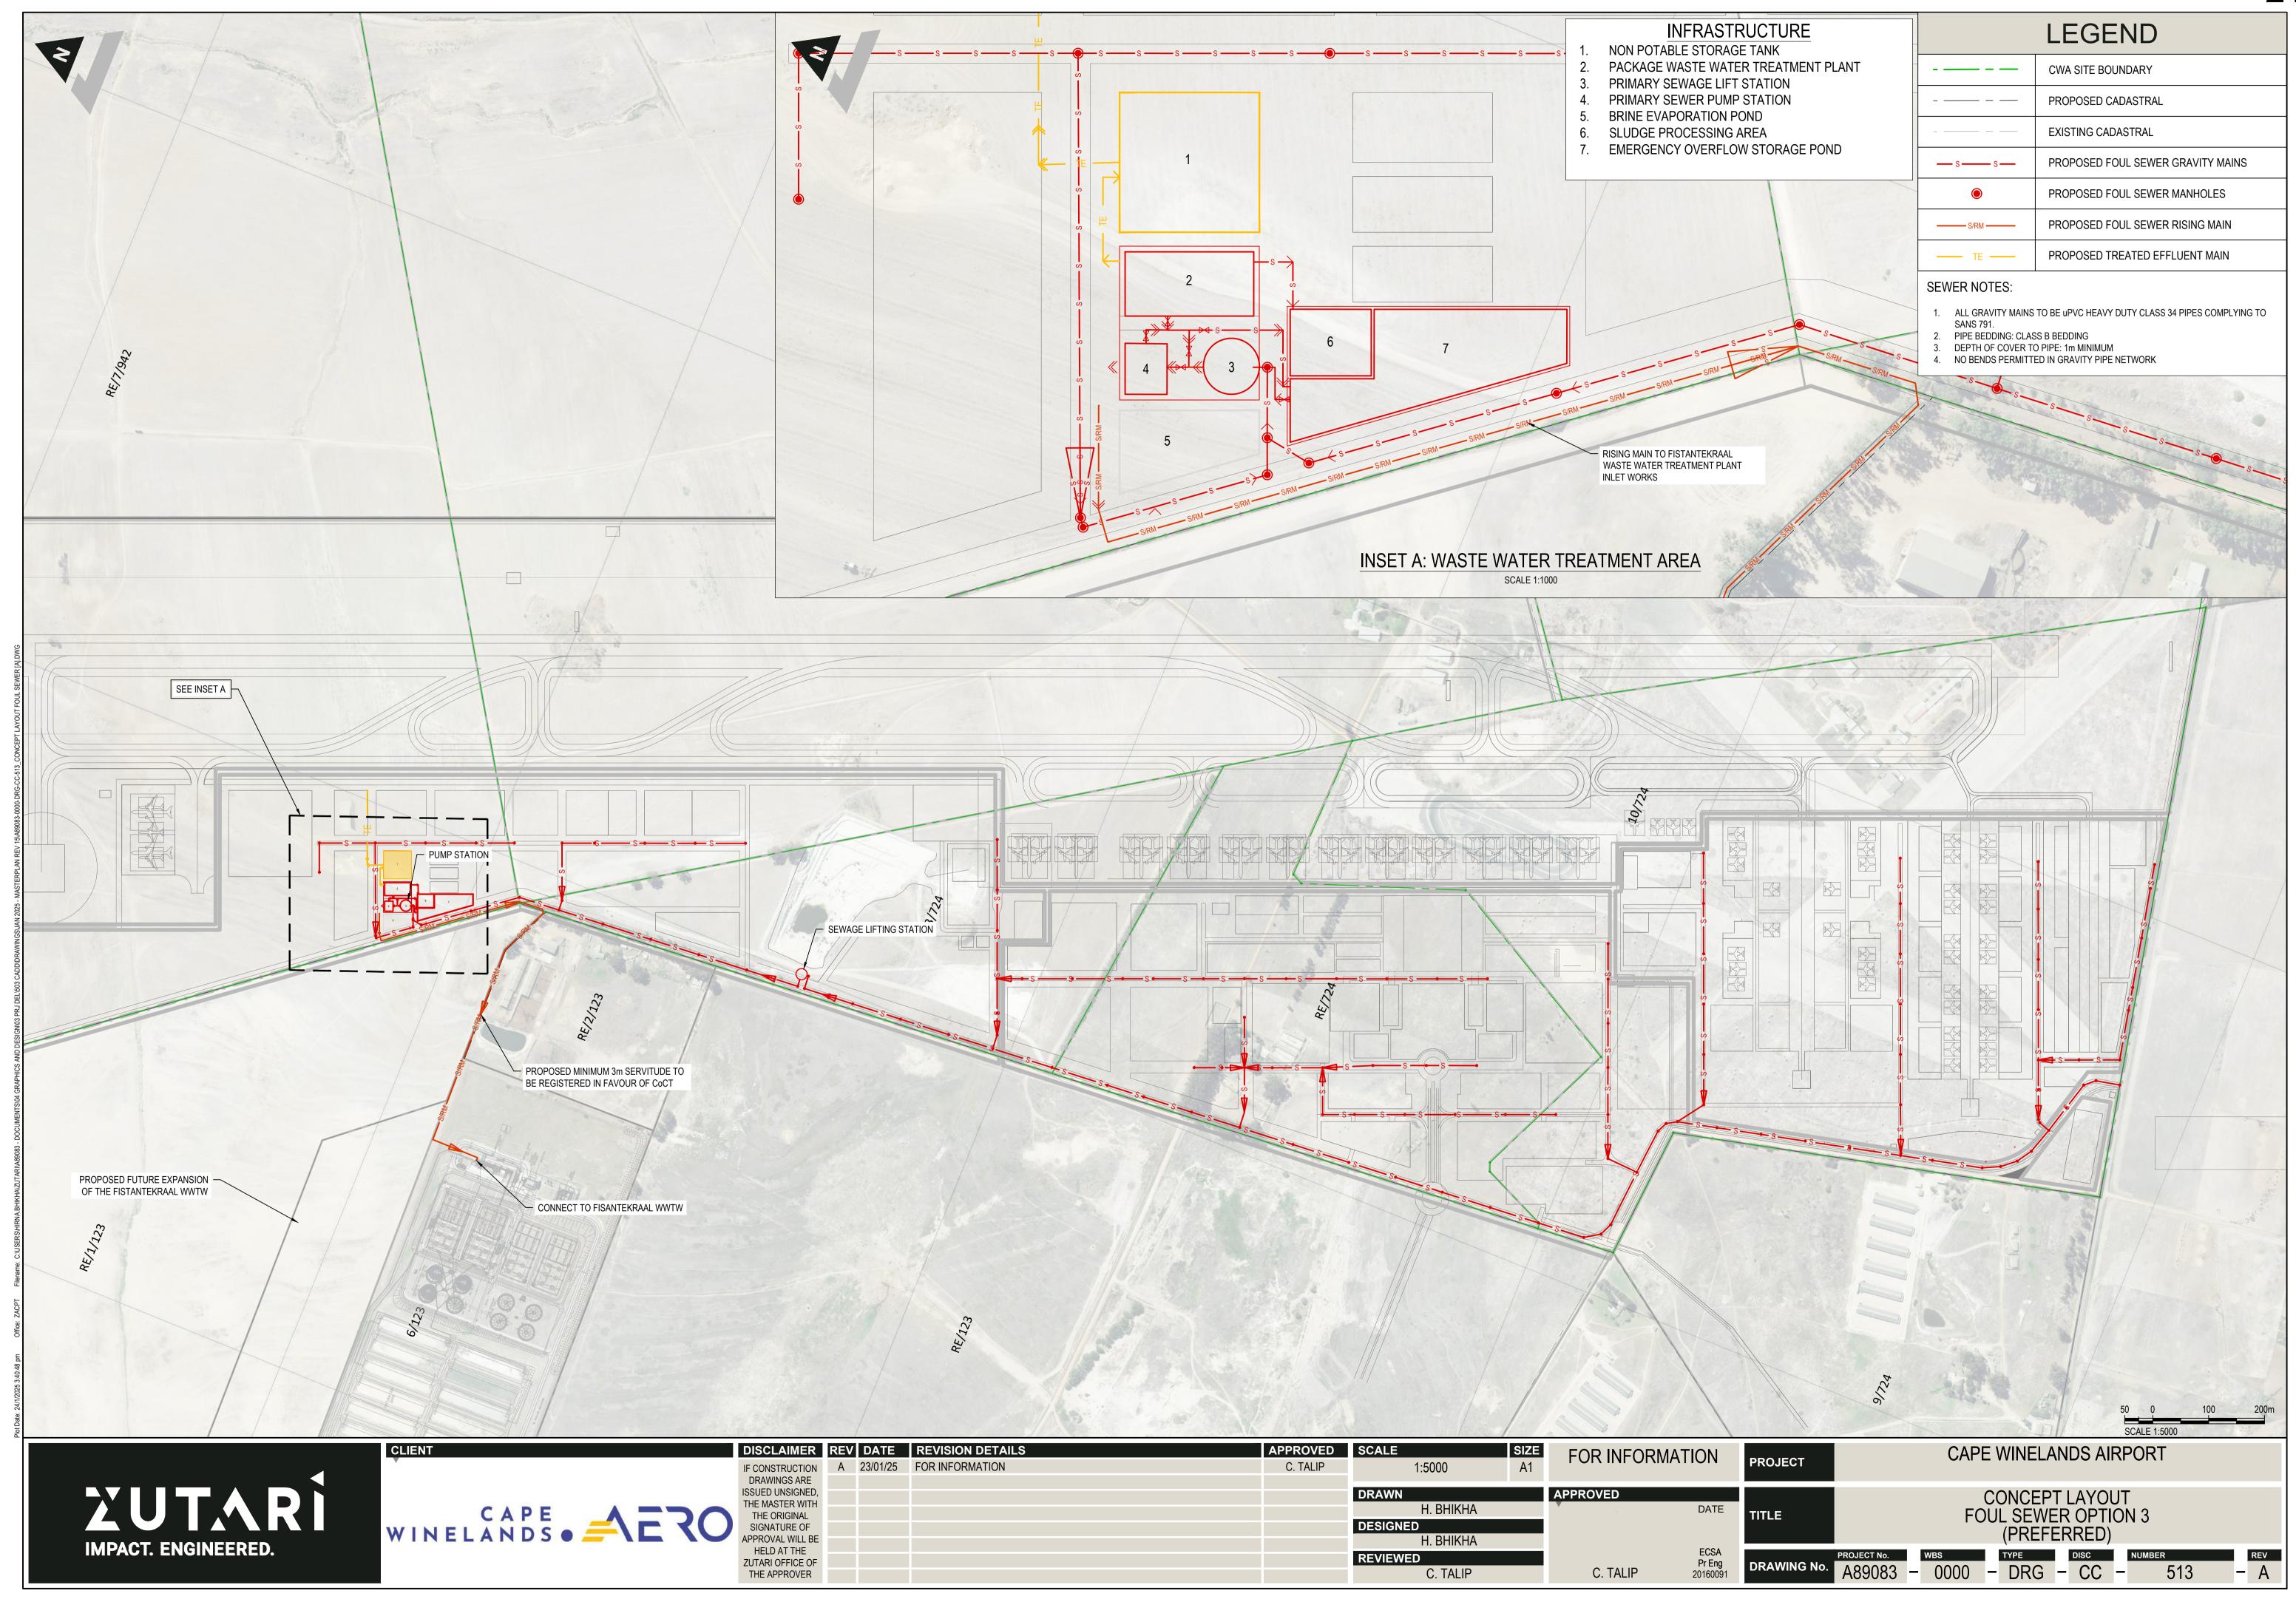


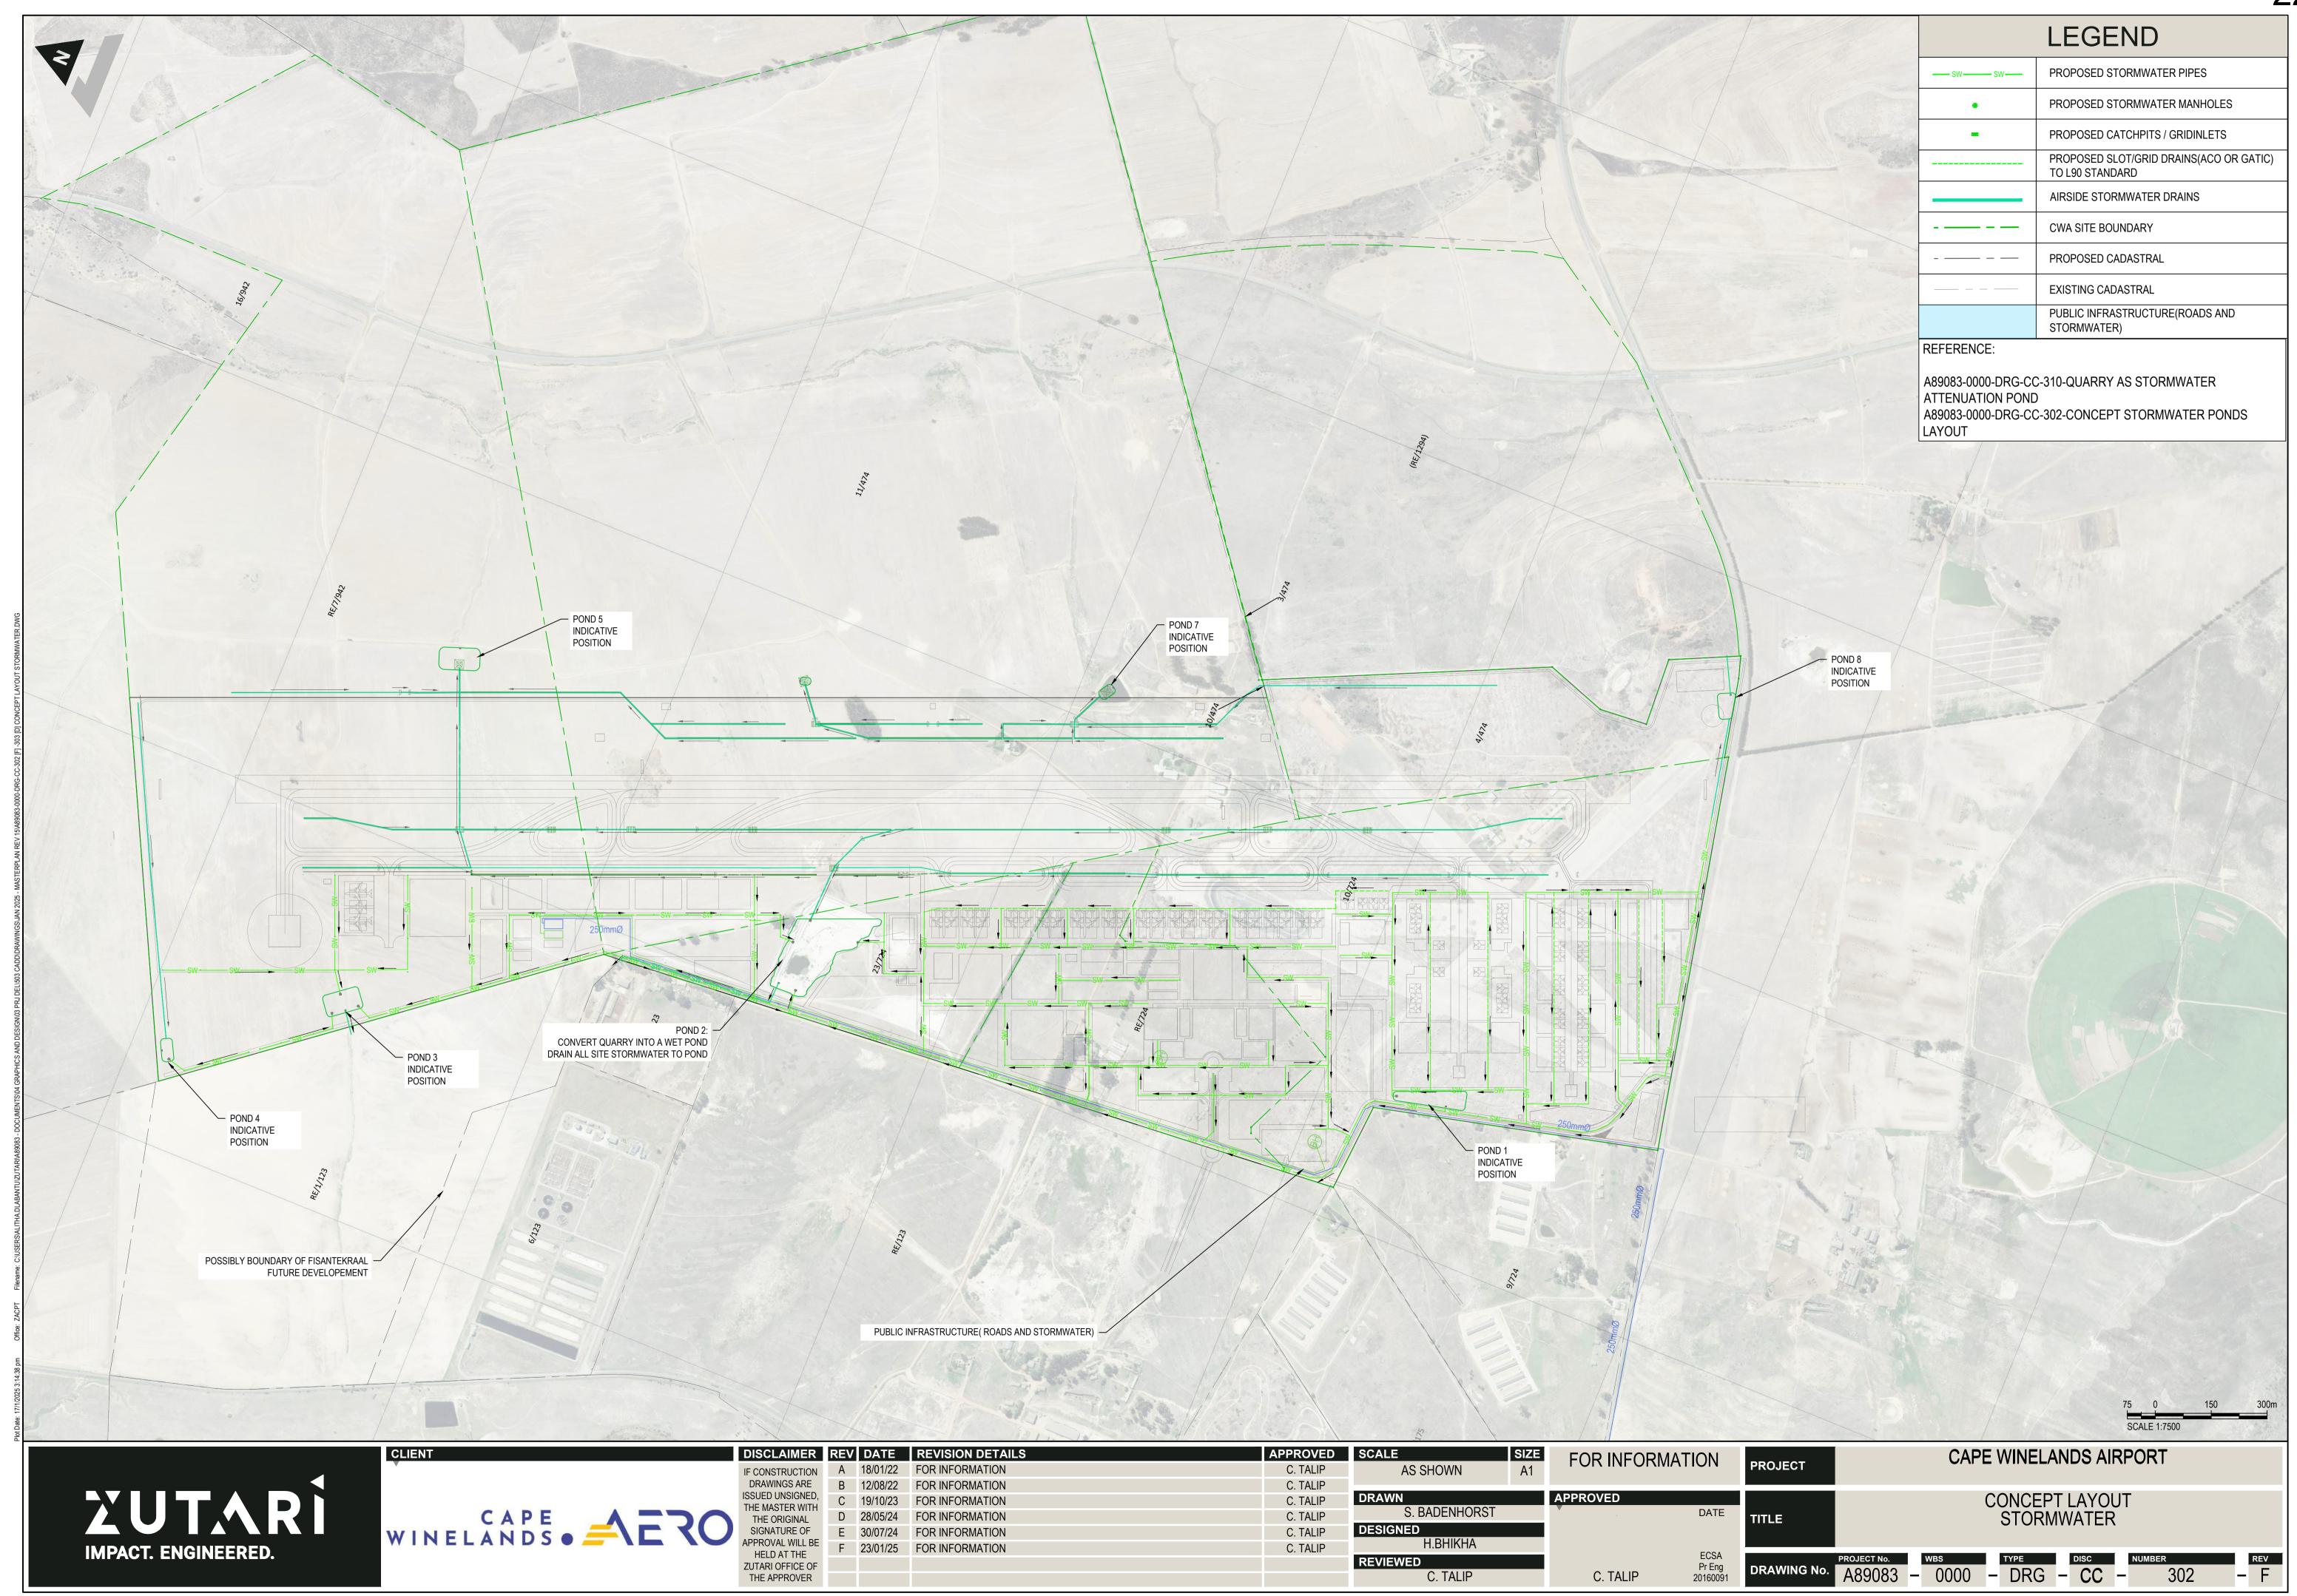


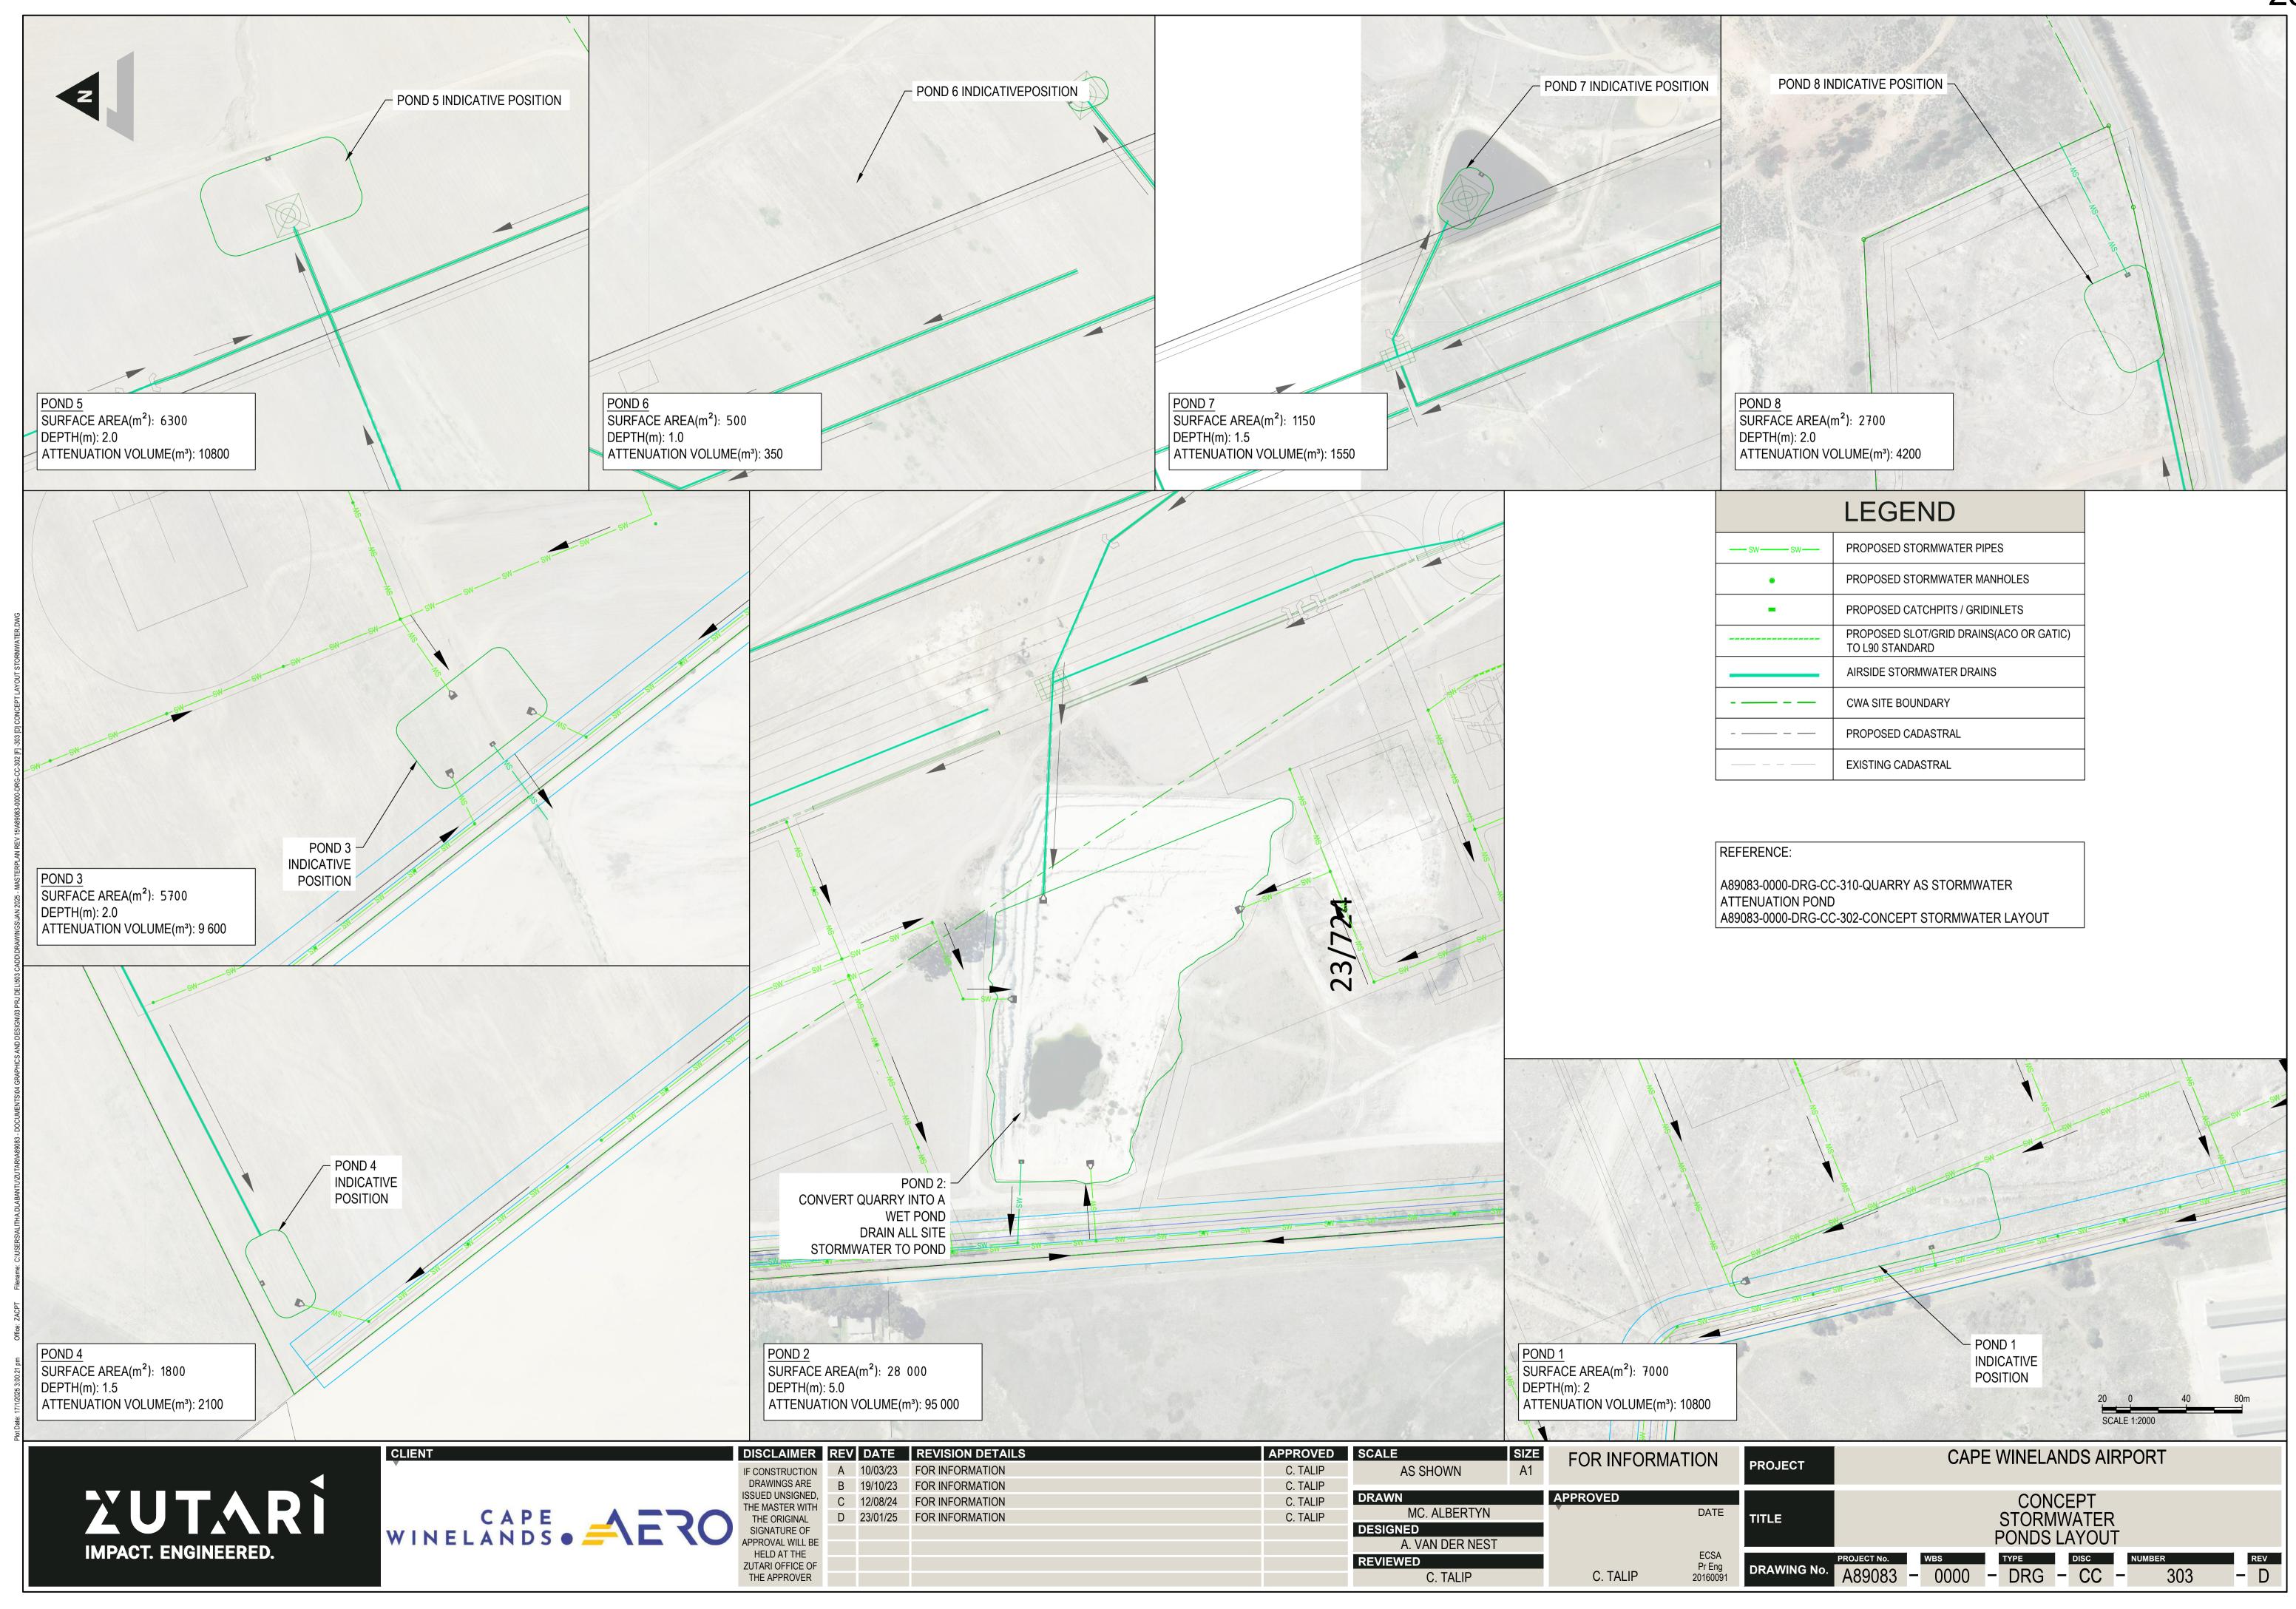


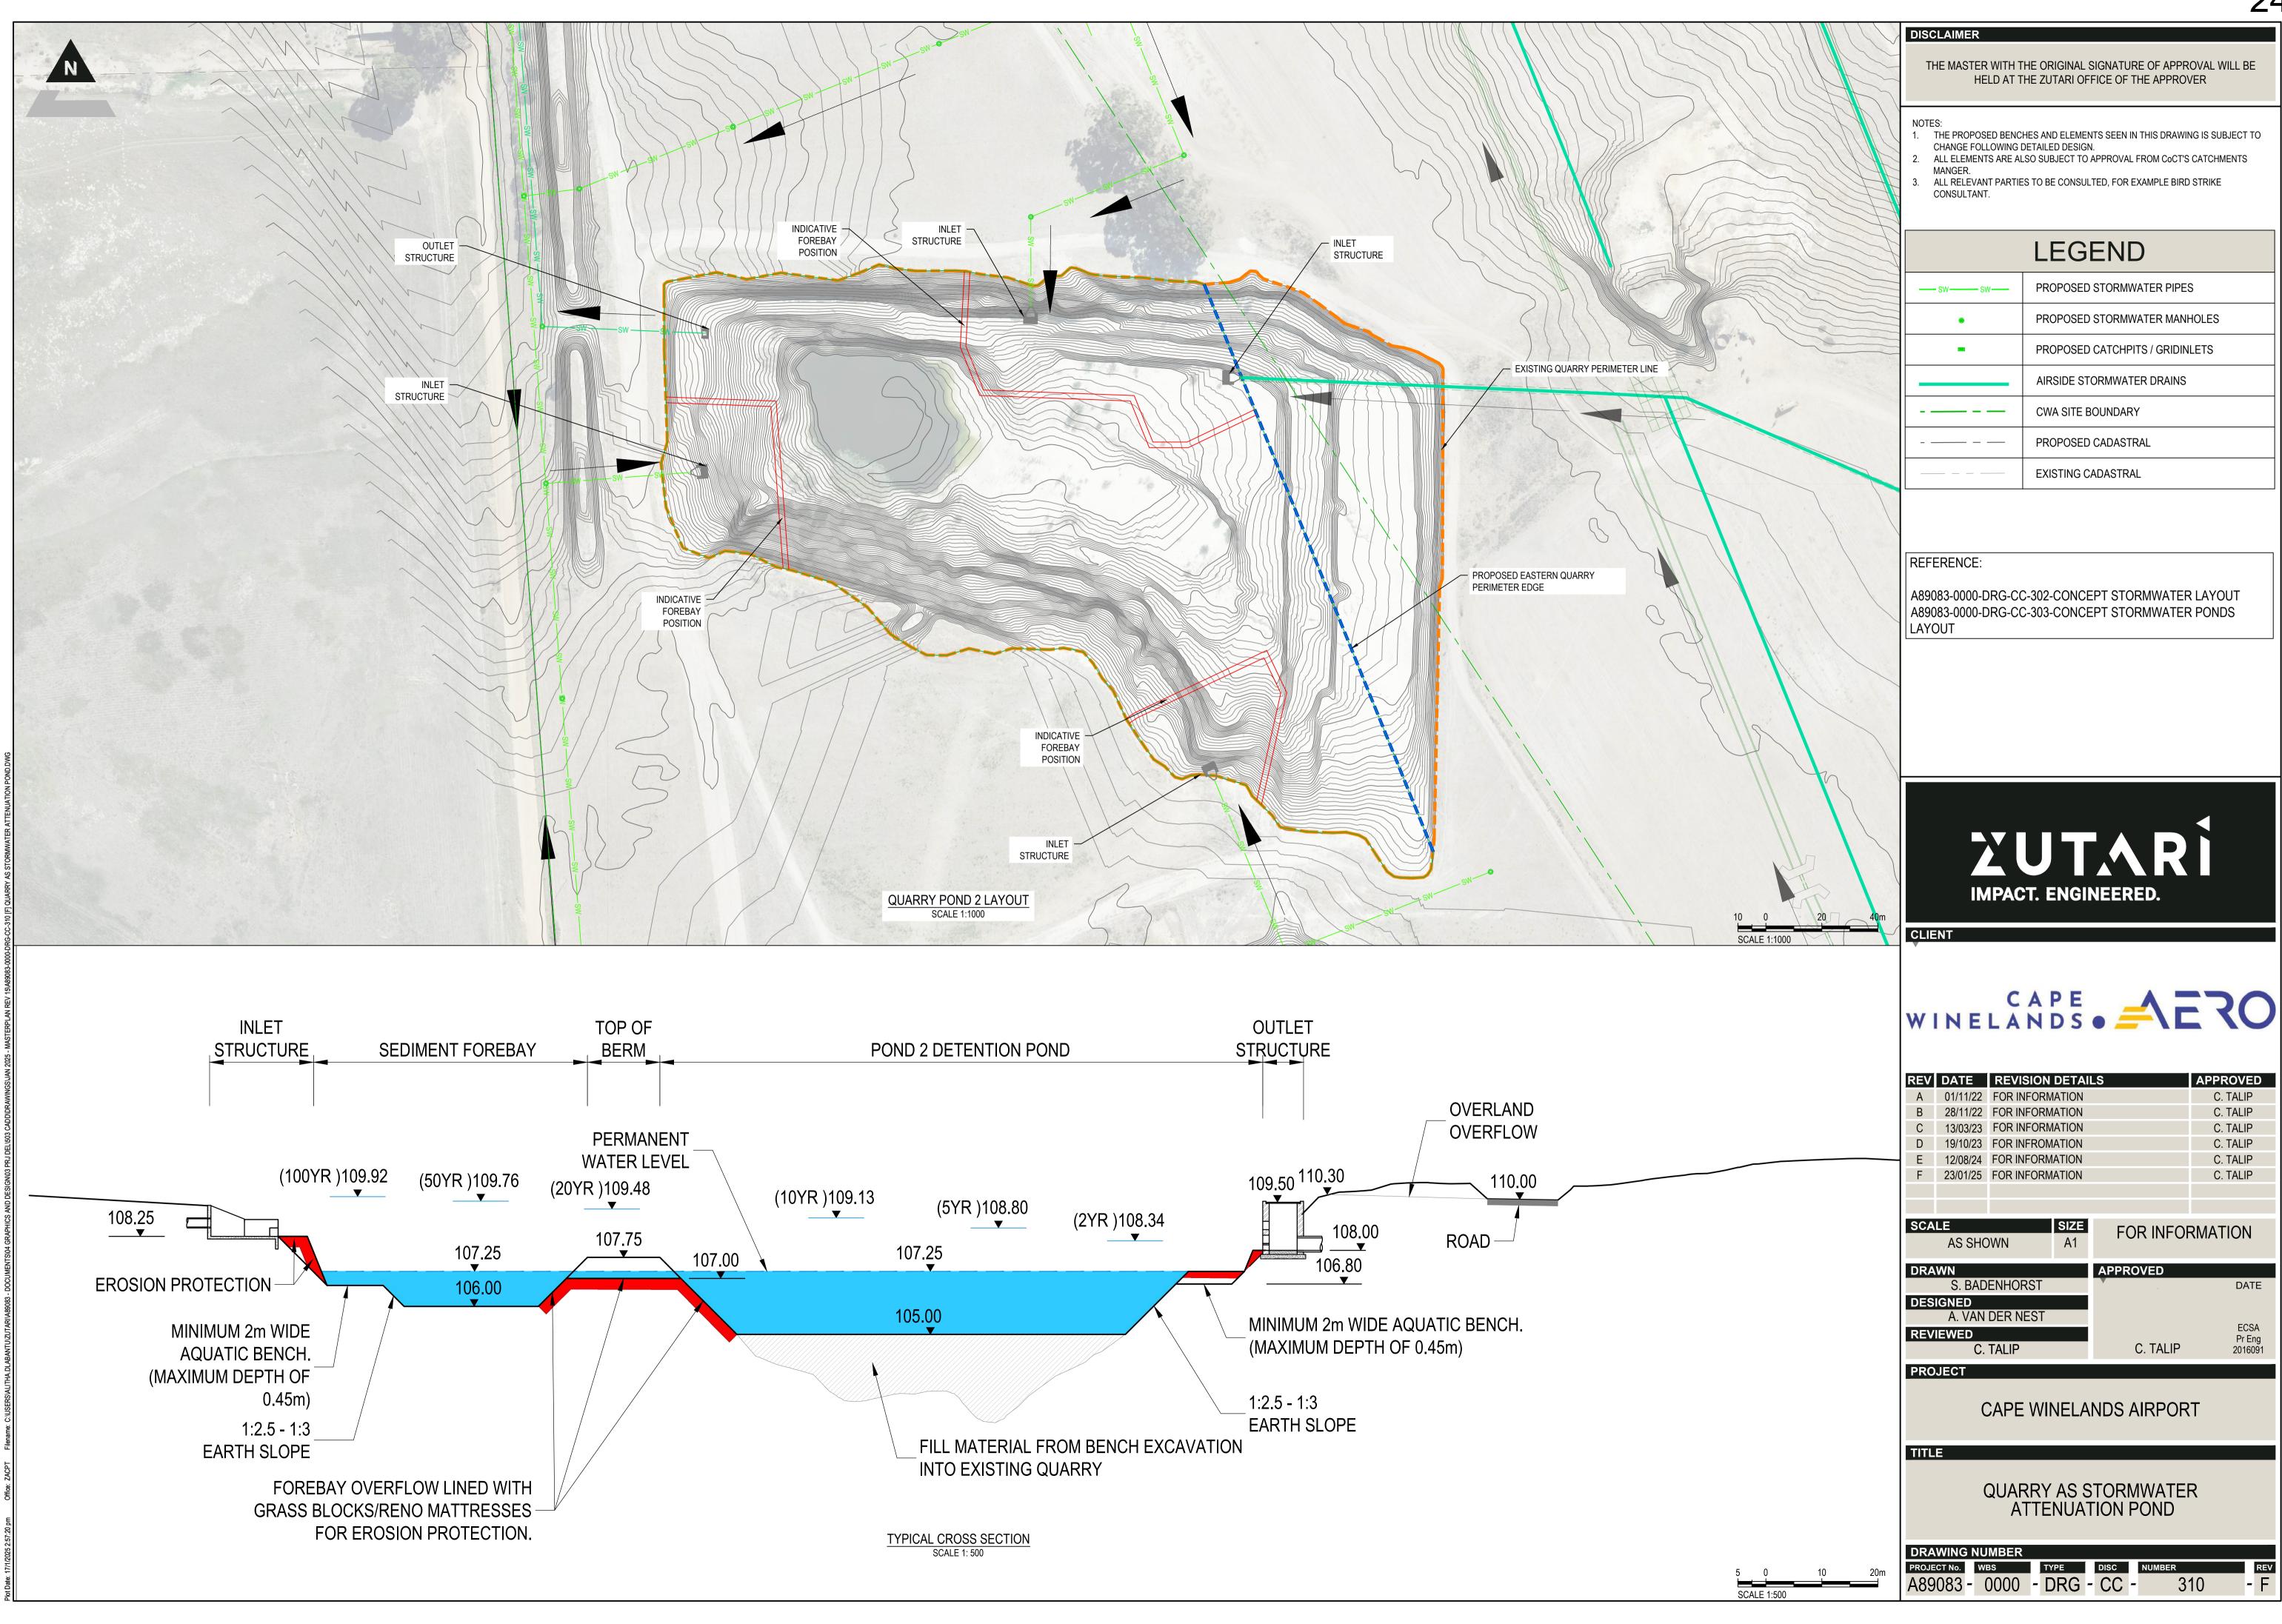


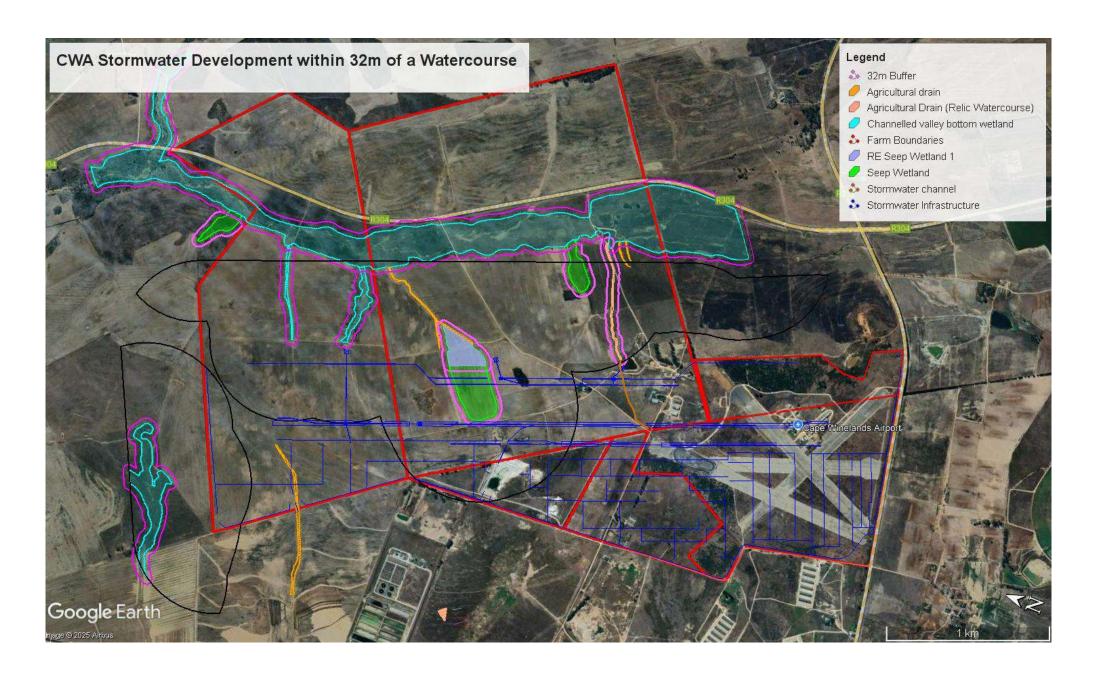

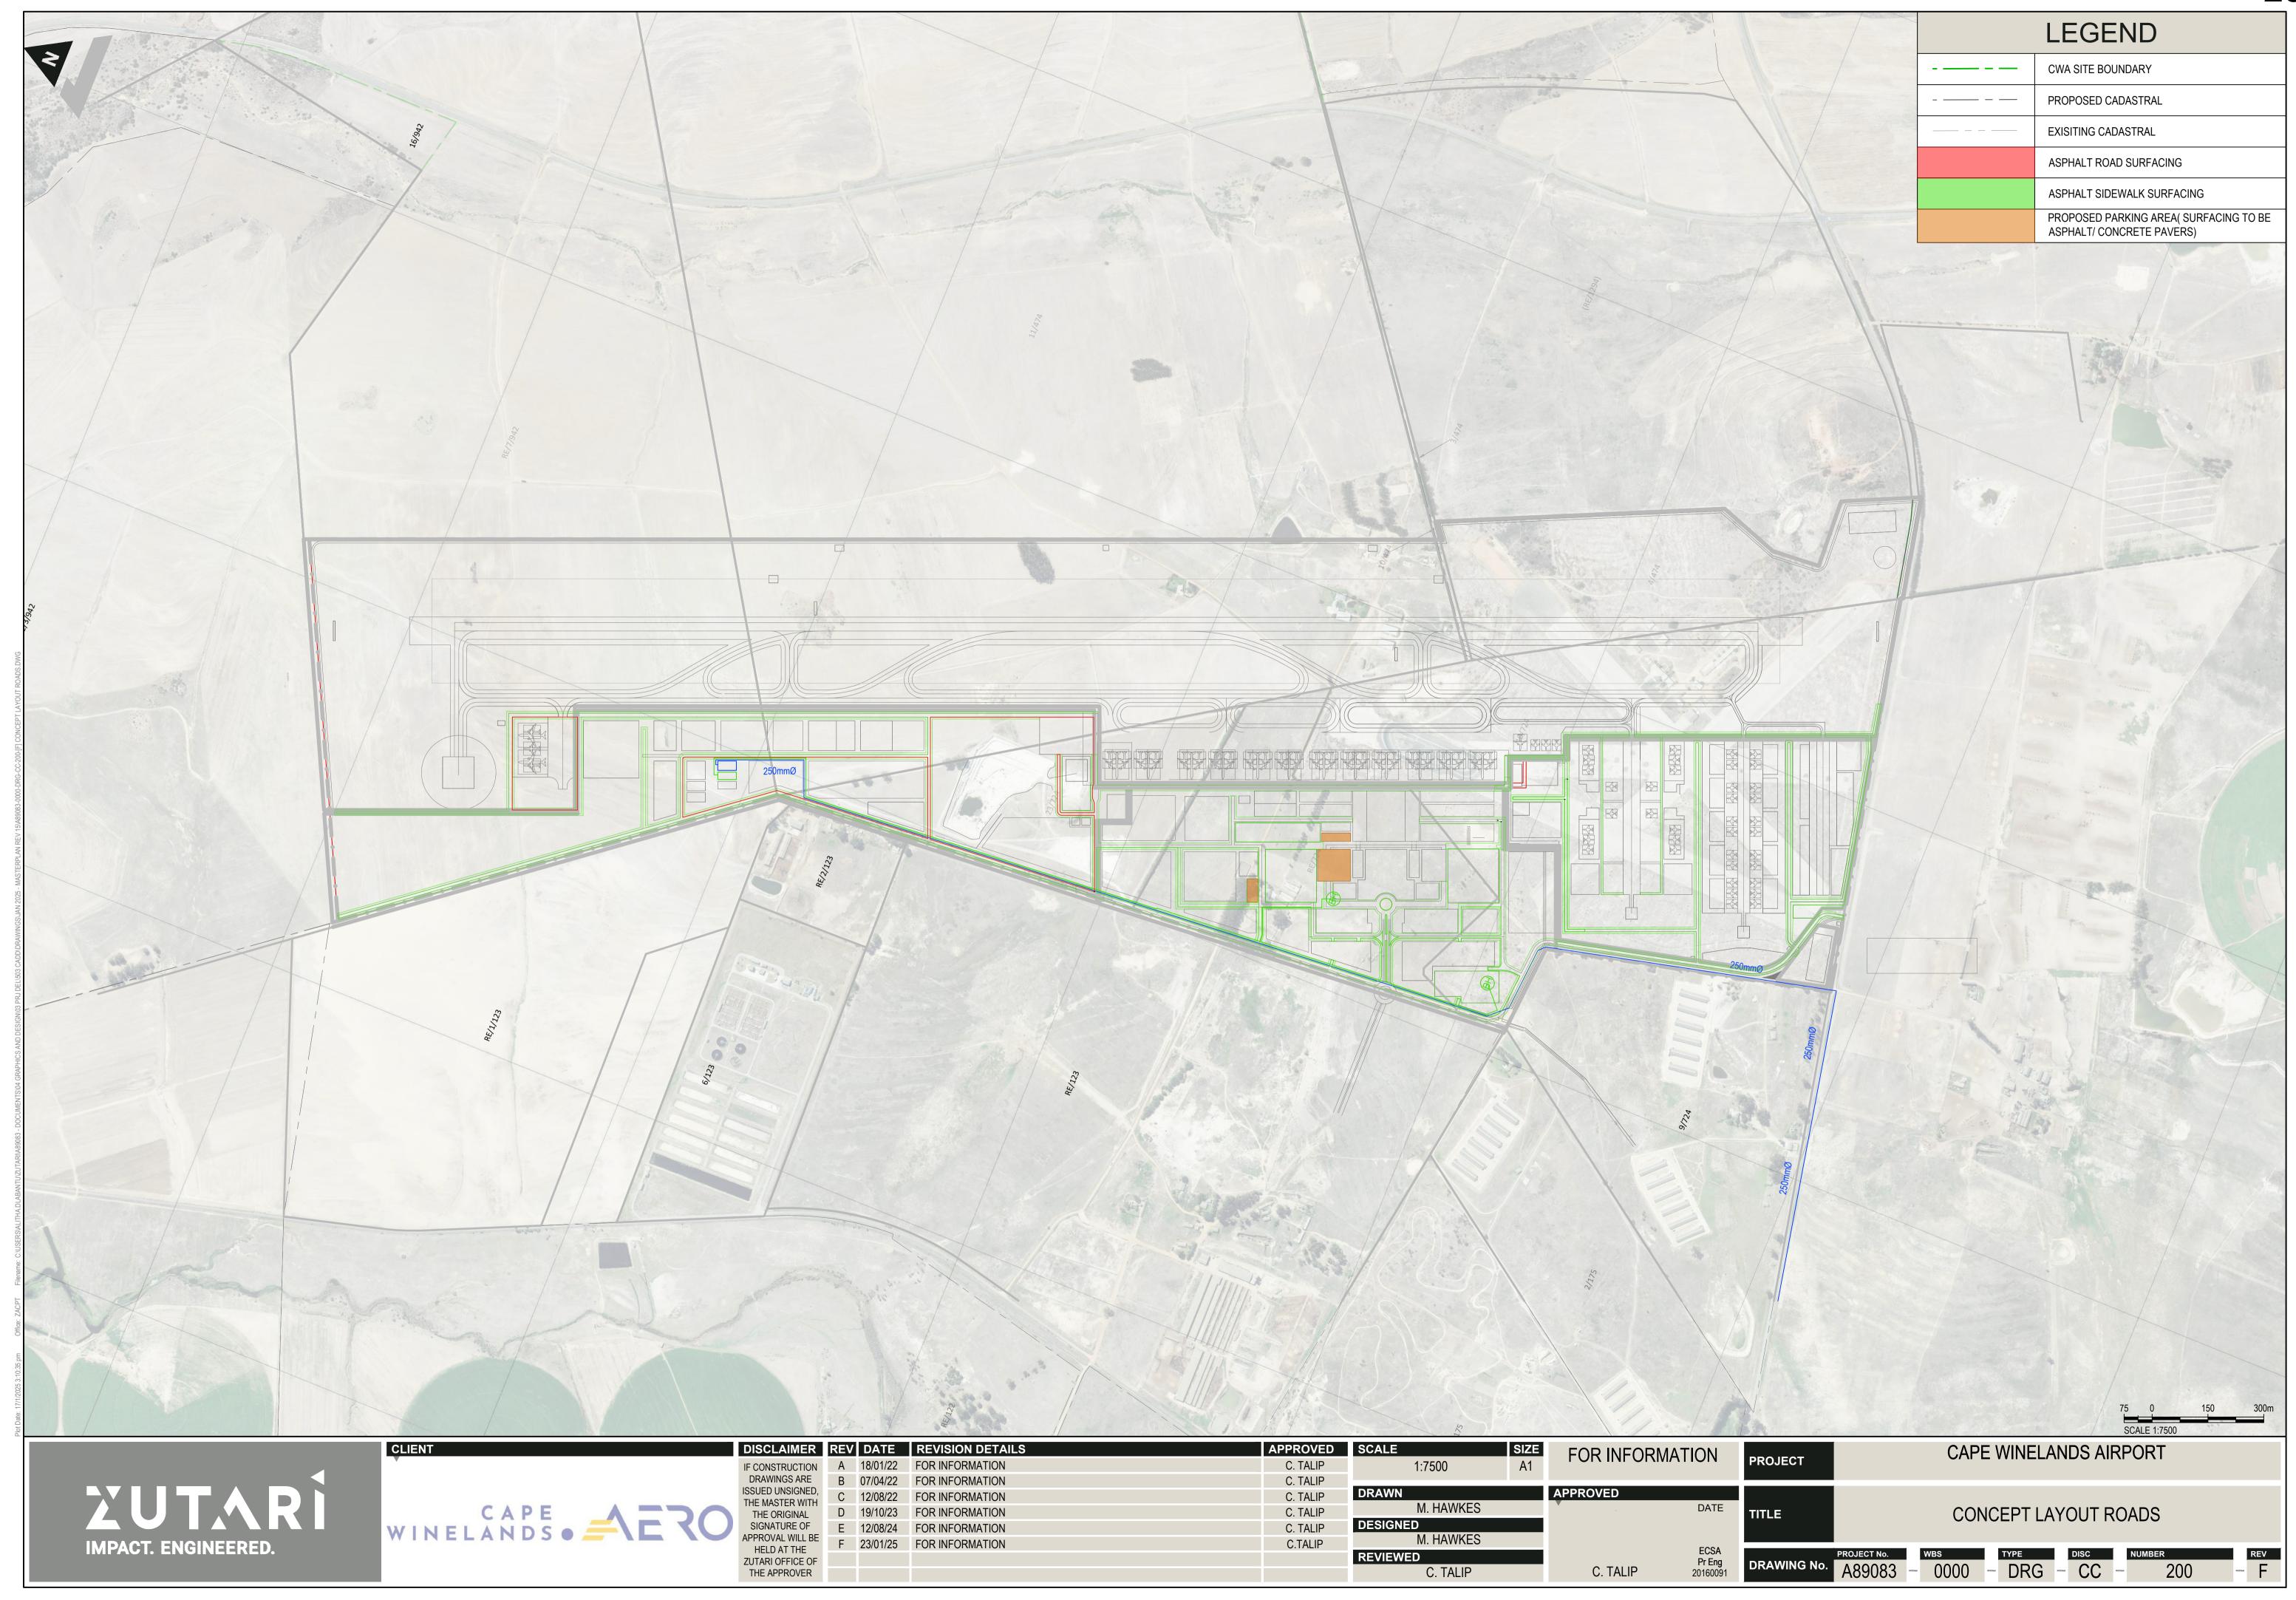

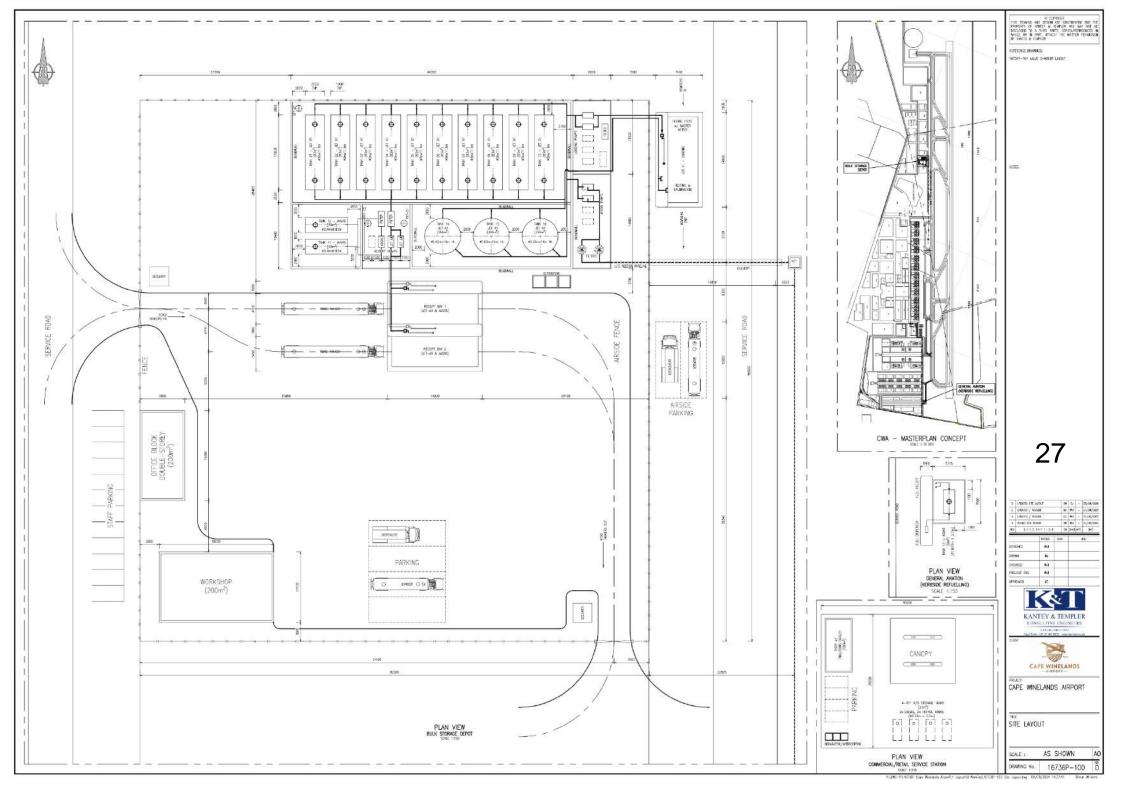


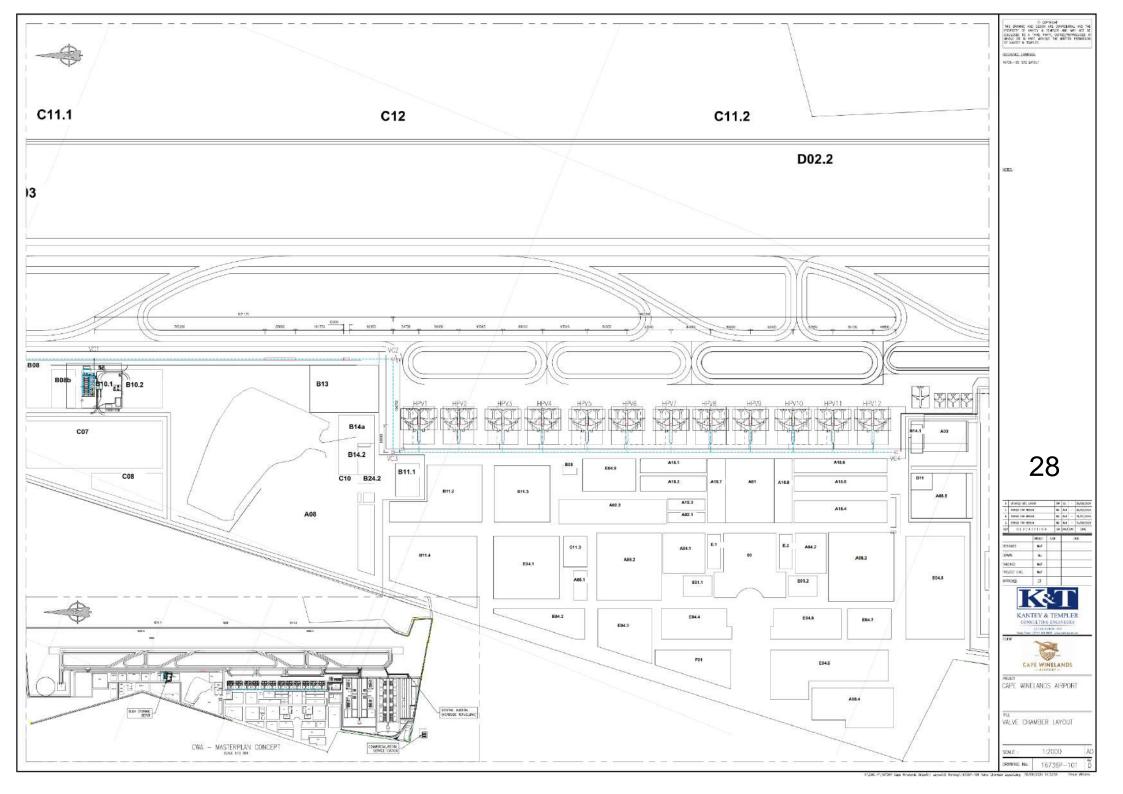

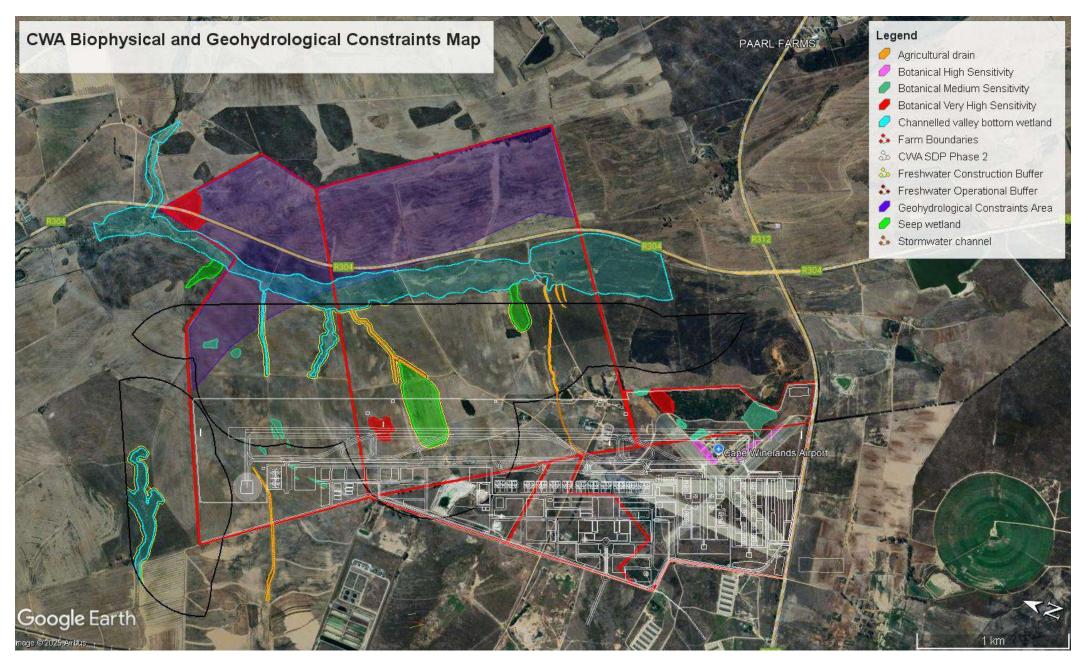

30b



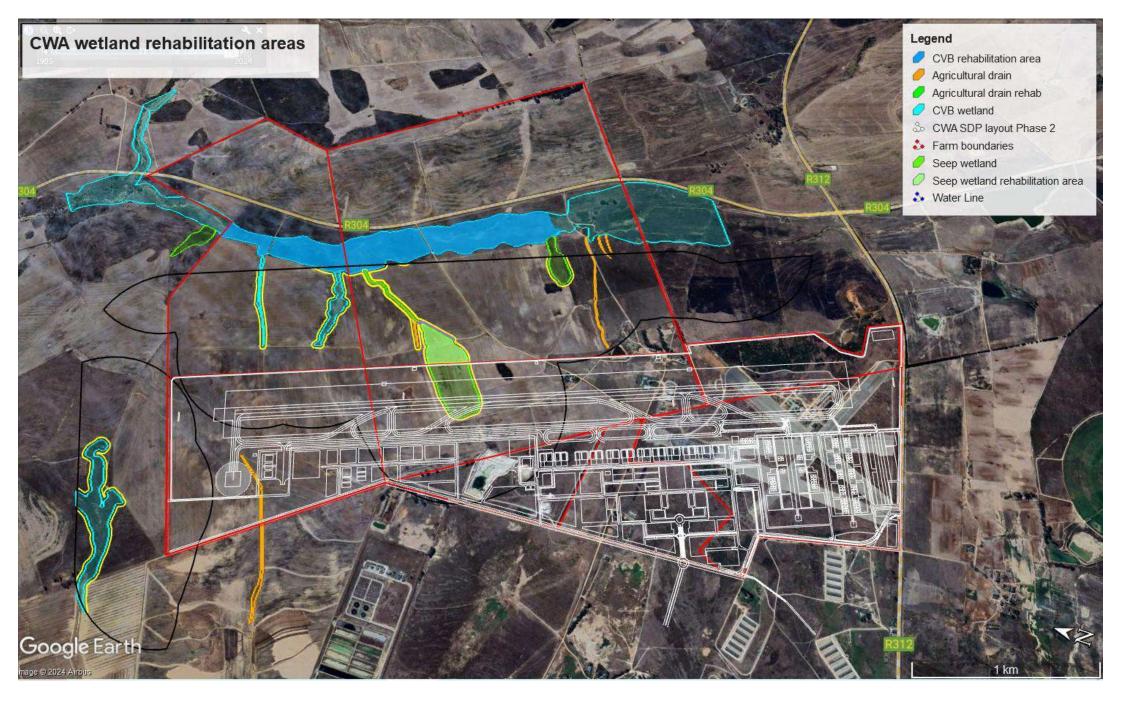

Coordinates along route of linear development (1 to 41 along Primary Runway 01-19; 42 to 50 along Secondary Runway 14-32)

Coordinate nr	Lattitude	Longitude		
Primary Runway 01-19				
1	33°44'22.90"S	18°43'48.02"E		
2	33°44'25.92"S	18°43'49.36"E		
3	33°44'28.96"S	18°43'50.90"E		
4	33°44'32.12"S	18°43'52.28"E		
5	33°44'35.33"S	18°43'53.74"E		
6	33°44'38.47"S	18°43'55.44"E		
7	33°44'41.62"S	18°43'57.03"E		
8	33°44'44.64"S	18°43'58.62"E		
9	33°44'47.81"S	18°44'0.34"E		
10	33°44'50.96"S	18°44'1.93"E		
11	33°44'54.08"S	18°44'3.62"E		
12	33°44'57.35"S	18°44'5.11"E		
13	33°45'0.51"S	18°44'6.65"E		
14	33°45'3.66"S	18°44'8.24"E		
15	33°45'6.80"S	18°44'9.87"E		
16	33°45'9.91"S	18°44'11.24"E		
17	33°45'12.99"S	18°44'12.79"E		
18	33°45'16.00"S	18°44'14.45"E		
19	33°45'19.03"S	18°44'15.98"E		
20	33°45'22.20"S	18°44'17.57"E		
21	33°45'25.40"S	18°44'19.03"E		
22	33°45'28.58"S	18°44'20.79"E		
23	33°45'31.87"S	18°44'22.03"E		
24	33°45'34.93"S	18°44'23.58"E		
25	33°45'37.85"S	18°44'25.10"E		
26	33°45'40.85"S	18°44'26.47"E		
27	33°45'43.87"S	18°44'28.01"E		
28	33°45'47.02"S	18°44'29.30"E		
29	33°45'50.16"S	18°44'30.87"E		
30	33°45'53.23"S	18°44'32.41"E		
31	33°45'56.28"S	18°44'33.83"E		
32	33°45'59.34"S	18°44'35.37"E		
33	33°46'2.41"S	18°44'36.83"E		
34	33°46'5.42"S	18°44'38.36"E		
35	33°46'8.50"S	18°44'39.79"E		
36	33°46'11.56"S	18°44'41.20"E		
37	33°46'14.64"S	18°44'42.57"E		
38	33°46'17.64"S	18°44'44.00"E		
39	33°46'21.03"S	18°44'44.58"E		
40	33°46'24.09"S	18°44'45.98"E		
41	33°46'26.05"S	18°44'46.98"E		
Secondary Runway 14-32				
42	33°46'23.87"S	18°44'39.00"E		
43	33°46'22.66"S	18°44'35.35"E		
44	33°46'21.15"S	18°44'31.93"E		
45	33°46'19.79"S	18°44'28.40"E		
46	33°46'18.59"S	18°44'24.86"E		
47	33°46'17.21"S	18°44'21.29"E		
48	33°46'15.82"S	18°44'17.74"E		
49	33°46'14.33"S	18°44'14.35"E		
50	33°46'12.79"S	18°44'10.11"E		



Figure 1: Coordinates 1 to 15 along Primary Runway 01-19

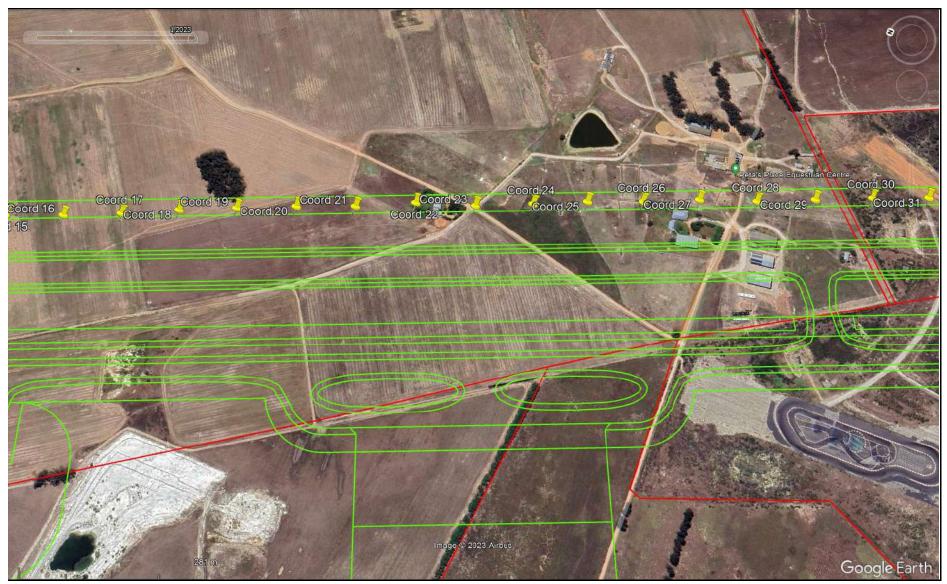


Figure 2: Coordinates 16 to 31 along Primary Runway 01-19

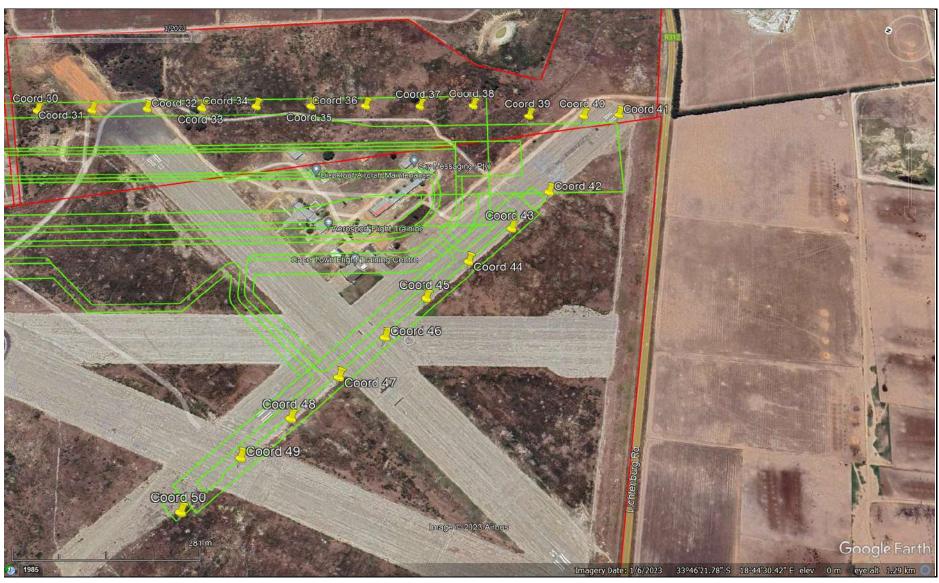


Figure 3: Coordinates 30 to 41 along Primary Runway 01-19 and Coordinates 42 to 50 along Secondary Runway 14-32